# Art Warehouse Renovation

Revision Schedule Number Description 8/21/ 2015 Bldg. Dept. comments

313 NE 3rd Street, Delray Beach, Florida 33444



## **ARCHITECT**

#### **CURRIE SOWARDS AGUILA ARCHITECTS**

185 NE 4th Avenue, Suite 101 Delray Beach, FL 33483 TEL: 561-276-4951 FAX: 561-243-8184

## **STRUCTURAL ENGINEER:**

#### McCarthy and associates

601 North Congress Avenue Suite 106A Delray Beach, Florida 33483 TEL: 561 921-0338 FAX: 561 921-0340

## **M.E.P. ENGINEER:**

#### THOMPSON AND YOUNGROSS ENGINEERING **CONSULTANTS**

902 CLINT MOORE ROAD, SUITE 142 BOCA RATON, FLORIDA 33487 TEL: 561 274-0200 FAX: 561 274-0222

## **CIVIL ENGINEER:**

#### **ENVIRODESIGN ASSOCIATES, INC.**

298 PINEAPPLE GROVE WAY DELRAY BEACH, FLORIDA 33444 TEL: 561 274-6500 FAX: 561 274-8558

SURVEY

## **LANDSCAPE ARCHITECT:**

#### DAVE BODKER LANDSCAPE ARCHITECTURE

SPECIFICATIONS, DETAILS, NOTES

601 NORTH CONGRESS AVENUE SUITE 105A DELRAY BEACH, FLORIDA 33445 TEL: 561 276-6311 FAX: 561 276-3869

PLANTING PLAN

IRRIGATION PLAN

LANDSCAPE

## **DRAWING LIST**

HEET#	SHEET NAME
LS1.00	GENERAL NOTES/ LEGENDS/ BLDG DATA
LS1.01	FIRST FLOOR LIFE SAFETY PLAN
LS1.02	SECOND FLOOR LIFE SAFETY PLAN
EX-A1.01	EXISTING SITE PLAN
EX-A2.01	EXISTING FLOOR PLAN
EX-A3.01	EXISTING EXTERIOR ELEVATIONS
D1.01	DEMOLITION PLAN
A1.01	SITE PLAN
A1.02	SITE DETAILS
A1.04	ENLARGED STAIR AND RAMP PLANS
A2.01	FIRST FLOOR PLAN-DIMENSIONAL
A2.02	FIRST FLOOR PLAN- NOTATIONAL
A2.03	SECOND FLOOR PLAN DIMENSIONAL
A2.04	SECOND FLOOR PLAN- NOTATIONAL
A2.05	ROOF PLAN
A3.01	ELEVATIONS
A3.02	ELEVATIONS
A4.01	ENLARGED PLANS
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A4.03	ENLARGED PLANS
A4.04	ENLARGED PLANS
A5.01	INTERIOR ELEVATION
A6.01	REFLECTED CEILING PLAN
A6.02	REFLECTED CEILING PLAN
A7.01	SECTIONS
A7.02	SECTIONS
A7.03	SECTIONS
A7.04	SECTIONS
A8.01	WALL TYPES
A8.02	DETAILS
A8.03	LOUVER DETAILS
A7.03 A7.04 A8.01 A8.02	SECTIONS SECTIONS WALL TYPES DETAILS

WINDOW DETAILS

CASEWORK DETAILS

DOOR SCHEDULE &

**DETAILS** 

FINISH PLAN

## STRUCTURAL

S0.1	STRUCTURAL SPECIFICATIONS	
S0.2	STRUCTURAL SPECIFICATIONS & WIND CHARTS	
S1.0	FOUNDATION PLAN	
S2.0	2ND FLOOR FRAMING PLAN	
S3.0	UPPER ROOF FRAMING PLAN	

#### ES1.1 E-0.1 E-1.1 E-1.2 E-2.1 E-2.2 E-3.1 E-4.1

FIRST FLOOR PLAN MECHANICAL

SECOND FLOOR PLAN MECHANICAL

M-1.1 M-1.2


M-2.1	MECHANICAL DE LAILS
PLUMBING	
P-0.1 P-1.1 P-1.2 P-2.1	PLUMBING NOTES FIRST FLOOR PLAN PLUMBING SECOND FLOOR PLAN PLUMBING PLUMBING ISOMETRIC DIAGRAMS

MECHANICAL NOTES

#### FIRE PROTECTION

	LOCATION		
FS-1.2	SECOND FLOOR PLAN FIRE SPRINKLER	FA-1.2	SECOND FLOOR FIRE ALARM F
FS-1.1	FIRST FLOOR PLAN FIRE SPRINKLER	FA-1.1	FIRST FLOOR FIRE ALARM PLA
FS-0.1	FIRE SPRINKLER NOTES LEGEND & SCHEDULE	FA-0.1	FIRE ALARM NOTES & LEGEND

# OF SITE 313 NE 3rd Street, Delray Bch., FI 33444

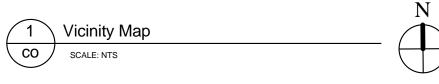

#### **ELECTRICAL**

.1	SITE PHOTO METRICS PLAN	1 OF 1	BOUNDARY & TOPOGRAPHIC SURVEY
1	ELECTRICAL NOTES		
1	FIRST FLOOR PLAN ELECTRICAL	CIVIL	
2	SECOND FLOOR PLAN ELECTRICAL	· · · · · ·	
1	FIRST FLOOR LIGHTING PLAN	1 OF 6	PAVING & DRAINAGE PLAN
2	SECOND FLOOR LIGHTING PLAN	2 OF 6	PAVING & DRAINAGE DETAILS
1	ELECTRICAL RISER DIAGRAM & SCHEDULES	3 OF 6	PAVING & DRAINAGE DETAILS
1	ELECTRICAL DETAILS	4 OF 6	PAVING & DRAINAGE DETAILS
		5 OF 6	WATER & WASTEWATER DETAILS
		· ·	· · · · · · · · · · · · · · · · · · ·

## **MECHANICAL**

M-2.1	MECHANICAL DETAILS
PLUMBING	
P-0.1	PLUMBING NOTES

## PLUMBING DETAILS P-3.1

#### FIRE ALARM

۸ ۸ 1	FIRE ALARM NOTES & LEGEND
<b>4-0.1</b>	FIRE ALARIVI NOTES & LEGEND
<b>∖-1.1</b>	FIRST FLOOR FIRE ALARM PLAN
<del>۹</del> -1.2	SECOND FLOOR FIRE ALARM PLAN




POLLUTION PREVENTION PLAN


**CRA OFFICIALS** CHAIRMAN VICE-CHAIR FIRST VICE-CHAIR **TREASURER** COMMISSIONER COMMISSIONER COMMISSIONER COMMISSIONER


HERMAN STEVENS ANNETTE GRAY **CATHY BALESTRIERE WILLIAM BRANNING** JOSEPH BERNADEL REGINALD A. COX PAUL ZACKS CATHY BALESTRIERE



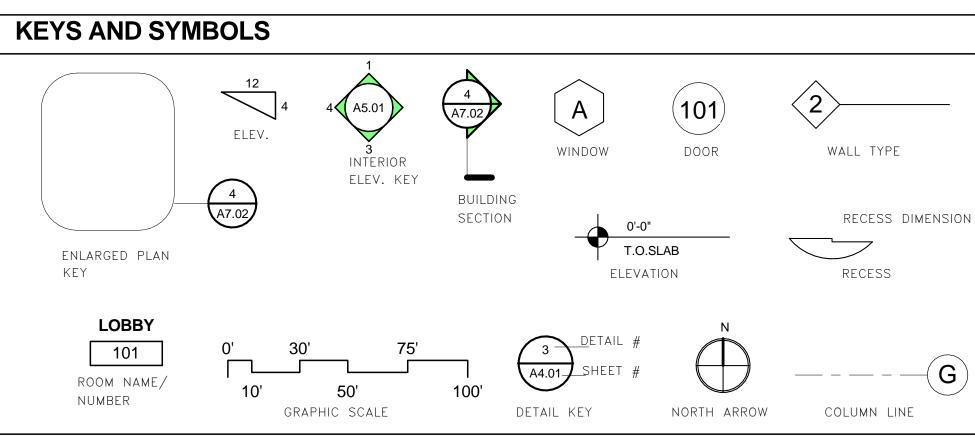

DETAIL KEY	NORTH ARROW COLUMN LINE
ABBREVIA	ATIONS
@	АТ
4.B.	ANCHOR BOLT
ACT.	ACOUSTICAL
ALT.	ALTERNATE
ALUM.	ALUMINUM
ARCH.	ARCHITECTURAL
BD.	BOARD
BLDG.	BUILDING
3.0.	BOTTOM OF
CEIL./CLG	CEILING
C.J.	CONTROL JOINT
CL	CENTERLINE
CLO.	CLOSET
CMU	CONCRETE MASONRY UNIT
CONC.	CONCRETE
CONT.	CONTINUOUS
JUNI.	CONTINUOUS
D.F.	DRINKING FOUNTAIN
DIA.	DIAMETER
DIM.	DIMENSION
DN.	DOWN
D.S.	DOWN SPOUT
DWG.	DRAWING
EA.	EACH
EQ.	EQUAL
EXIST.	EXISTING
EXT.	EXTERIOR
F.D.	FLOOR DRAIN
F.E.C.	FIRE EXTING. CABINET
GA.	GAUGE
G.C.	GENERAL CONTRACTOR
GALV.	GALVANIZED
GYP. BD.	GYPSUM BOARD
JIF. DU.	GIFSUM BOARD
H.C.	HANDICAPPED
H.M.	HOLLOW METAL
1.141.	HOLLOW MILIAL
NSUL.	INSULATION
NT.	INTERIOR
_AV.	LAVATORY
MAX.	MAXIMUM
MEP	MECHANICAL, ELECTRICAL & PLUMBING
MIN.	MINIMUM
MISC.	MISCELLANEOUS
M.O.	MASONRY OPENING
	5. 2
N	NORTH
N.I.C.	NOT IN CONTRACT
v.T.S.	NOT TO SCALE
	HOT TO SOALL
O.C.	ON CENTER
O.D.	OUTSIDE DIAMETER
OPP.	OPPOSITE DIAMETER
VII.	OITOSIIL
PROV.	PROVIDED
PSF.	POUNDS PER SQUARE FOOT
PSI	POUNDS PER SQUARE INCH
<b>J</b> 1	TOORDS LEN SQUARE INCH
₹.	RADIUS
R.D.	ROOF DRAIN
REBAR	REINFORCING BARS
REQ.	REQUIRED
R.W.L.	RAIN WATER LEADER
R.O.W.	RIGHT OF WAY
s C	SOLID CORE
S.C.	
SPECS.	SPECIFICATIONS
Τ Ο	TOD OF
Γ.Ο.	TOP OF
ΓΥΡ.	TYPICAL
/ C T	VINIVI COMPOSITION THE
V.C.T.	VINYL COMPOSITION TILE
N /	WITH
W/ WD.	WITH WOOD

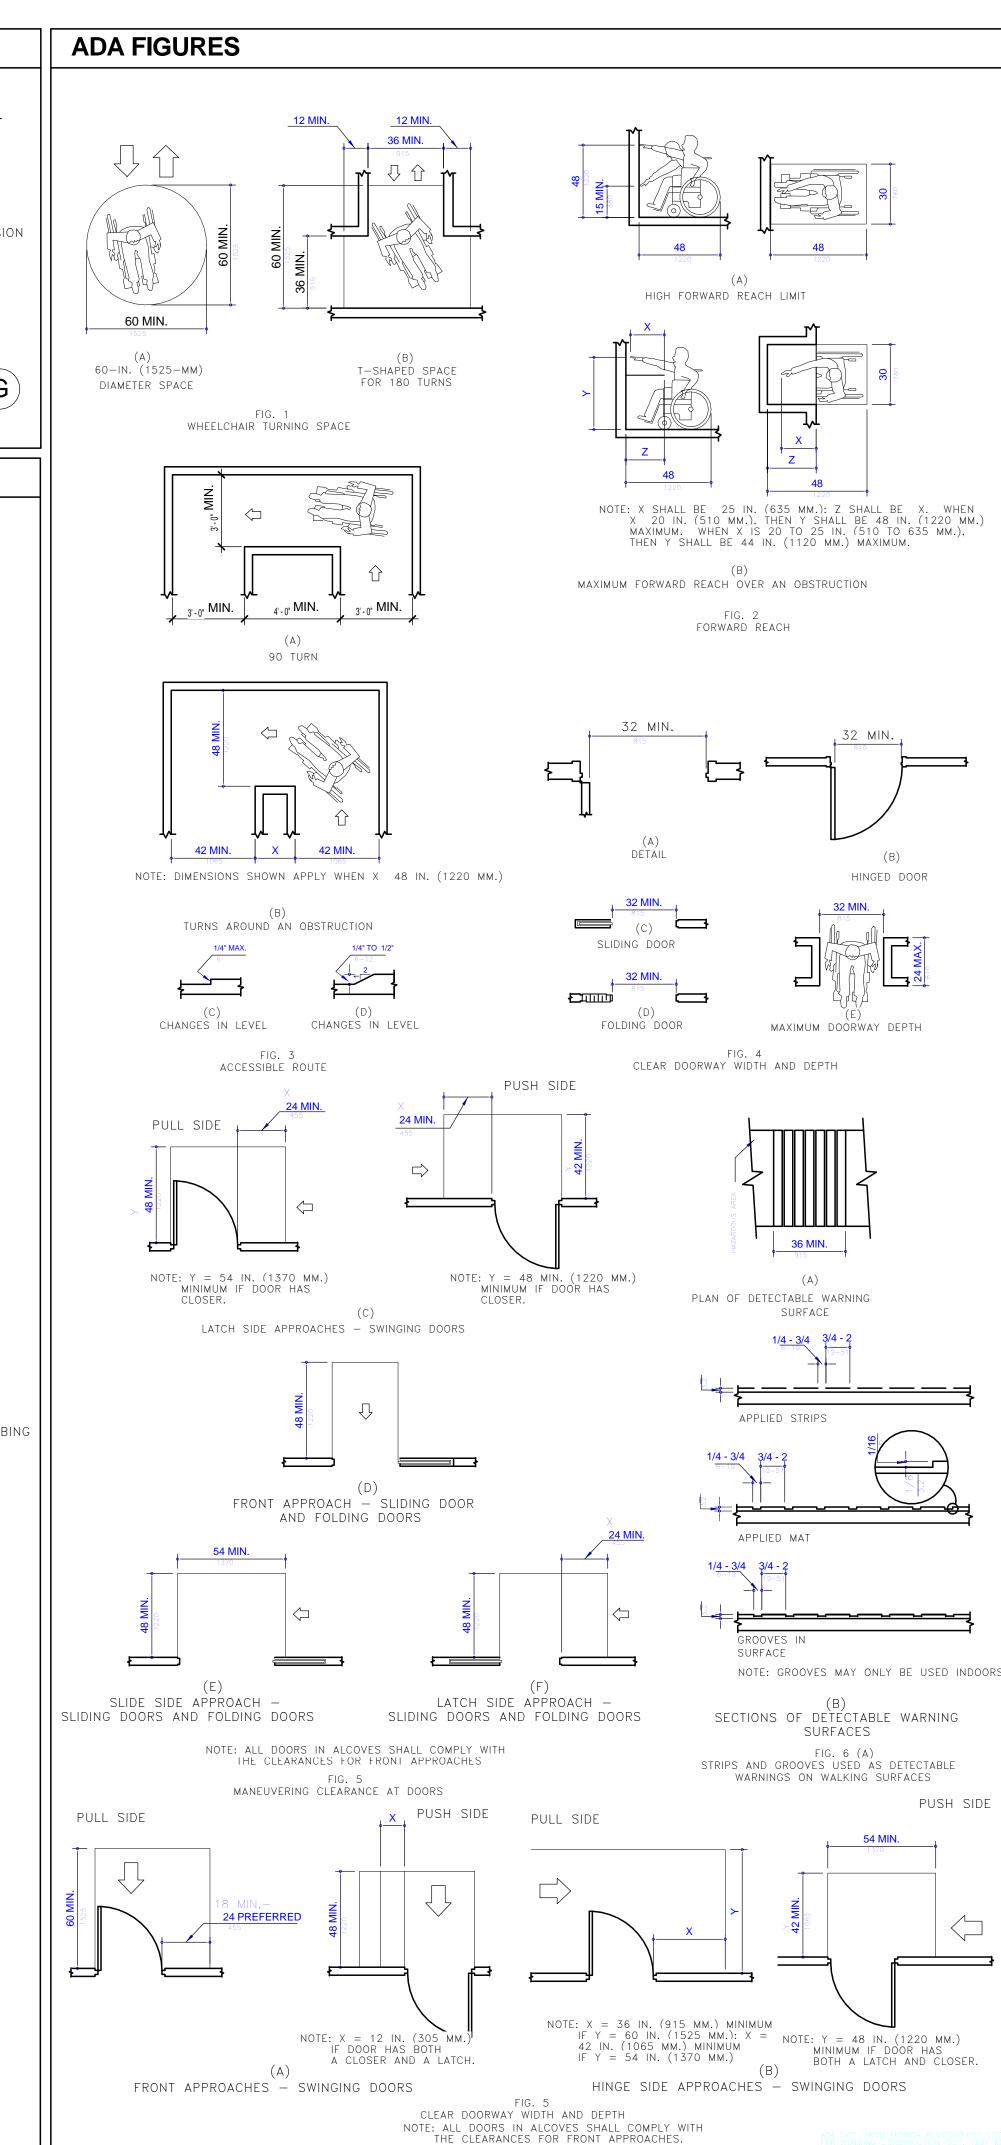

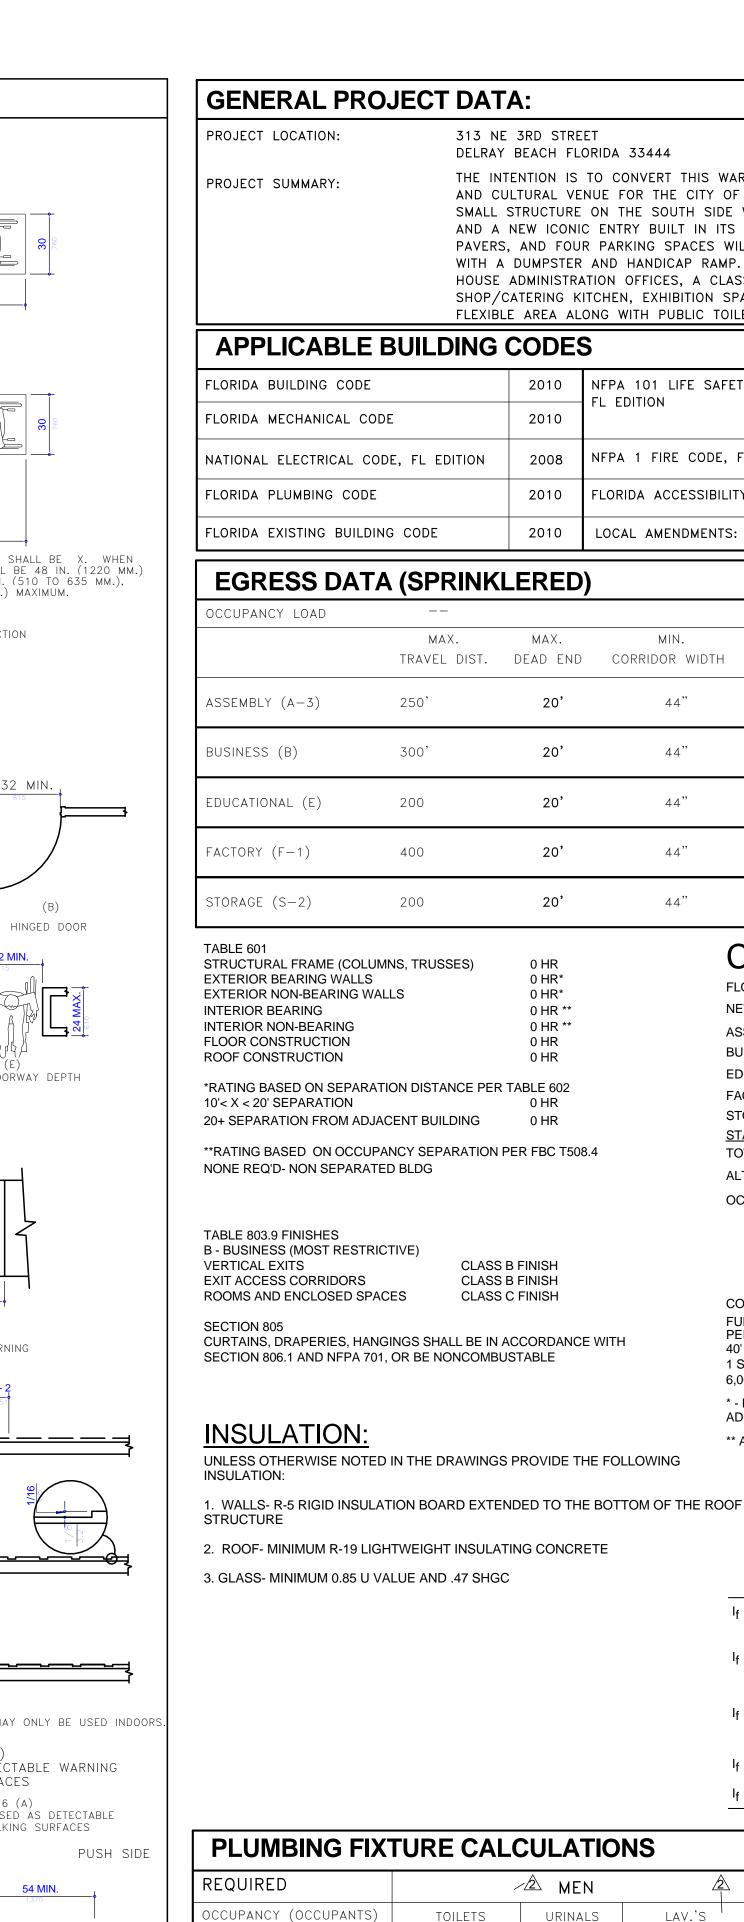

**GENERAL PROJECT DATA:** PROJECT LOCATION: 313 NE 3RD STREET DELRAY BEACH FLORIDA 33444 THE INTENTION IS TO CONVERT THIS WAREHOUSE TO AN ART PROJECT SUMMARY: AND CULTURAL VENUE FOR THE CITY OF DELRAY BEACH. THE SMALL STRUCTURE ON THE SOUTH SIDE WILL BE REMOVED AND A NEW ICONIC ENTRY BUILT IN ITS PLACE. BRICK PAVERS, AND FOUR PARKING SPACES WILL BE ADDED ALONG WITH A DUMPSTER AND HANDICAP RAMP. THE INTERIOR WILL HOUSE ADMINISTRATION OFFICES, A CLASS ROOM, COFFEE SHOP/CATERING KITCHEN, EXHIBITION SPACE, AND AN OPEN FLEXIBLE AREA ALONG WITH PUBLIC TOILETS AND STORAGE. **APPLICABLE BUILDING CODES** 2010 NFPA 101 LIFE SAFETY CODE, 2012 FL EDITION 2010 NFPA 1 FIRE CODE, FL 5TH EDITION 2012

FLORIDA BUILDING CODE FLORIDA MECHANICAL CODE 2008 NATIONAL ELECTRICAL CODE, FL EDITION FLORIDA PLUMBING CODE FLORIDA ACCESSIBILITY CODE 2012 LOCAL AMENDMENTS: --FLORIDA EXISTING BUILDING CODE 2010 **EGRESS DATA (SPRINKLERED)** 

MAX.

TRAVEL DIST. DEAD END CORRIDOR WIDTH

20'

20'

20'

20'

20'

0 HR\*

0 HR\*

0 HR \*

0 HR \*\* 0 HR

CLASS B FINISH

CLASS B FINISH CLASS C FINISH MIN.

44"

44"

44"

MAX.

250'

300'

200

400

200

TO THE BEST OF THE ARCHITECT'S OR ENGINEER'S KNOWLEDGE, THE PLANS AND SPECIFICATIONS COMPLY WITH THE APPLICABLE MINIMUM BUILDING CODES AND THE APPLICABLE FIRE-SAFETY STANDARDS AS DETERMINED BY THE LOCAL AUTHORITY IN ACCORDANCE WITH THIS SECTION AND 633 FLORIDA STATUES

## WALL FIRE RATING LEGEND

\_\_\_\_\_\_ 1 HR. FIRE RATED

THIS BUILDING IS NOT A THRESHOLD BUILDING PER FBC 2010 SEC. 202. A SPECIAL THRESHOLD INSPECTOR WILL BE RETAINED IF IT IS CLASSIFIED AS ONE BY THE BUILDING DEPT.

CURRIE	
COMMADDC	

SOWARDS **AGUILA** architects

Architecture, Planning, Interiors, & Sustainable Design AA26001584

185 NE 4TH AVENUE SUITE 101 DELRAY BEACH, FL 33483 T: (561) 276-4951 F: (561) 243-8184

E-MAIL: office@csa-architects.com ISSUED FOR : 3/05/2015

PERMIT 6/29/2015 CONSTRUCTION

SEAL

Art Warehouse Renovation

PROJECT TITLE

313 NE 3rd Street, Delray Beach, Florida 33444

DESCRIPTION 1 Bldg. Dept. comments 10/23/ 2 Bldg. Dept. comments

#### **CODE ANALYSIS:** ELODIDA BLIII DING CODE NEW BLIII DING

MIN. CLEAR

32"

32"

32"

32"

OPG. EXIT DOORS

FLORIDA BUILDING CODE -	NEW BUILDI	NG:	
NEW AREA :	1ST LVL.	2ND LVL.	TOTAL
ASSEMBLY	4,139	0	4,139 SF
BUSINESS	683	0	683 SF
EDUCATIONAL	376	0	376 SF
FACTORY	7,096	2,514	9,610 SF
STORAGE	910	68	978 SF
STAIRS/ELEVATOR/ LOBBY	209	775	984 SF
TOTALS	13,413	3,357	16,770 SF

MIN.

44"

44"

44"

STAIR WIDTH

ALTERATION LEVEL: 3

OCCUPANCY: MIXED USE: ASSEMBLY A-3 NON-SEPARATED BUSINESS (B) EDUCATIONAL (E) FACTORY (F-1) STORAGE (S-2)

CONSTRUCTION TYPE V(B) FULLY SPRINKLERED PER T503 40' MAX HEIGHT (BASED ON A-3 OCCUPANCY MOST RESTRICTIVE) 1 STORY MAX\* 6,000 S.F. PER FLOOR\*\*

\* - PER F.B.C. 504.2 - FULLY SPRINKLERED BUILDING ALLOWS A 1 STORY ADDITION, AND +20' IN HEIGHT TO T.503

\*\* AREA MODIFICATION CALCULATION

6,000 S.F. PER T503 (BASED ON A-3 OCCUPANCY MOST RESTRICTIVE) AREA MODIFICATION PER SEC 506

 $A_a = A_t + A_t I_f + A_t I_s$  $A_a = 6{,}000 + 6{,}000 \times 0.51 + 6{,}000 \times 2$  $A_a = 6,000 + 3,060 + 12,000$ 

A<sub>a</sub> = 19,060 S.F. ALLOWED SQUARE FOOTAGE

	-	
CAL	CULATION	I <sub>S</sub> CALCULATION
f =		TWO STORY SPRINKLERED $I_S = 2$
	390' - 10" 29.23	W = [340.93 X 30] + [49.9 X 24]
_	390' - 10" 504' - 5" - 0.25 <u>29.23</u> 30	390.93
; =	.525 .97	W = 29.23
= 0.9	51	

PLUMBING FIXTURE CALCULATIONS							
REQUIRED	/	∕ <u></u> MEN	MEN 🖄 🔅 WOM		MEN 🖄	DRK. FOUNT.	SERVICE
OCCUPANCY (OCCUPANTS)	TOILETS	URINALS	LAV.'S	TOILETS	LAV.'S	7	SINK
ASSEMBLY A-3 (562)	281/125 = 2.25		281/200 = 1.4	281/65 = 4.3	281/200 = 1.4	562/500 = 1.1	1
BUSINESS B (7)	4/25 = .16		4/40 = 0.1	4/40 = 0.1	4/40 = 0.1	7/100 = 0.07	
EDUCATIONAL E (8)	4/50 = 0.08		4/50 = 0.08	4/50 = 0.08	4/50 = 0.08	8/100 = 0.08	1
FACTORY F-1 (97)	49/100 = 0.49		49/100 = 0.49	49/100 = 0.49	49/100 = 0.49	97/400 = 0.24	1
STORAGE S-2 (2)	1/100 = 0.01		1/100 = 0.01	1/100 = 0.01	1/100 = 0.01	2/1000 = 0.02	1
TOTAL REQUIRED	<b>2</b> - 2.99		2.08	4.98	2.08	1.51	4
PROVIDED	2	1	3	5	4	2	23

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FILE NUMBER J:\100701 DELRAY CRA ART INCUBATOR\DRAWINGS\100701 -

DRAWING TITLE ☐ GENERAL NOTES/ LEGENDS/ BLDG > DATA

> 6/29/2015 100701

LIFE SAFETY KEY

# SF \_\_\_\_\_

OCCUPANT LOAD

**EGRESS DATA** 

COMMON PATH OF TRAVEL

FL. BC. 2010

MIN. CORRIDOR WIDTH

TRAVEL DISTANCE

MAX. DEAD END

EGRESS WIDTH

STAIR WIDTH

DOORS

NUMBER OF PERSONS EXITING

START POINT

EGRESS CAPACITY OF DOOR/STAIR

FEC SEMI-RECESSED FIRE EXTINGUISHER CABINET

EXIT SIGN (SEE ELECTRICAL PLANS)

DOOR EQUIPPED WITH PANIC HARDWARE

DOOR EQUIPPED WITH FIRE EXIT HARDWARE

REQ.

44" MIN.

32" MIN.

44" MIN.

OCCUPANCY TYPE

— SQUARE FOOTAGE

\_\_ SQUARE FOOTAGE/T1004.11 REQ'D SF. PER OCC.=OCCUPANT LOAD FOR

FL. BC. 2010

MIN/MAX


160' - 1" MAX.


38' - 7" MAX.

PROV.

48"

70" MIN.

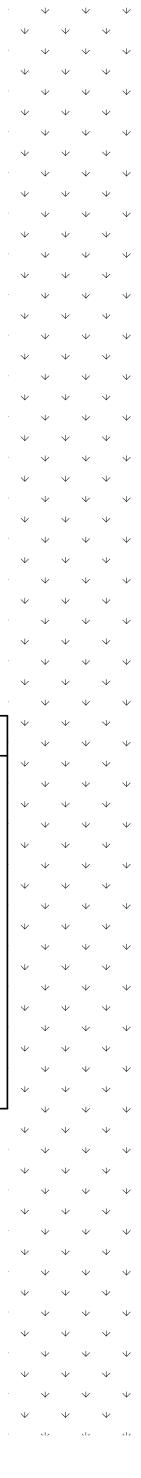

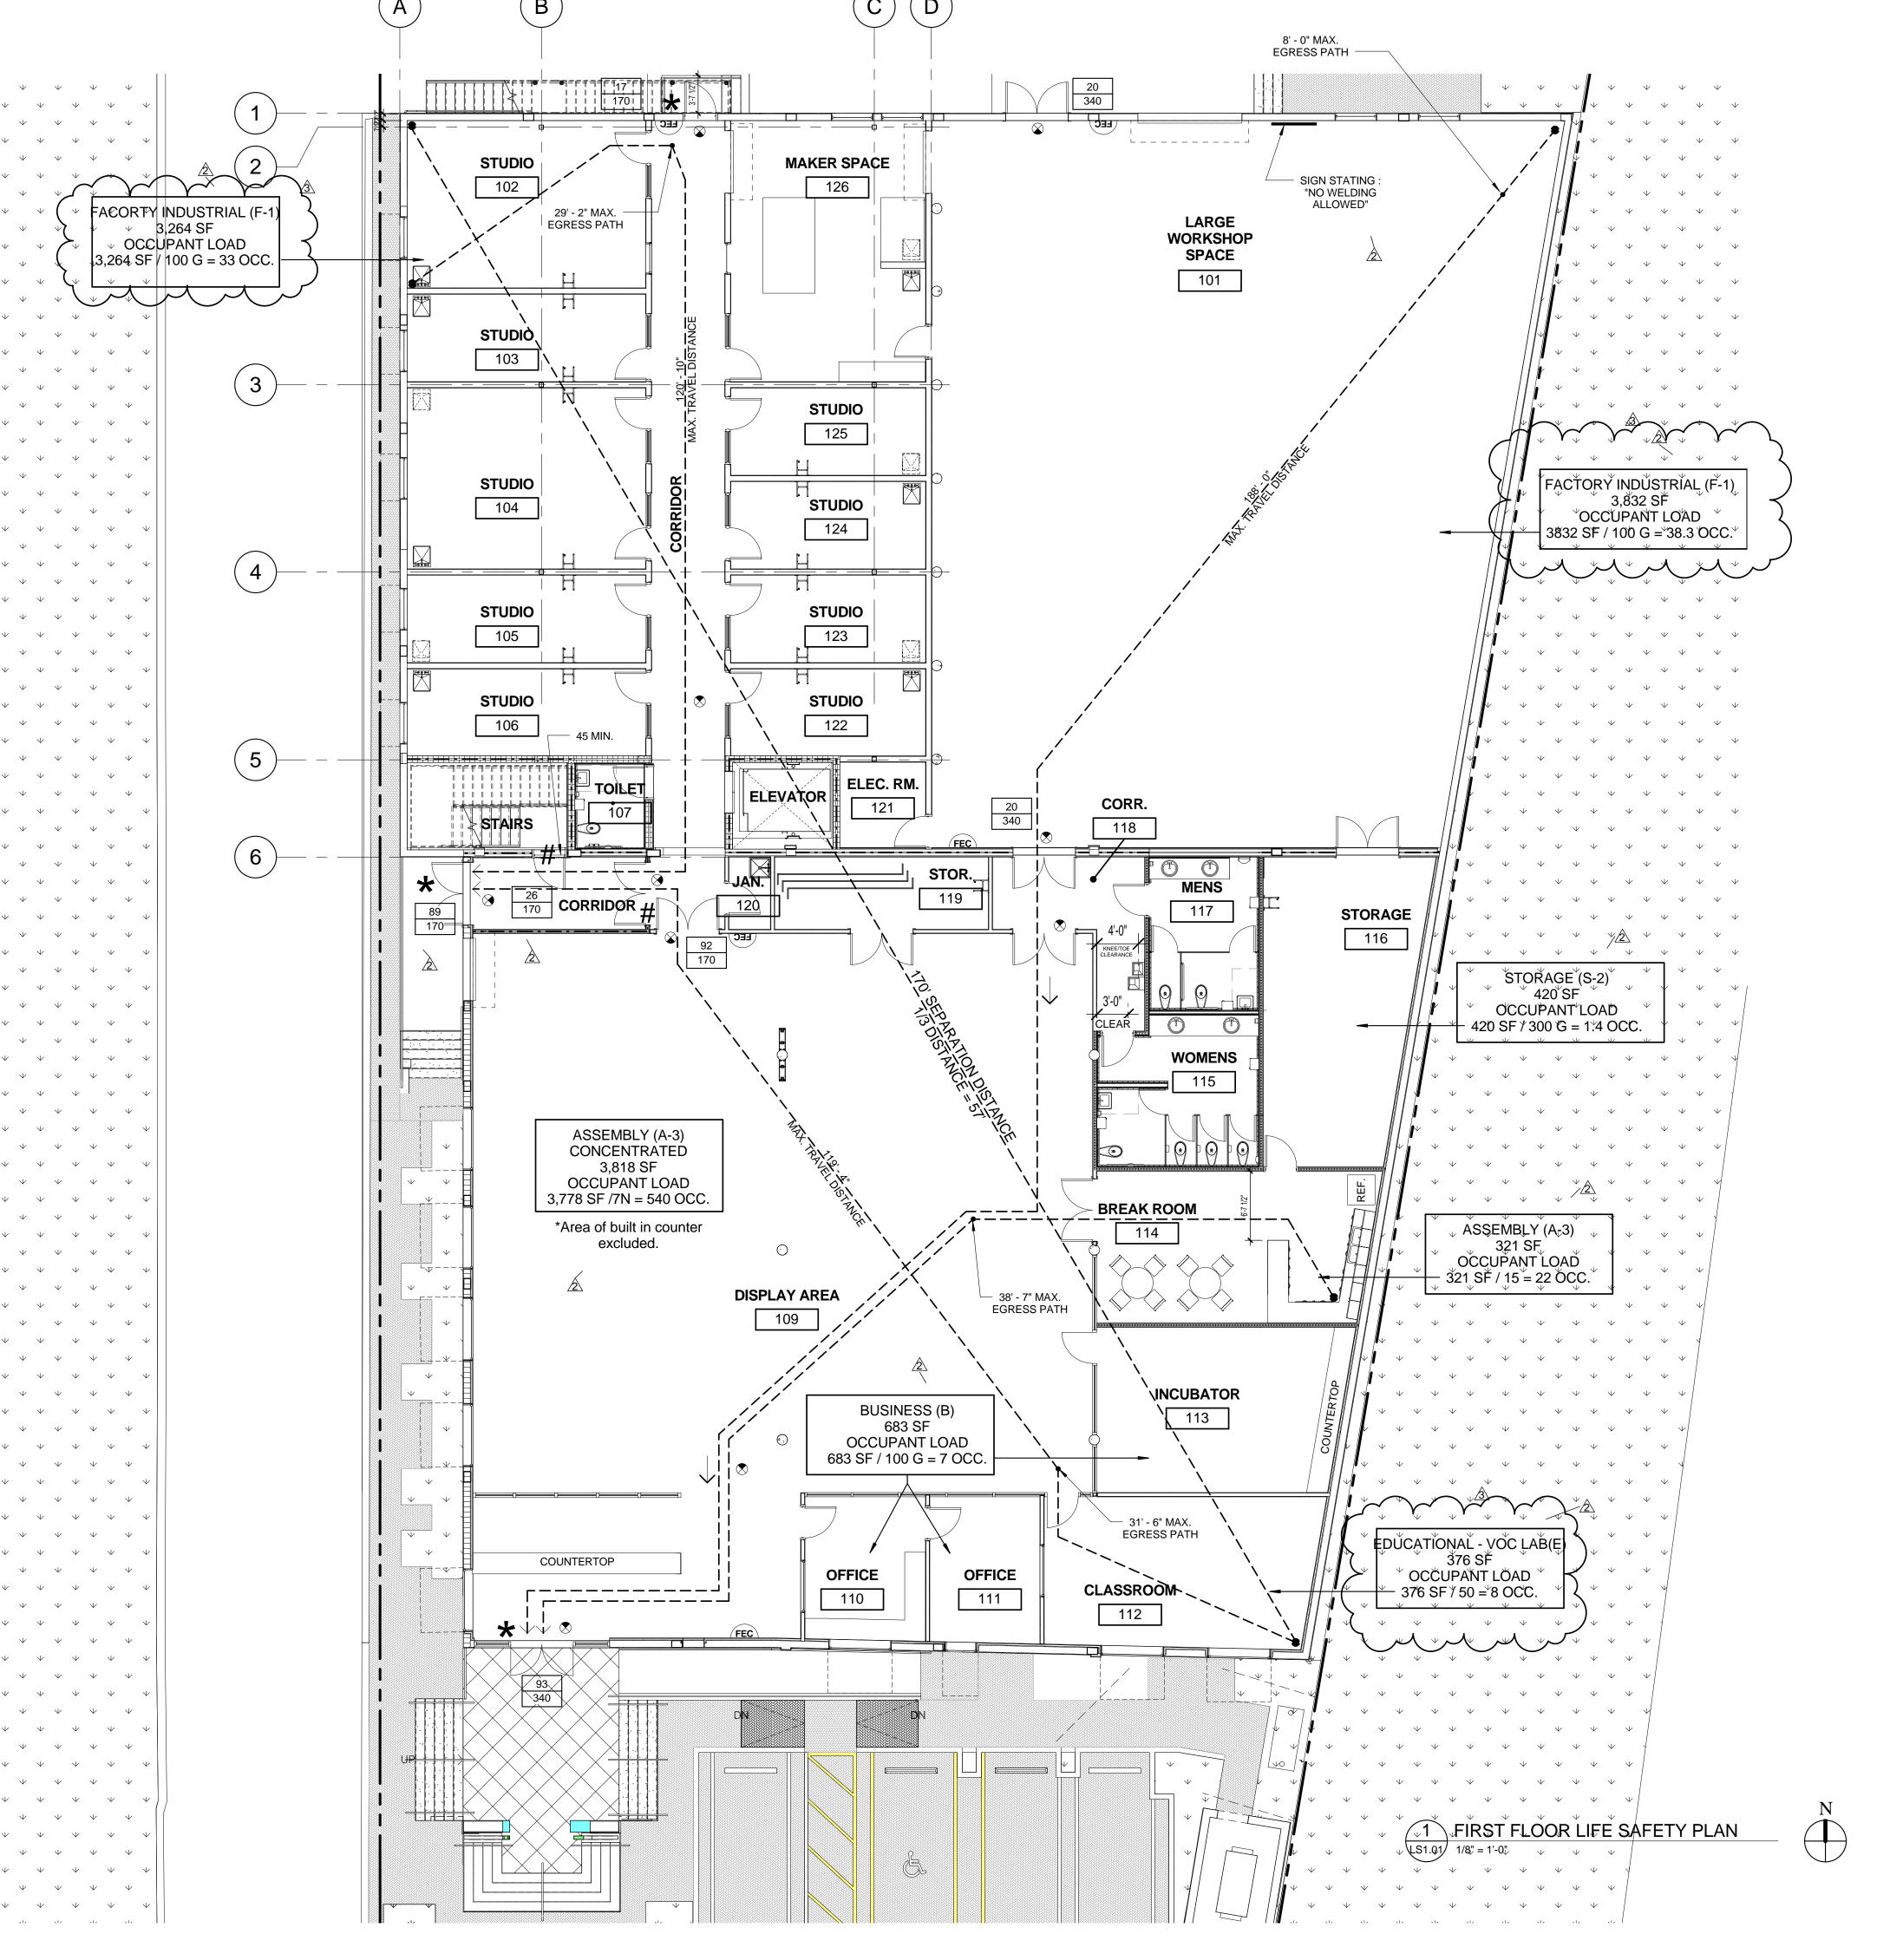



## CURRIE SOWARDS AGUILA

**AGUILA** architects

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ISSUED FOR :

SPRAB 3/05/2015

PERMIT 6/29/2015

CONSTRUCTION

Art Warehouse Renovation

313 NE 3rd Street, Delray Beach, Florida 33444

REVISI	VISIONS	
NUM.	JM. DESCRIPTION	DATE
1	Bldg. Dept. comments	8/21/ 2015
2	Bldg. Dept. comments	10/23/ 2015
3	Bldg. Dept. Cmnts	12/28/20 15

THESE DRAWINGS ARE PREPARED PER ESTABLISHED INDUSTRY STANDARDS AND REPRESENT THE ARCHITECT AND ENGINEERS DESIGN CONCEPT. THEY ARE NOT INTENDED TO PROVIDE EVERY DETAIL OR CONDITION REQUIRED TO CONSTRUCT THE BUILDING. THE CONTRACTOR THROUGH SUBMITTALS AND OTHER COORDINATION EFFORTS IS FULLY RESPONSIBLE FOR PROVIDING A COMPLETE AND OPERATIONAL BUILDING WHETHER INDICATED ON THE PLANS OR NOT.

FILE NUMBER
J:\100701 DELRAY CRA ART
INCUBATOR\DRAWINGS\100701 -


FIRST FLOOR LIFE
SAFETY PLAN

DATE | DRAW | MM

6/29/2015 MM

JOB NUMBER
100701

LS1.01

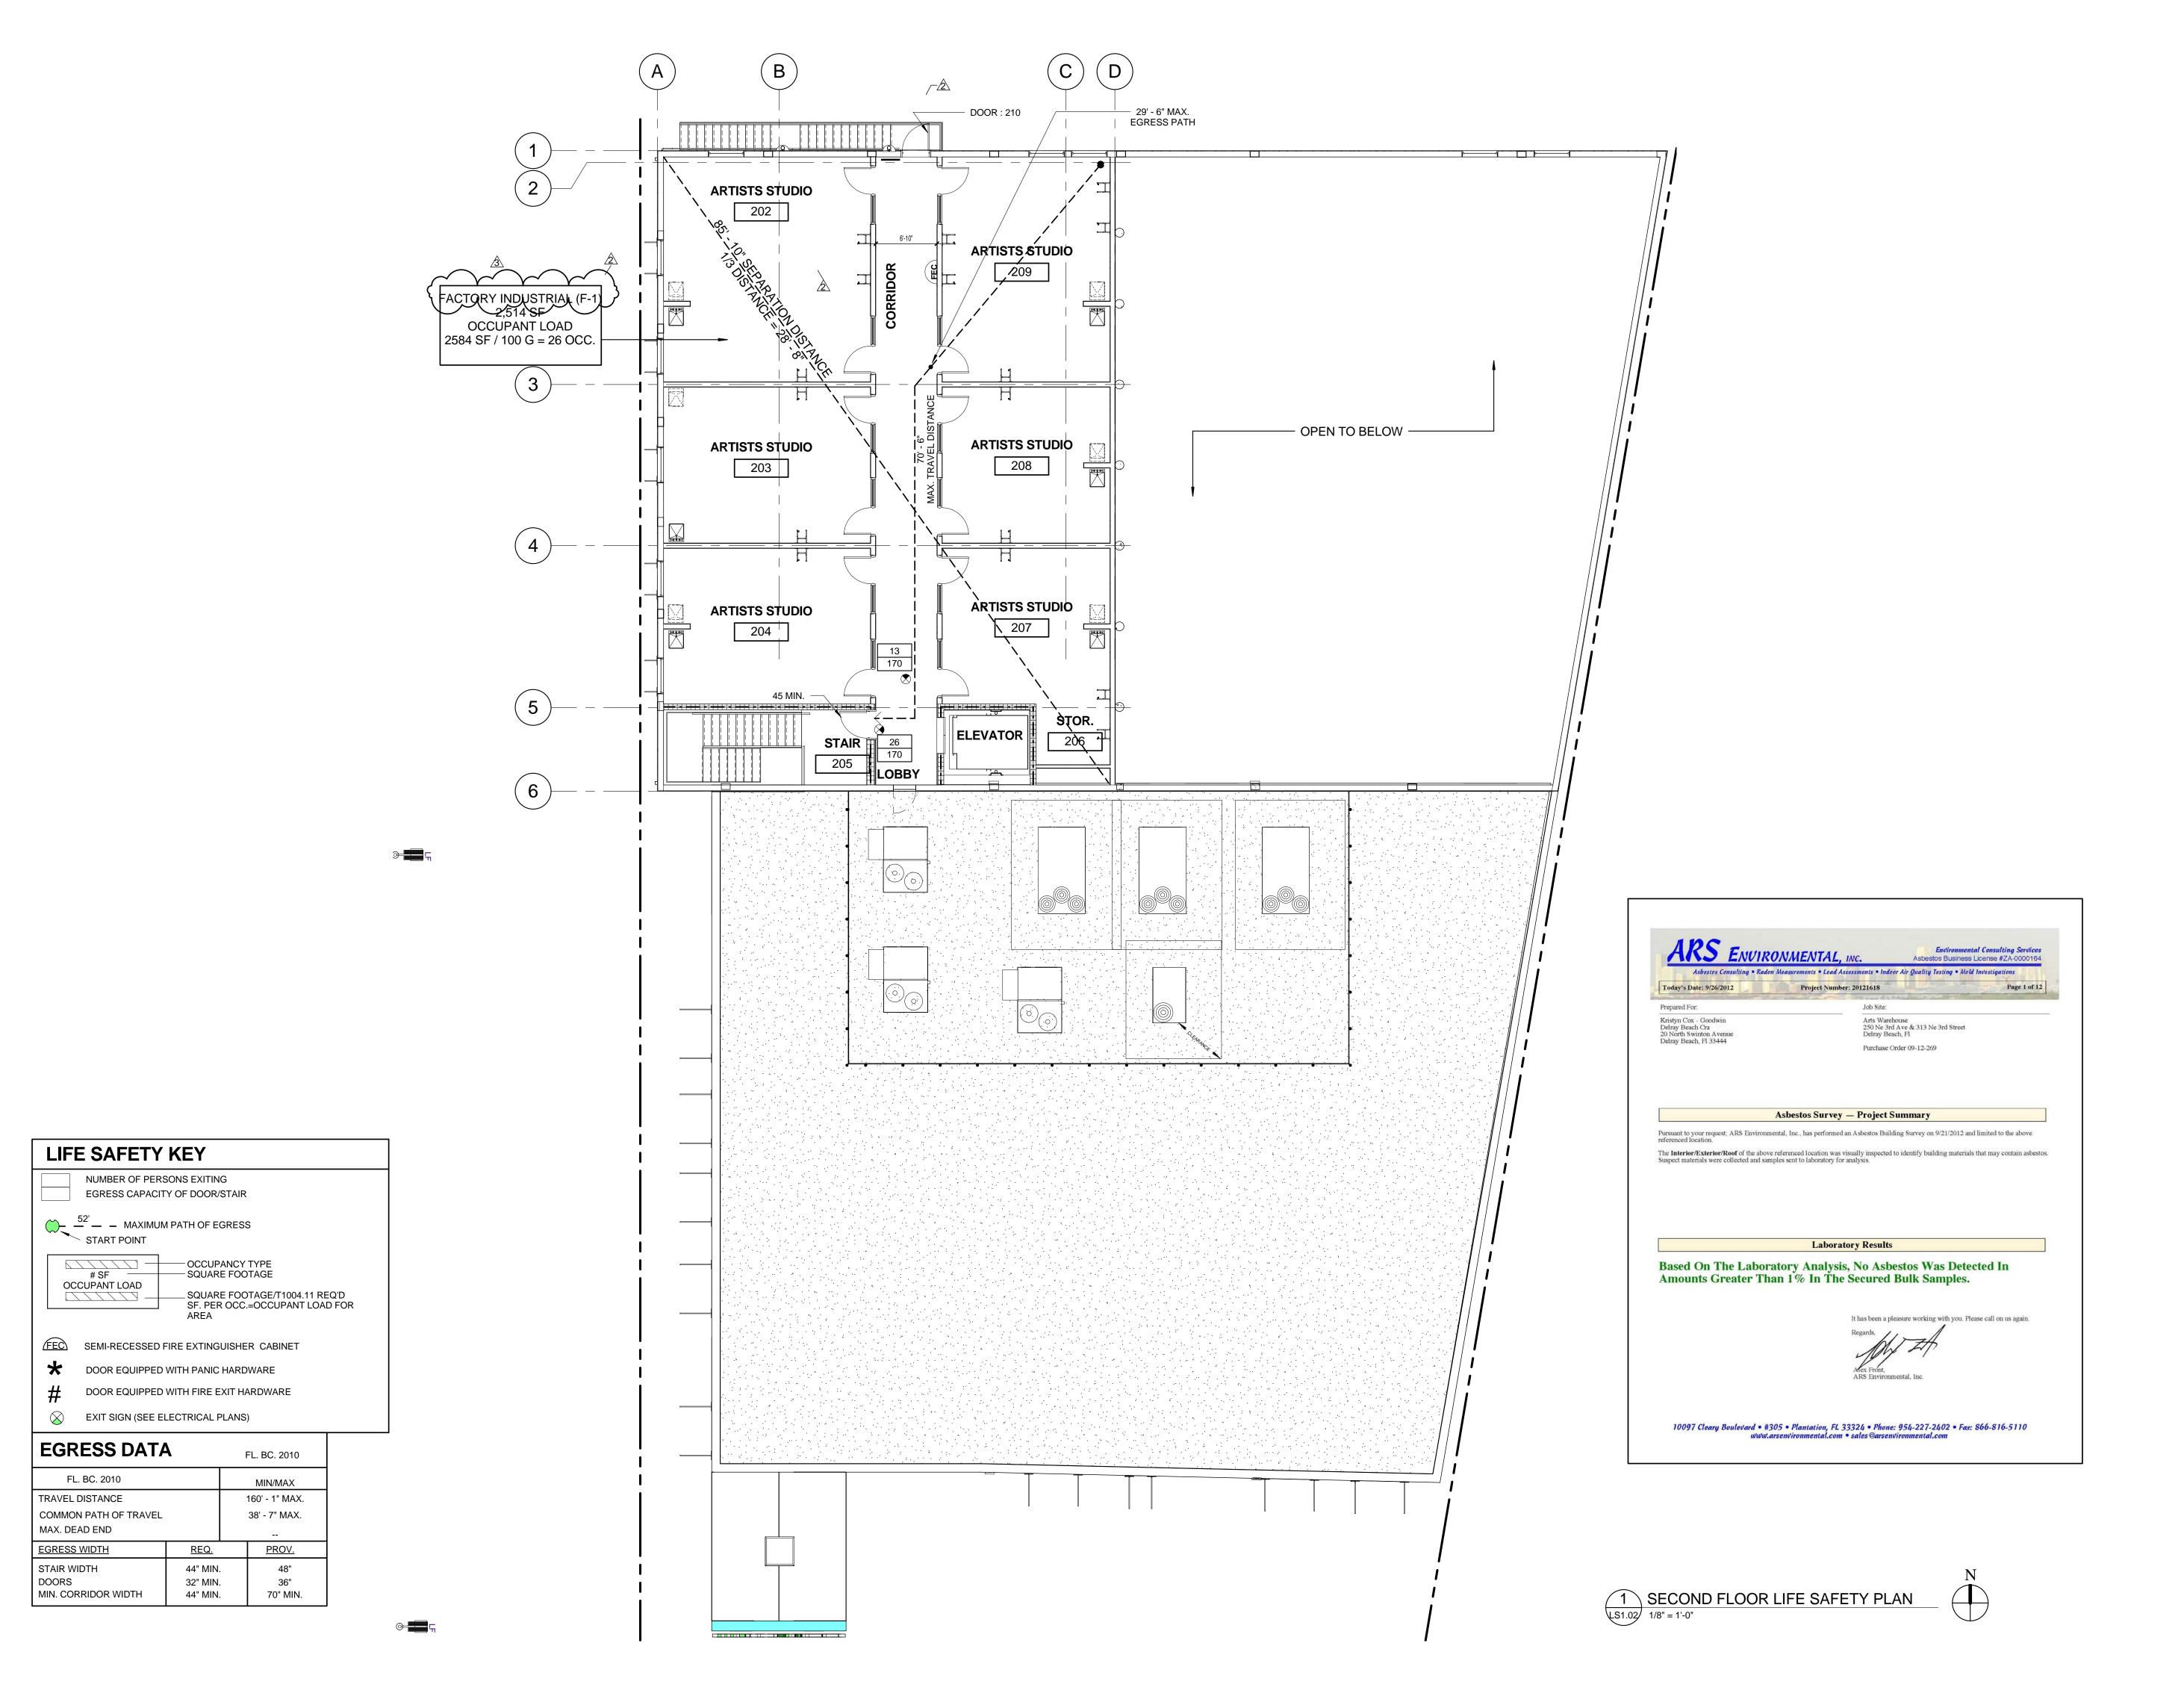



Sustainable Design

AA26001584

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INDICATED ON THE PLANS
FILE NUMBER
J:\100701 DELRAY CRA ART
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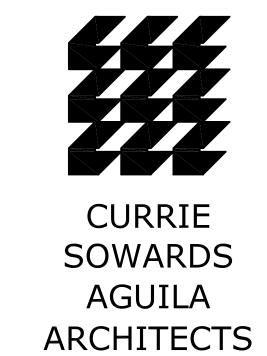
SECOND FLOOR

OZ/6Z/

DATE 6/29/2015 MM

JOB NUMBER
100701

LS1.02



Architects, Planners & Interior Designers

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ISSUED FOR: SPRAB 3/05/2015

BIDS

PERMIT 6/29/2015

CONSTRUCTION

SEAL

PROJECT TITLE

## DELRAY BEACH ART INCUBATOR

EXISTING CONFIGURATION

313 NE 2nd Street Delray Beach, Florida

REVISIONS

Bldg. Dept. comments 8/21/2015

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FILE NUMBER
701—A201.DWG

DRAWING TITLE


EXISTING

SITE PLAN

DATE | DRAWN B' | 6/29/2015 | JC

JOB NUMBER 100701

EX\_A1

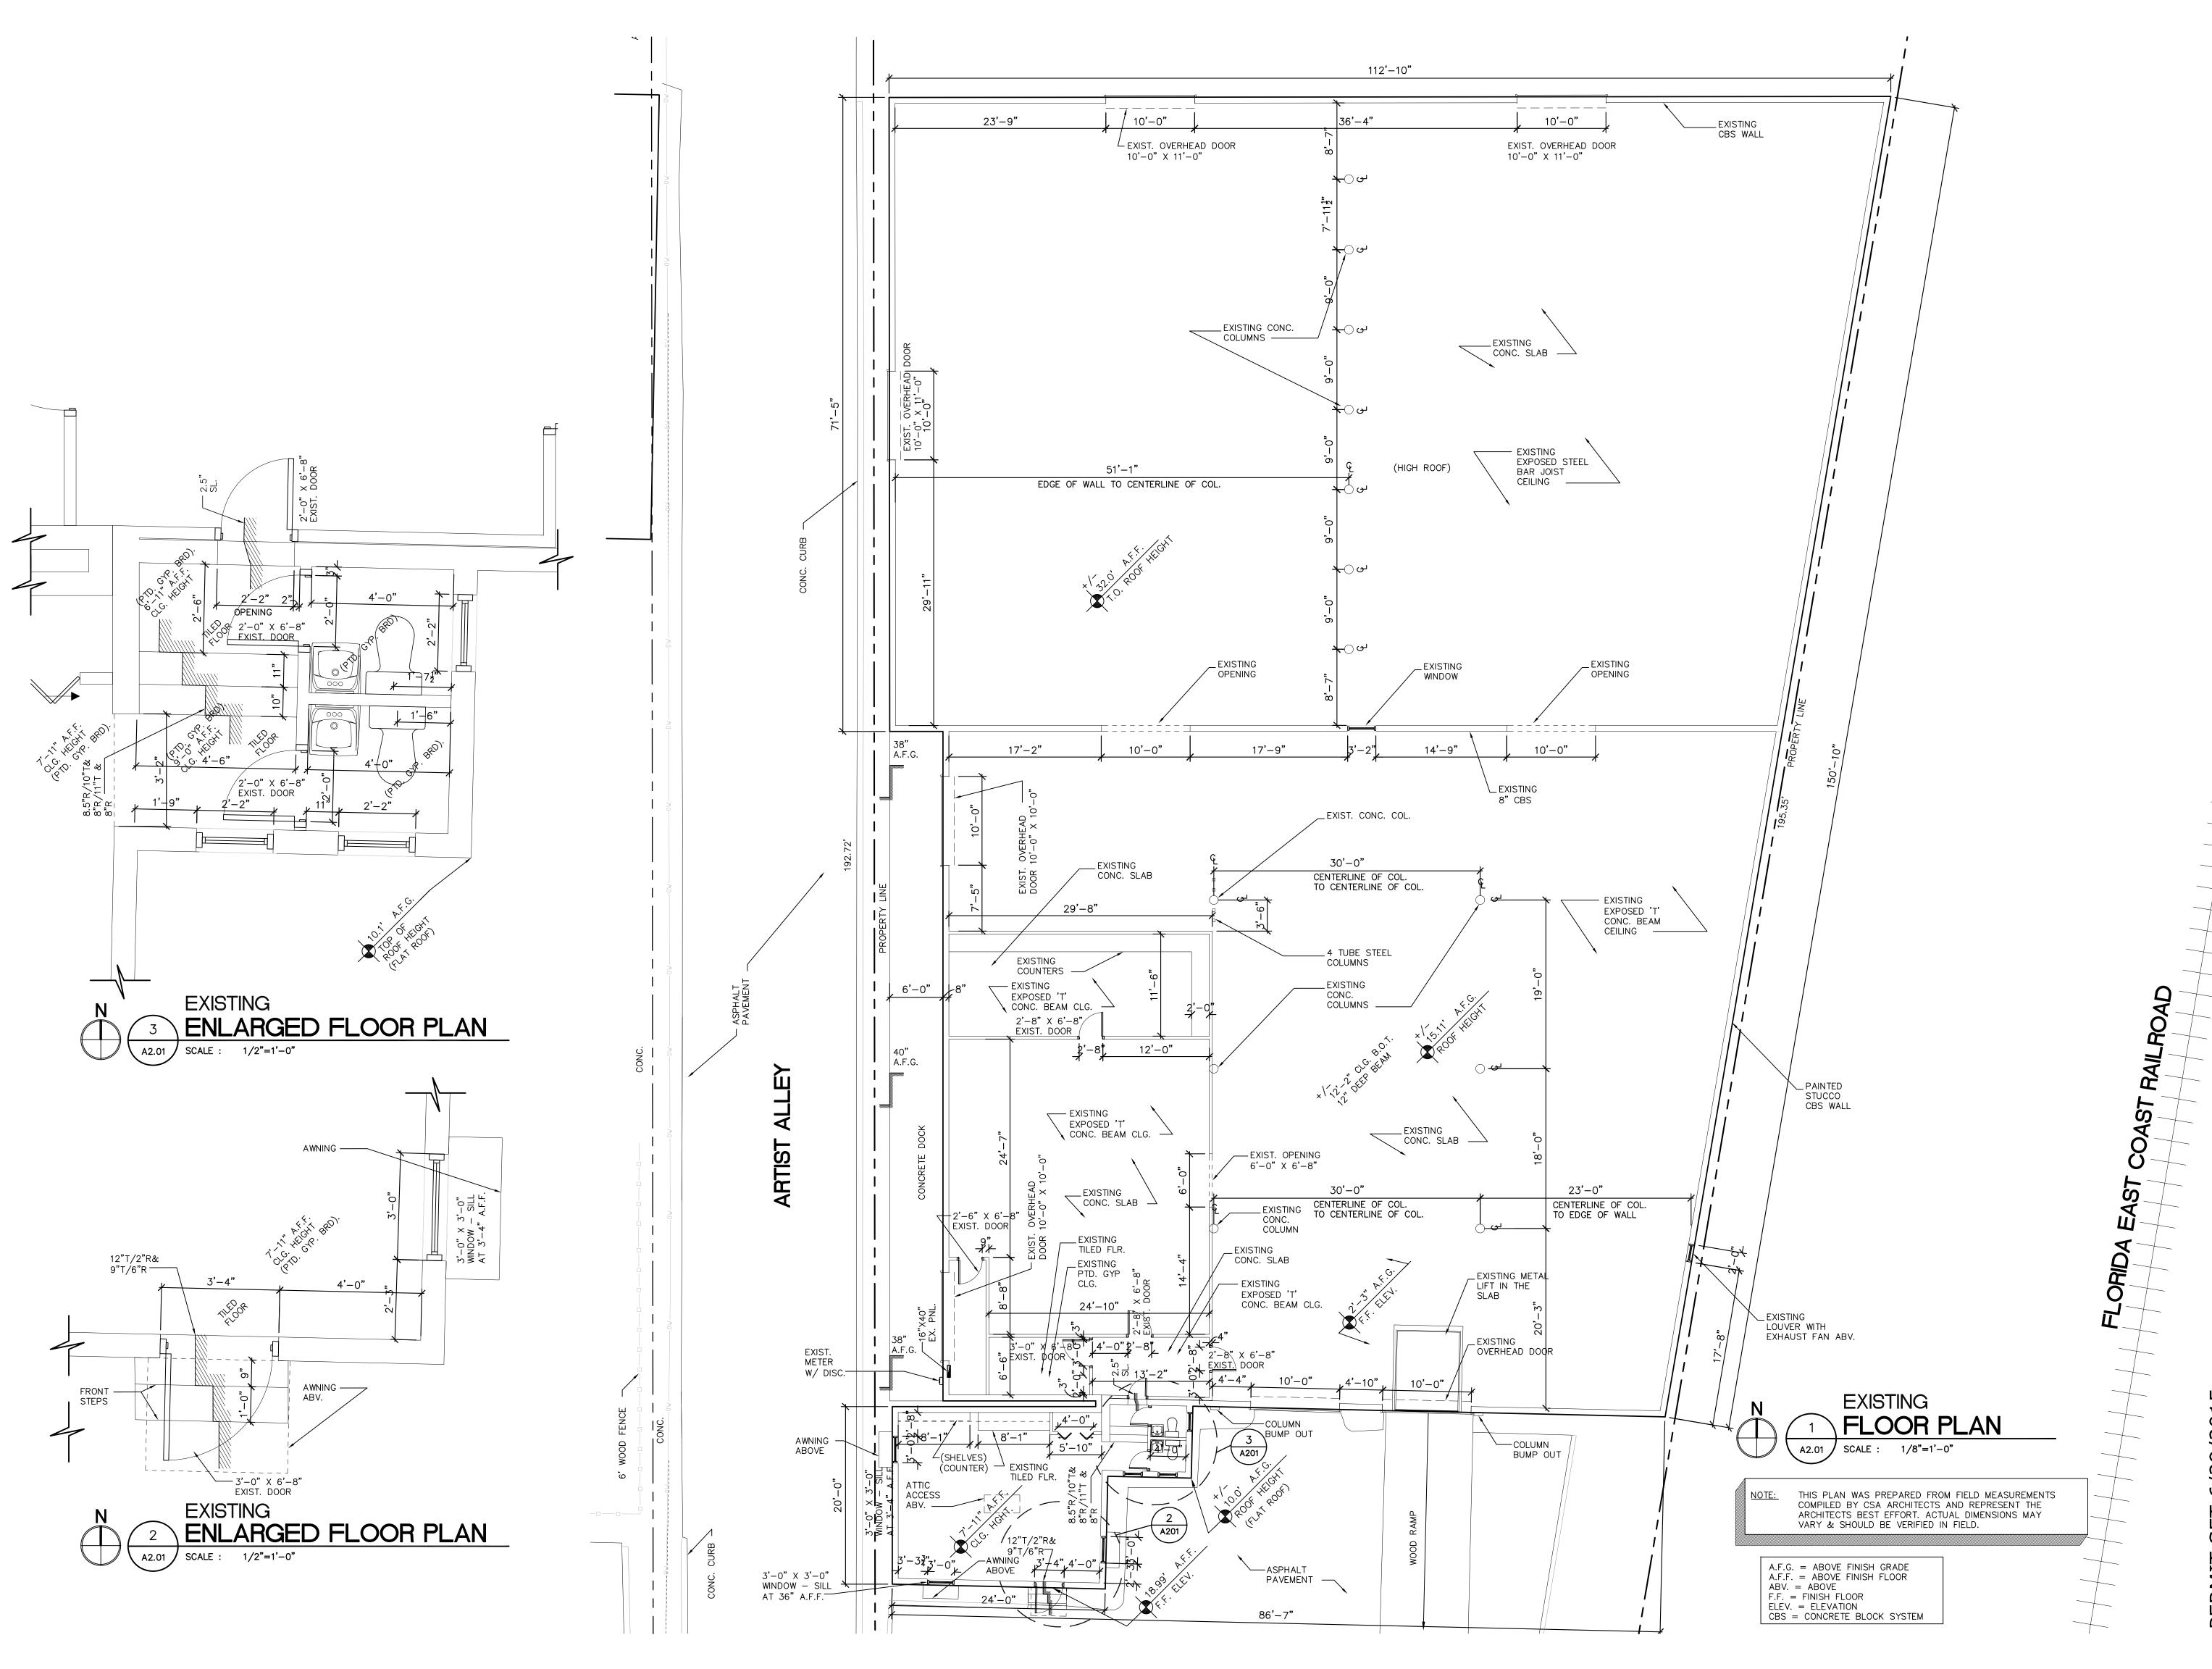

## CURRIE SOWARDS AGUILA ARCHITECTS

Architects, Planners & Interior Designers

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Delray Beach, Florida 33444
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ISSUED FOR : SPRAB 3/05/2015

BIDS

PERMIT 6/29/2015

CONSTRUCTION

SEAL

PROJECT TITLE

DELRAY BEACH ART INCUBATOR

EXISTING CONFIGURATION

313 NE 2nd Street

8/21/2015

Delray Beach, Florida

REVISIONS

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FILE NUMBER
100701 DELRAY CRA ART INCUBATOR/
DRAWINGS/Existing Drawings/701-A201 2015-4-13.dwg

DRAWING TITLE

EXISTING

EXISTING FLOOR PLAN

FLOOR PLAN

DATE | DRAWN BY | 6/29/2015 | JC | JOB NUMBER | 100701 | 1

DRAWING NUMBER

EXEMPLY 1

CURRIE SOWARDS AGUILA ARCHITECTS

> Architects, Planners & Interior Designers

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313 NE 2nd Street Delray Beach, Florida

REVISION

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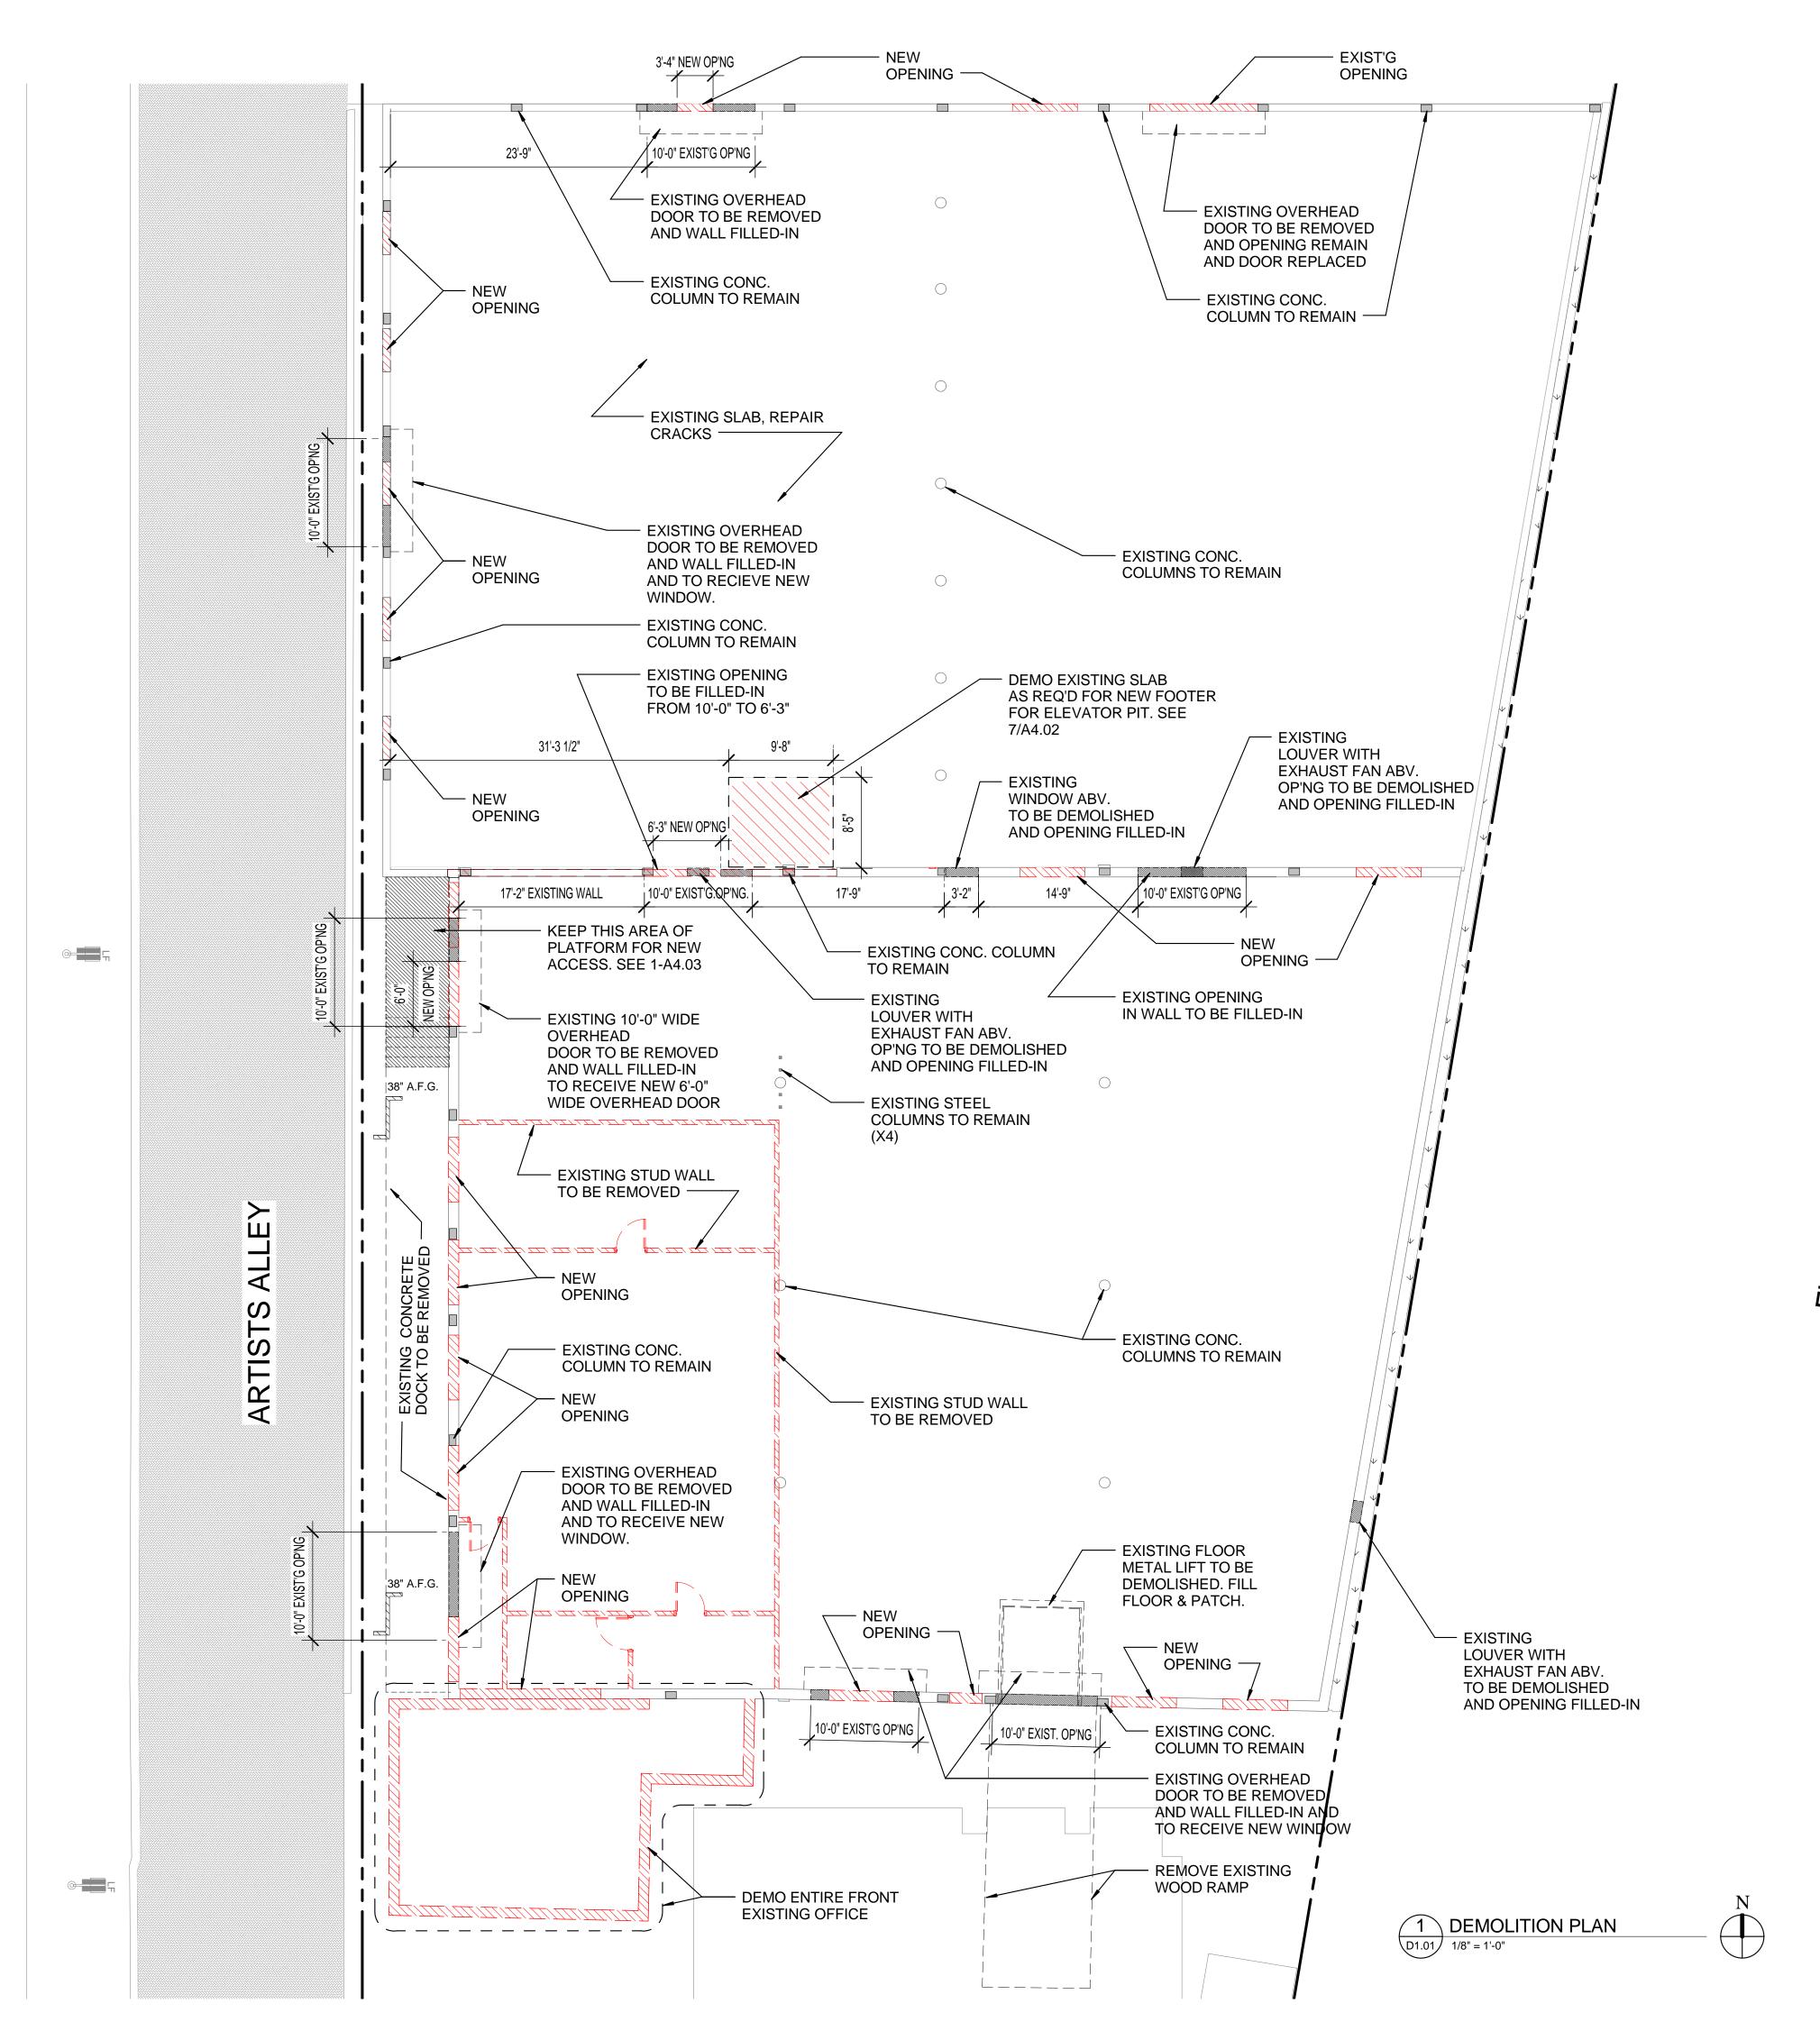
EXISTING

EXTERIOR ELEVATIONS

DATE DRAWN BY 6/29/2015 JC

JOB NUMBER 100701

EX-A3.0



FLORIDA EAST COAST RAILROAD

GENERAL NOTES:

IT IS REQUIRED THAT THE BIDDING
CONTRACTORS VISIT SITE TO ASSESS
EXISTING CONDITIONS AND
REPORT ANY ADDITIONAL OBSERVATIONS,

QUESTIONS, OR DISCREPANCIES TO THE

ARCHITECT PRIOR TO SUBMITTING A BID.

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FILE NUMBER
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INCUBATOR\DRAWINGS\100701 CENTRAL.ryt

DEMOLITION
O DI ANI

**DATE** 6/29/2015 JCR

6/29/2015 JC


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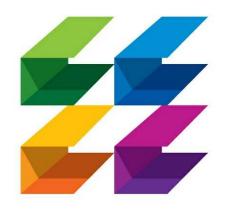
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D1.01





## **CURRIE SOWARDS AGUILA**

architects

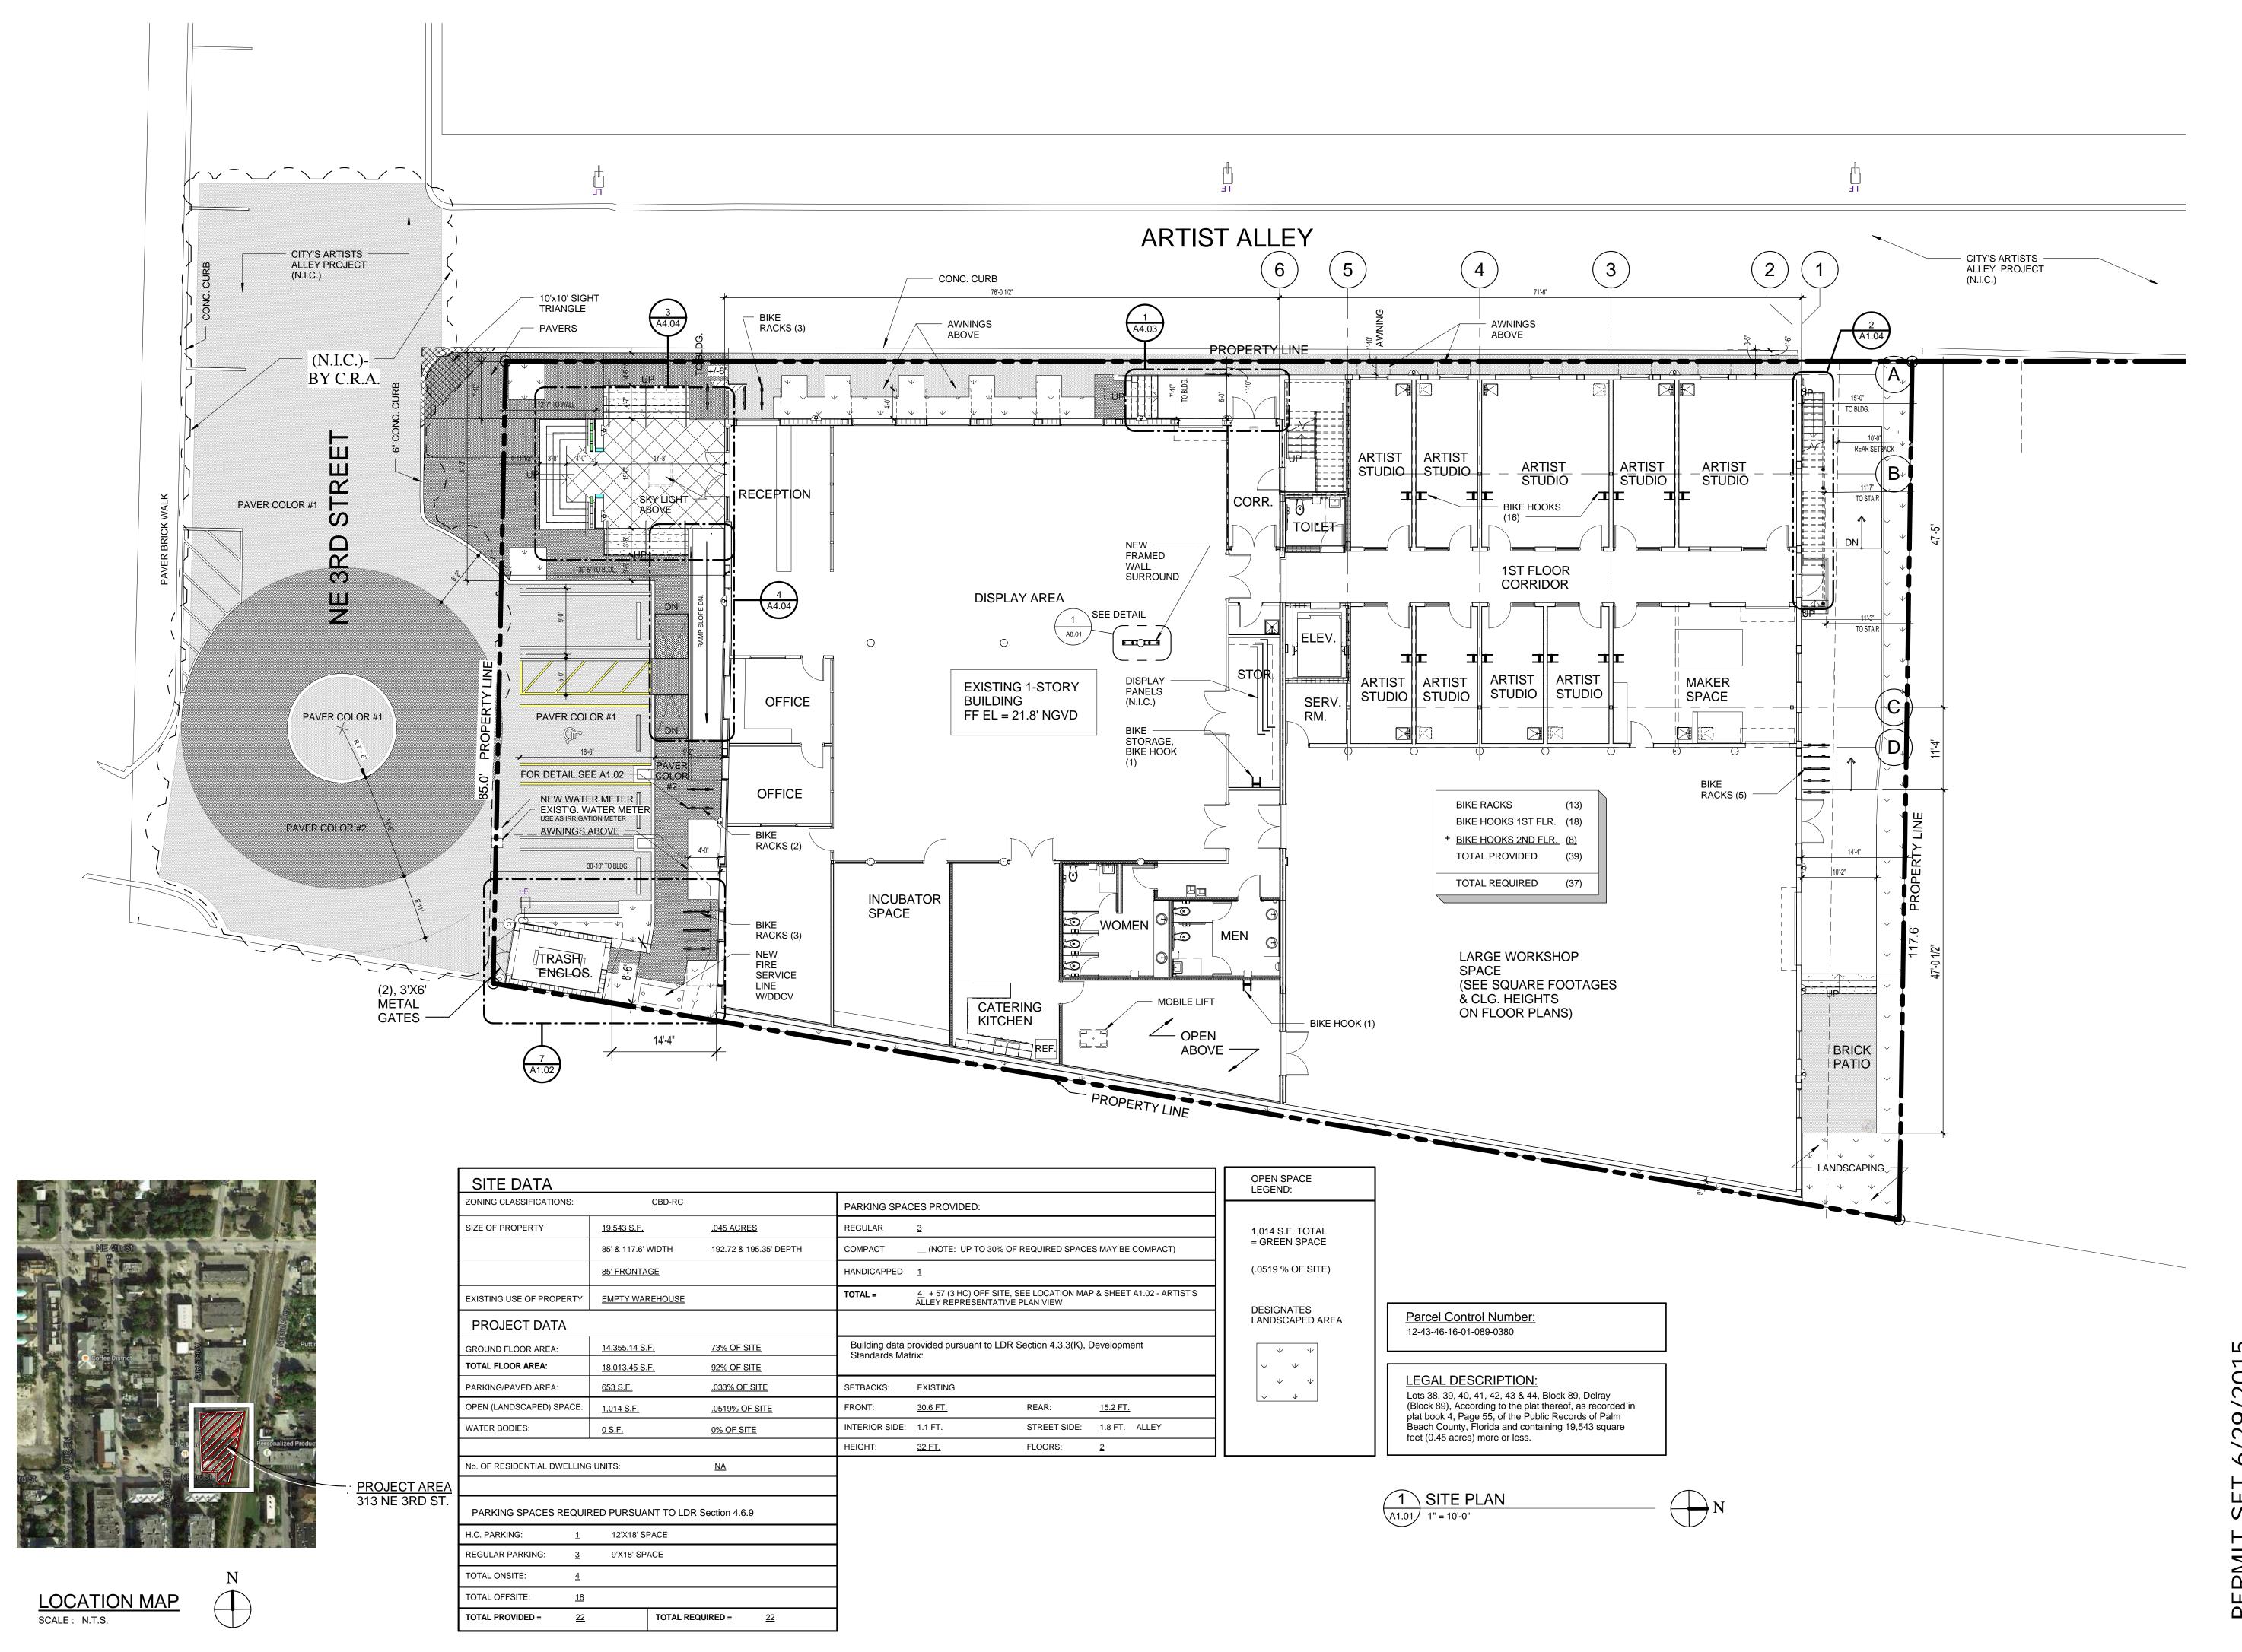Architecture, Planning,

185 NE 4TH AVENUE SUITE 101

Interiors, & Sustainable Design AA26001584

T: (561) 276-4951 F: (561) 243-8184 E-MAIL: office@csa-architects.com

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SEAL

PROJECT TITLE Art Warehouse Renovation

313 NE 3rd Street, Delray Beach, Florida 33444

DESCRIPTION 1 Bldg. Dept. comments


THESE DRAWINGS ARE PREPARED PER ESTABLISHED INDUSTRY STANDARDS AND REPRESENT THE ARCHITECT AND ENGINEERS DESIGN CONCEPT. THEY ARE NOT INTENDED TO PROVIDE EVERY DETAIL OR CONDITION REQUIRED TO CONSTRUCT THE BUILDING. THE CONTRACTOR THROUGH SUBMITTALS AND OTHER COORDINATION EFFORTS IS FULLY RESPONSIBLE FOR PROVIDING A COMPLETE AND OPERATIONAL BUILDING WHETHER INDICATED ON THE PLANS OR NOT.


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SITE PLAN

6/29/2015



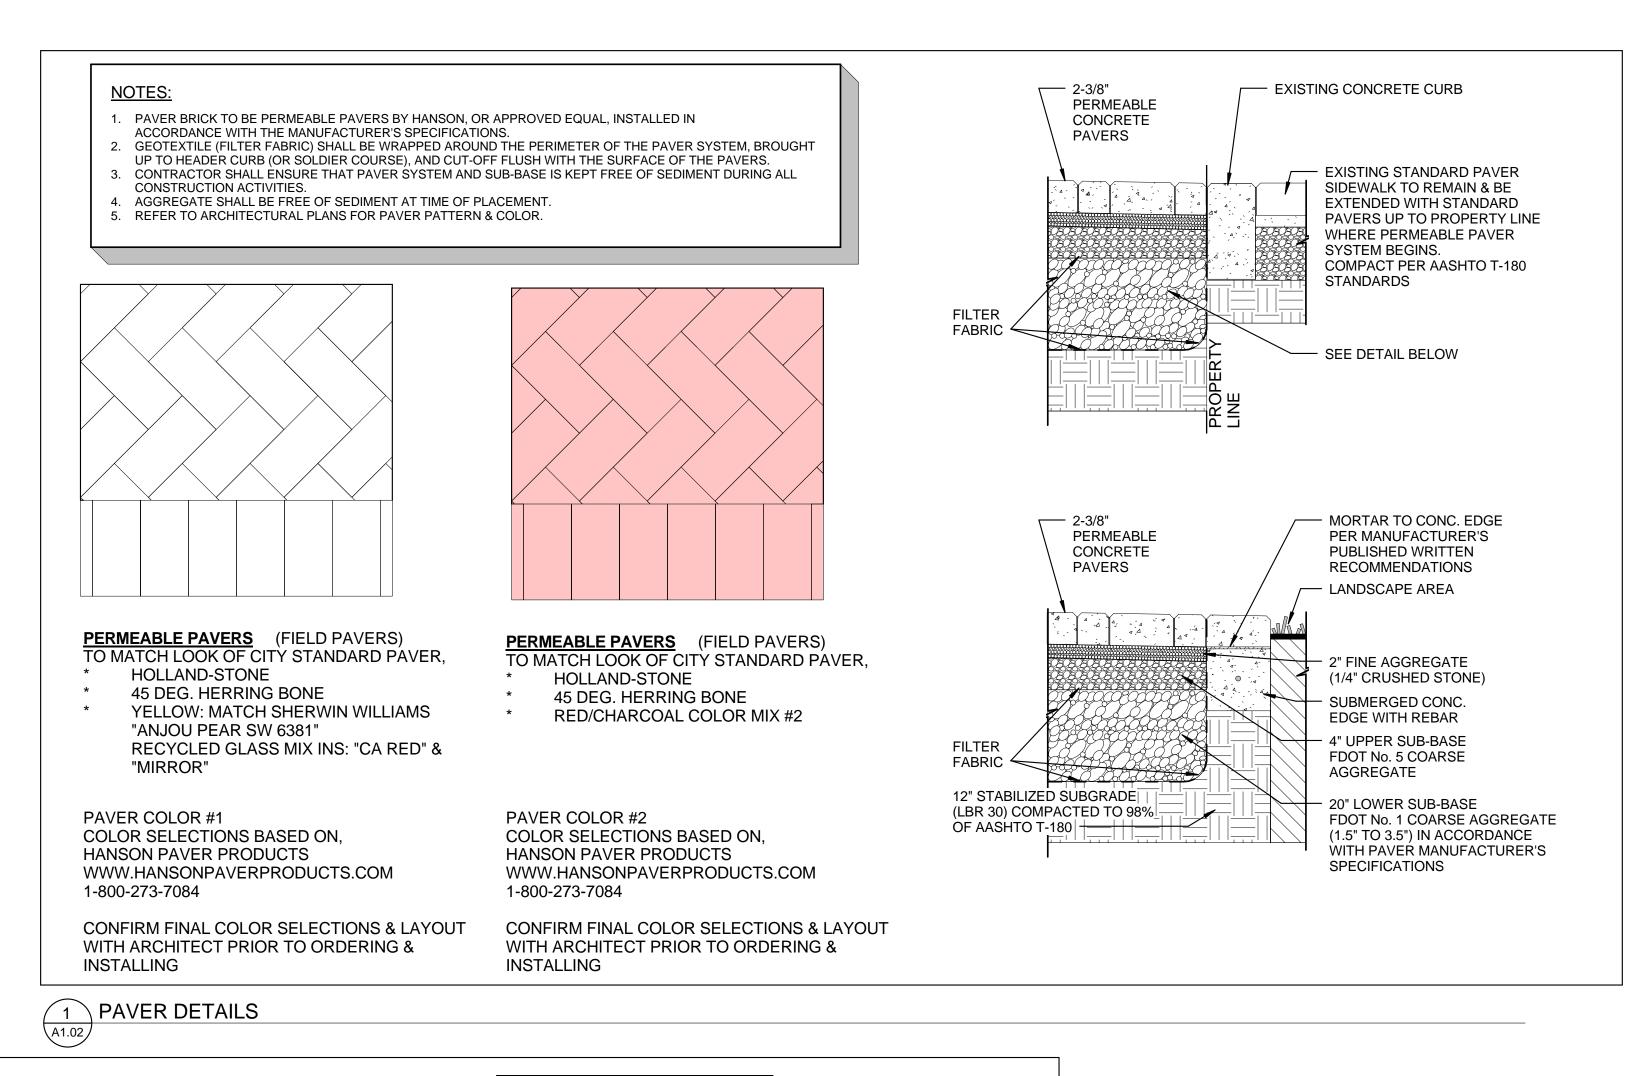

A1.02 1/2" = 1'-0"

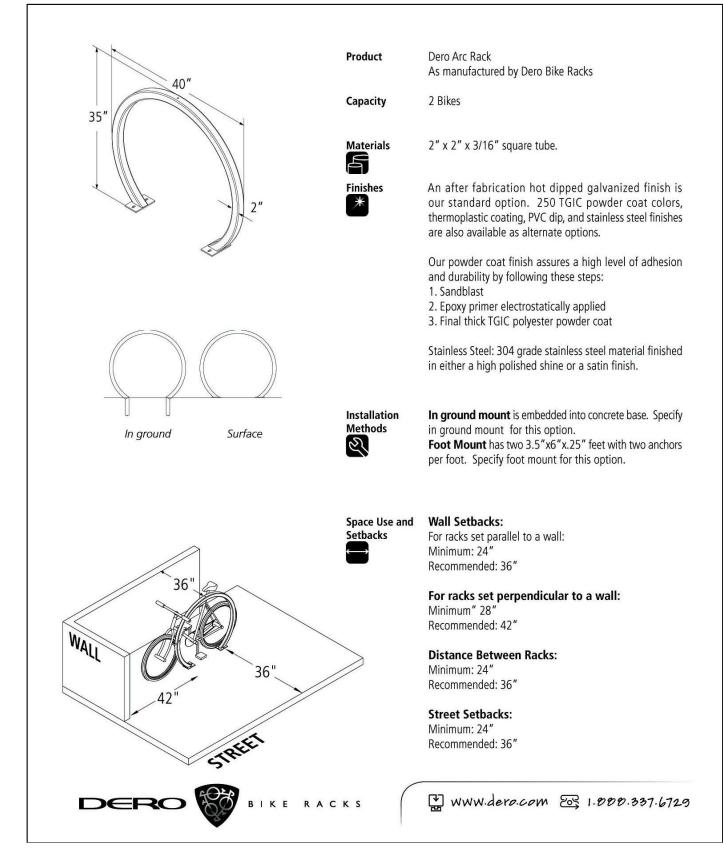- (2), 3'x6' METAL

A1.02 1/4" = 1'-0"

WALLS

SW 6598

SW 6733 -

SW 6781

SW 6522

**DISHY CORAL** 

GRASSHOPPER

JAIMACA BAY

SPORTY BLUE

PATTERN COLORS,

SEE WEST & NORTH

ENCLOSURE

GATE

- 6" DIA. BOLLARD

PAINTED STEEL W/CONC.FILL

TYPE'D'

BOLLARD


- SLOPE 1/4" PER FOOT

DUMPSTER

CONCRETE SLAP

**ÀA1.02** 

7 ENLARGED FLOOR PLAN - DUMPSTER ENCLOSURE

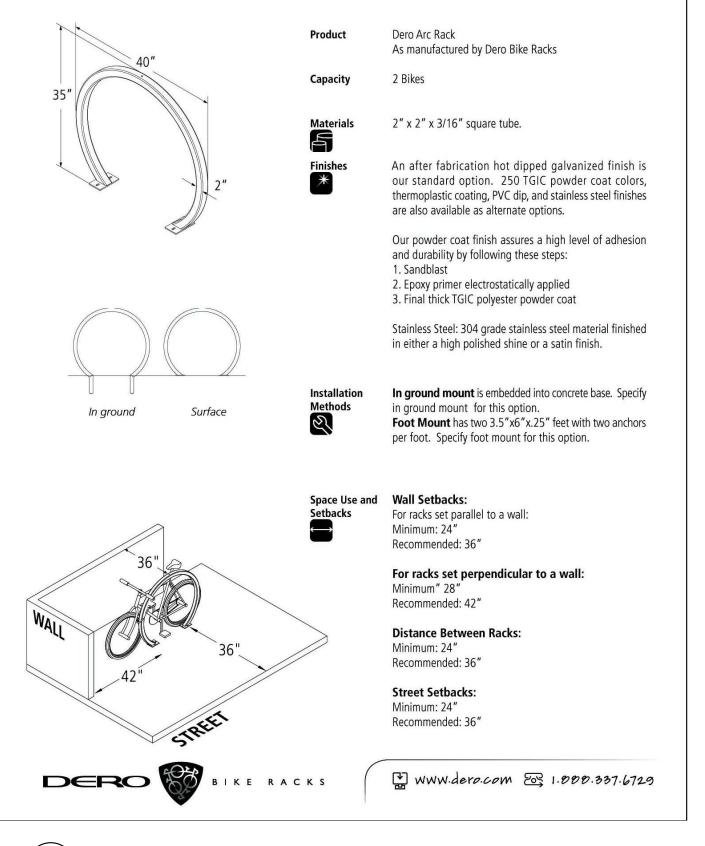



BLDG. TO TRASH ENCLOSURE

NEW FIRE

SERVICE LINE

W/ DDCV, SEE

**OUTGOING ORANGE** 

CMU WALL - 3/4" STUCCO

PAINTED: FUN YELLOW

SW6908 (BACKGROUND)

ORGANIC GREEN

SW 6641

SW 6732

TO PATTERN

T.O. WALL

FROM GRADE

CONC.

GRADE

**PAVERS** 

6'-0"

CIVIL PLAN

BIKE RACKS

6" CONCRETE

313 NE 3rd Street, Delray Beach, Florida 33444

**CURRIE** 

**AGUILA** 

**SOWARDS** 

architects

Architecture, Planning, Interiors, &

Sustainable Design

AA26001584

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DELRAY BEACH, FL 33483

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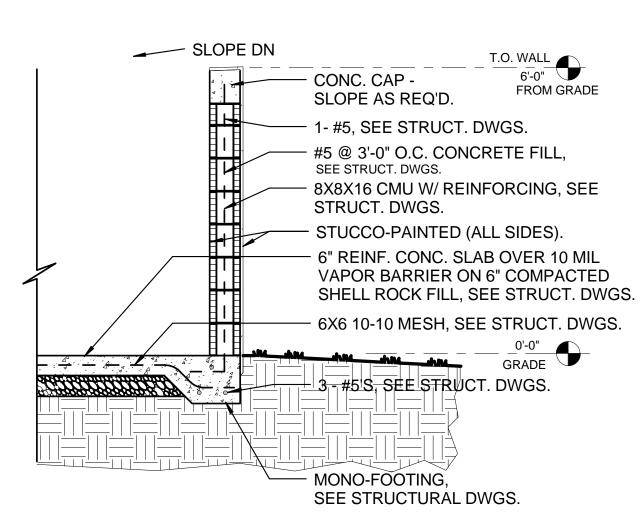
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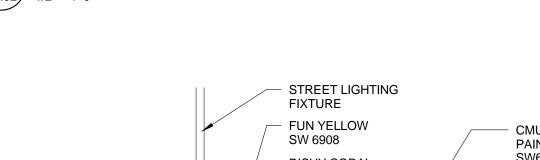
SITE DETAILS


6/29/2015

PARKING: PARKING: 14 SPACES (1 H.C.) 313 NE 3RD STREET



2 DUMPSTER ENCLOSURE DETAIL A1.02 1/2" = 1'-0"



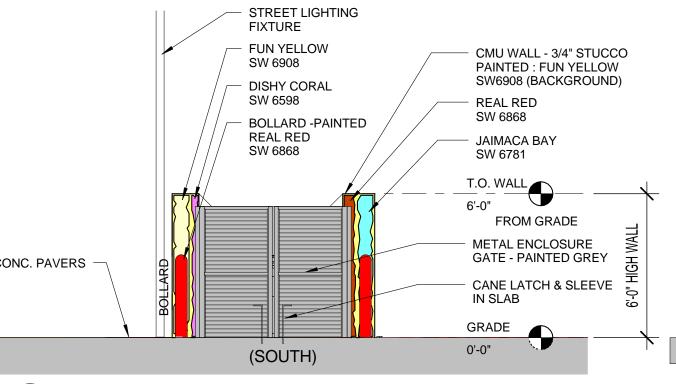

CMU WALL - 3/4" STUCCO PAINTED: FUN YELLOW SW6908 (BACKGROUND) + VARIOUS PATTERNS. COLORS FROM NORTH/ T.O. WALL 6'-0" FROM GRADE GRADE 0'-0"

CONC. PAVERS

WEST WALLS- CHECK WITH ORGANIC GREEN ARCHITECT AS TO SPECIFIC SW 6732 LAYOUT **REAL RED** SW 6868 **BOLLARD -PAINTED** RED CONC. PAVERS (WEST)

4 Elevation 2W - a - DUMPSTER ENCLOSURE A1.02 1/4" = 1'-0"

6 Elevation 4S - a - DUMPSTER ENCLOSURE A1.02 1/4" = 1'-0"

A1.02 1/4" = 1'-0"

ARTISTS' ALLEY REPRESENTATIVE PLAN VIEW GRASSHOPPER SW 6733 SPORTY BLUE SW 6522 STREET LIGHTING FIXTURE JAIMACA BAY SW 6781 6" DIA. BOLLARD -PAINTED CMU WALL -STUCCO PAINTED: FUN YELLOW SW6908 (RAILROAD SIDE) - 6" CONC. CURB - T.O. WALL 6'-0" FROM GRADE

(EAST)

3 Elevation 1E - a - DUMPSTER ENCLOSURE

A1.02


1/4" = 1'-0"

CONC. PAVERS

GRADE

0'-0"

(NORTH) 0'-0" 5 Elevation 3N - a - DUMPSTER ENCLOSURE

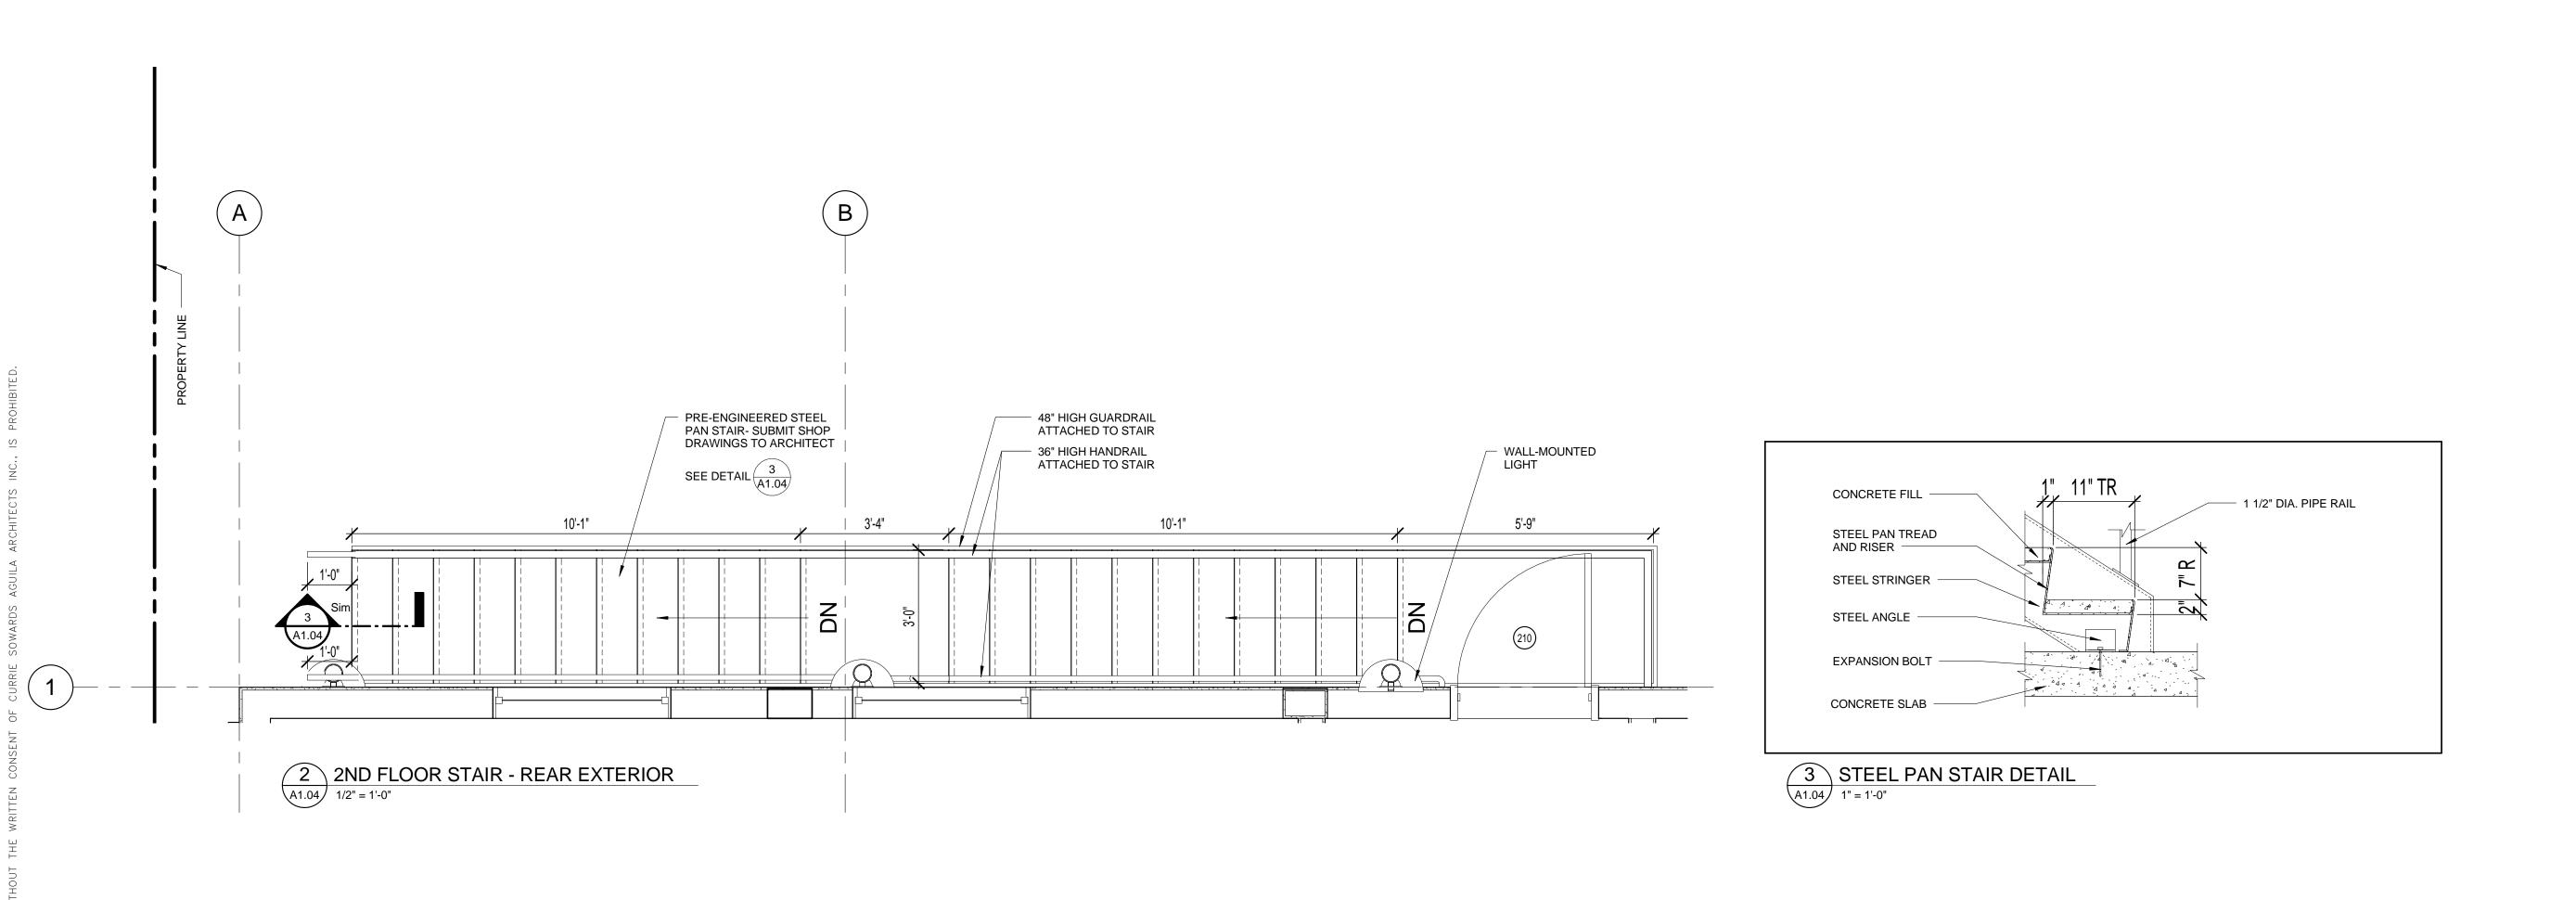



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Art Warehouse Renovation

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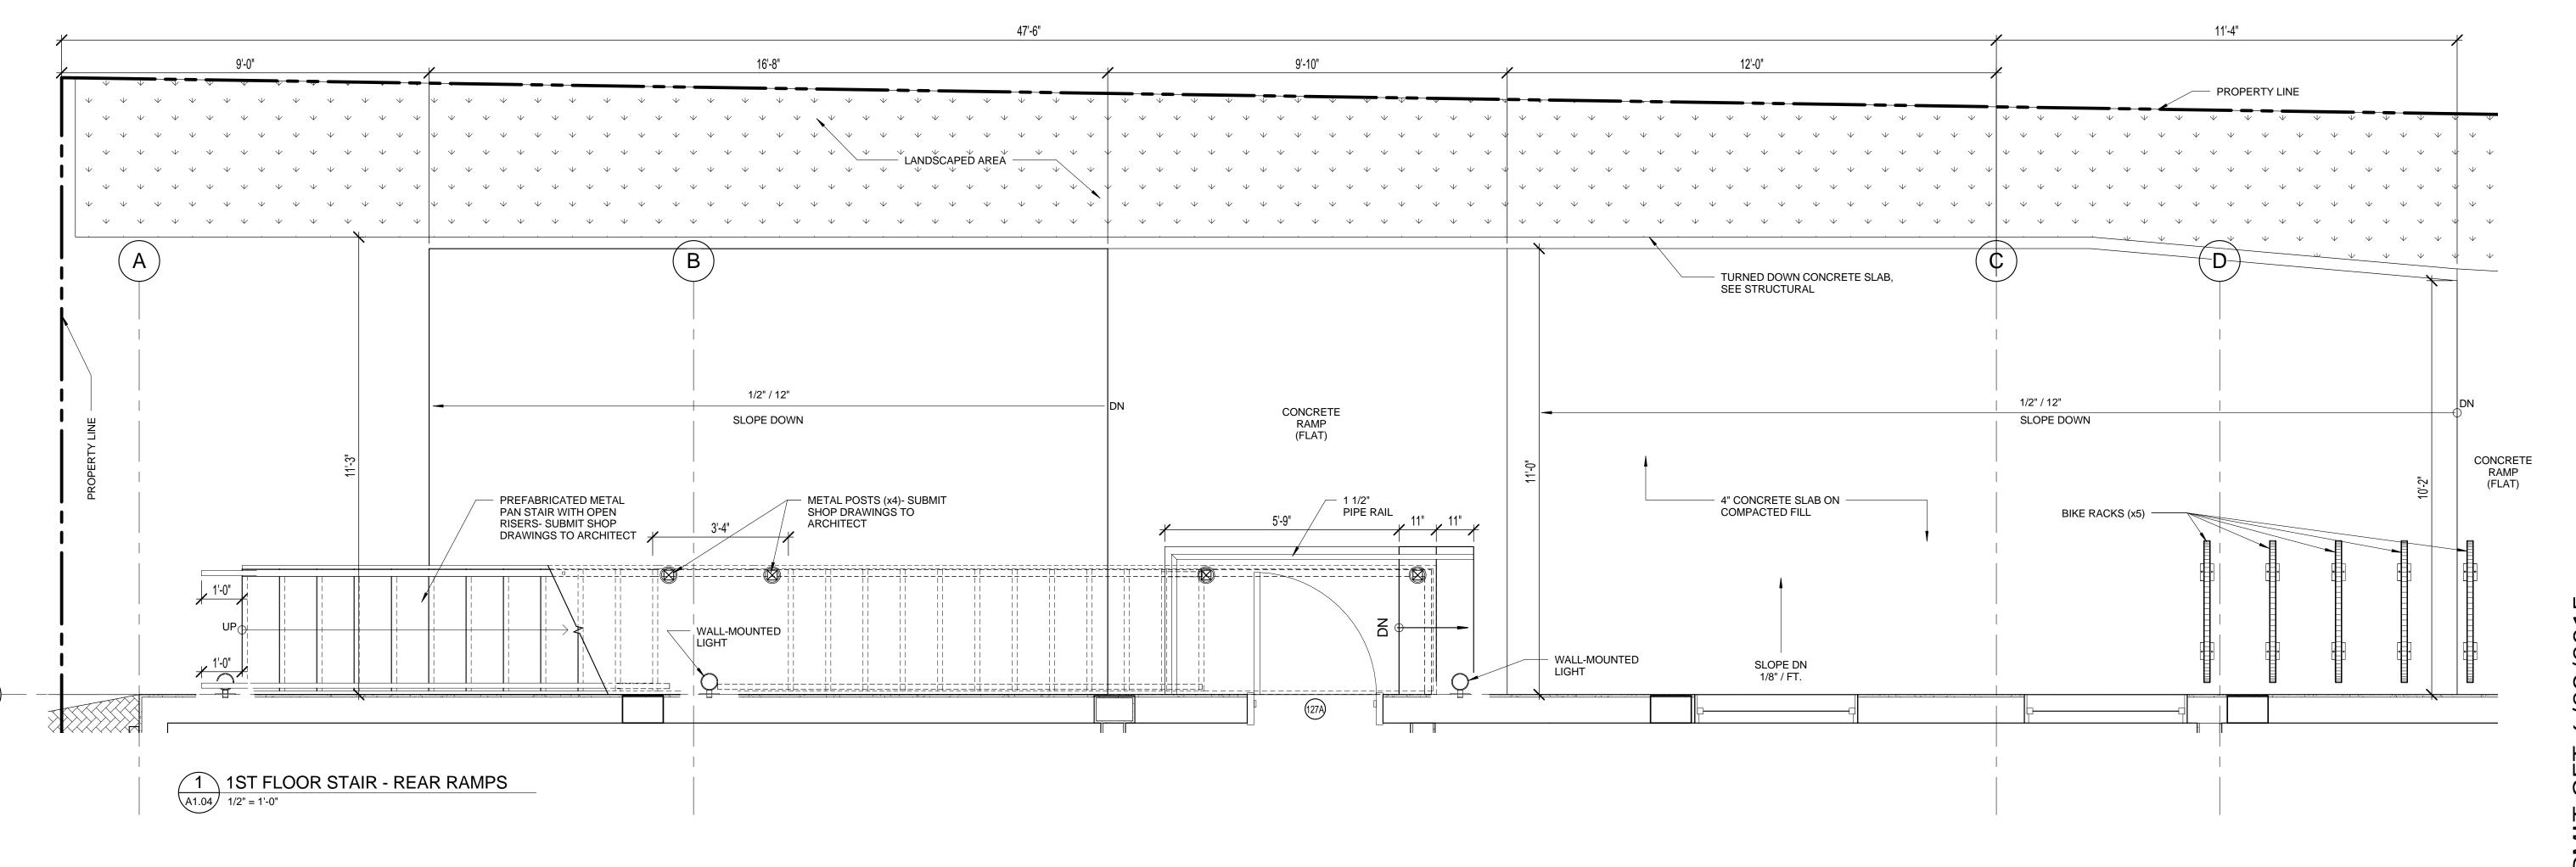
ENLARGED STAIR
AND RAMP PLANS


DATE 6/29/2015 | MM

100701

DRAWING NUMBER

A1.04



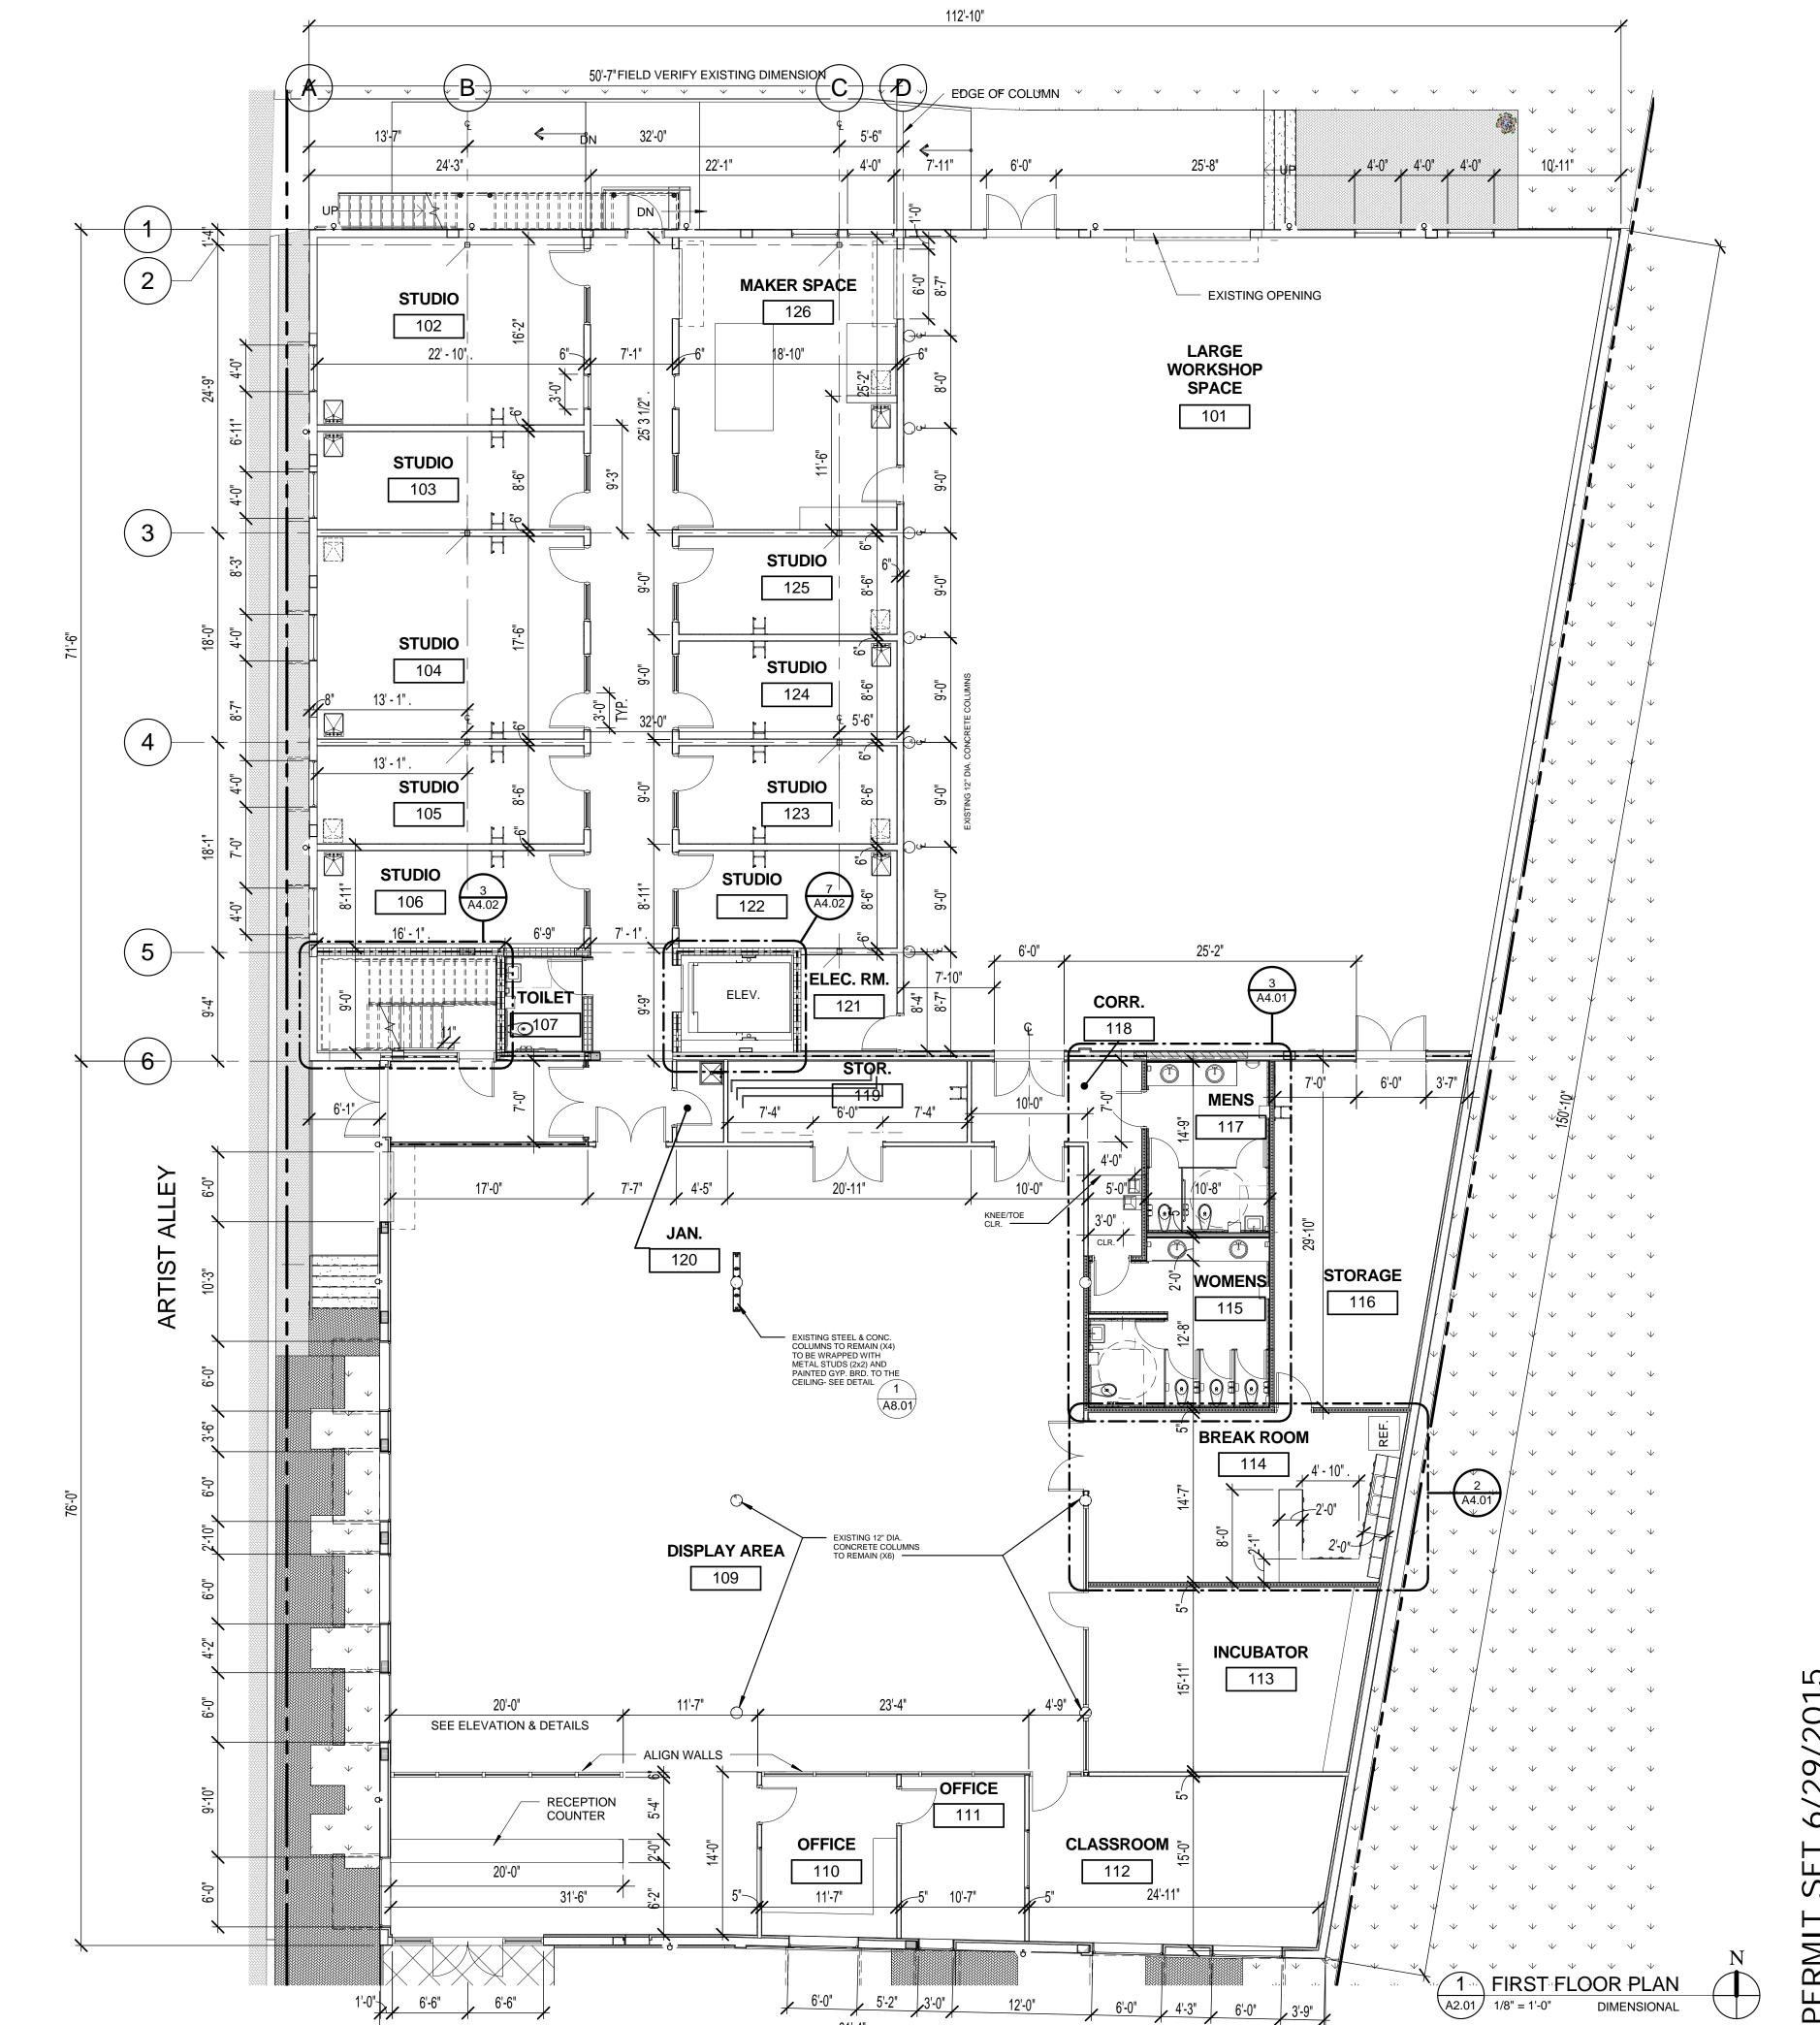



## **CURRIE SOWARDS** AGUILA architects

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AA26001584 185 NE 4TH AVENUE SUITE 101 DELRAY BEACH, FL 33483

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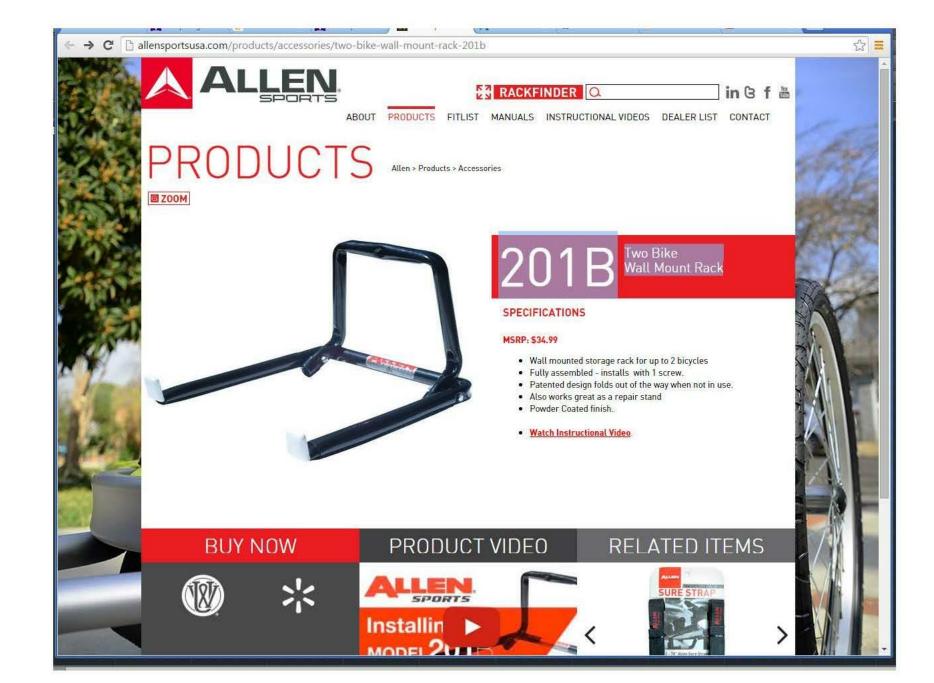
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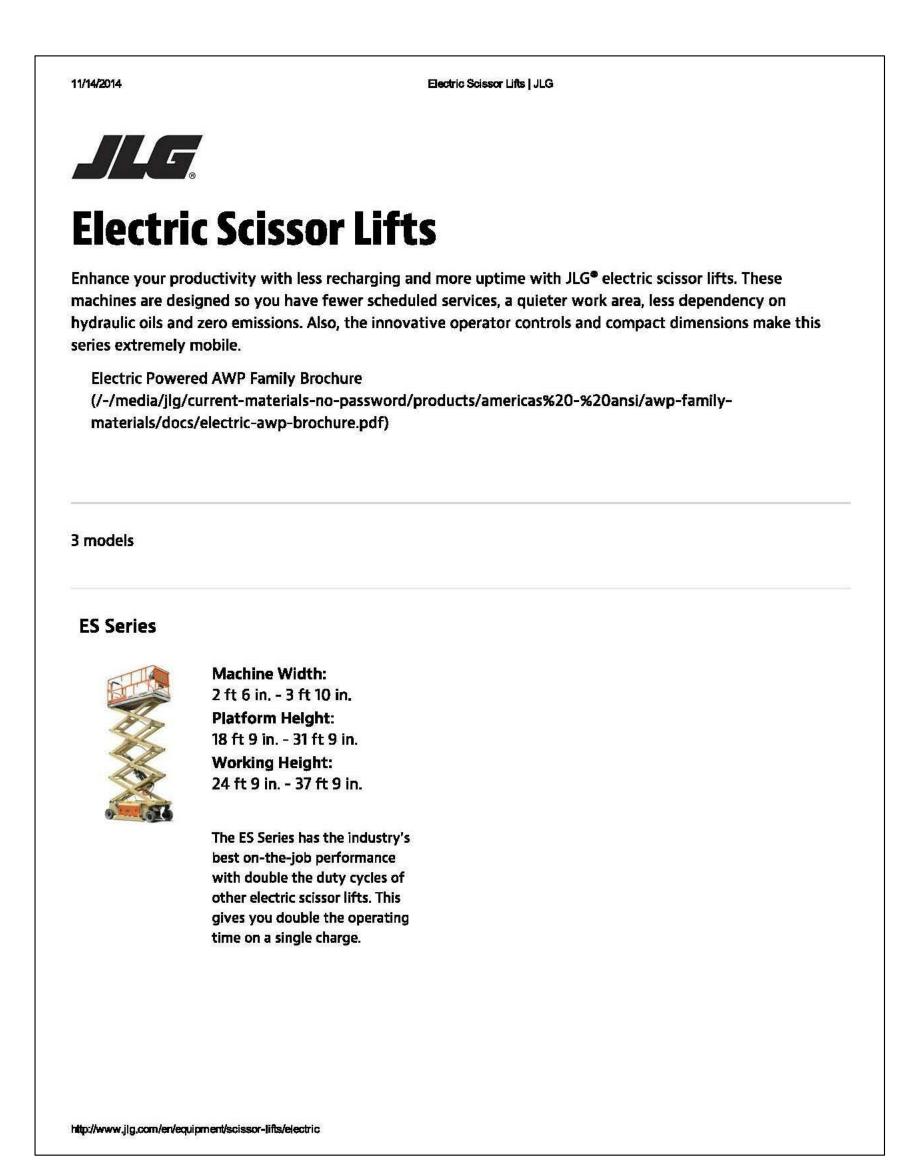
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DRAWING TITLE FIRST FLOOR PLAN-DIMENSIONAL


**a** 6/29/2015 100701



Bike Hook Specification



MOBILE SCISSOR LIFT

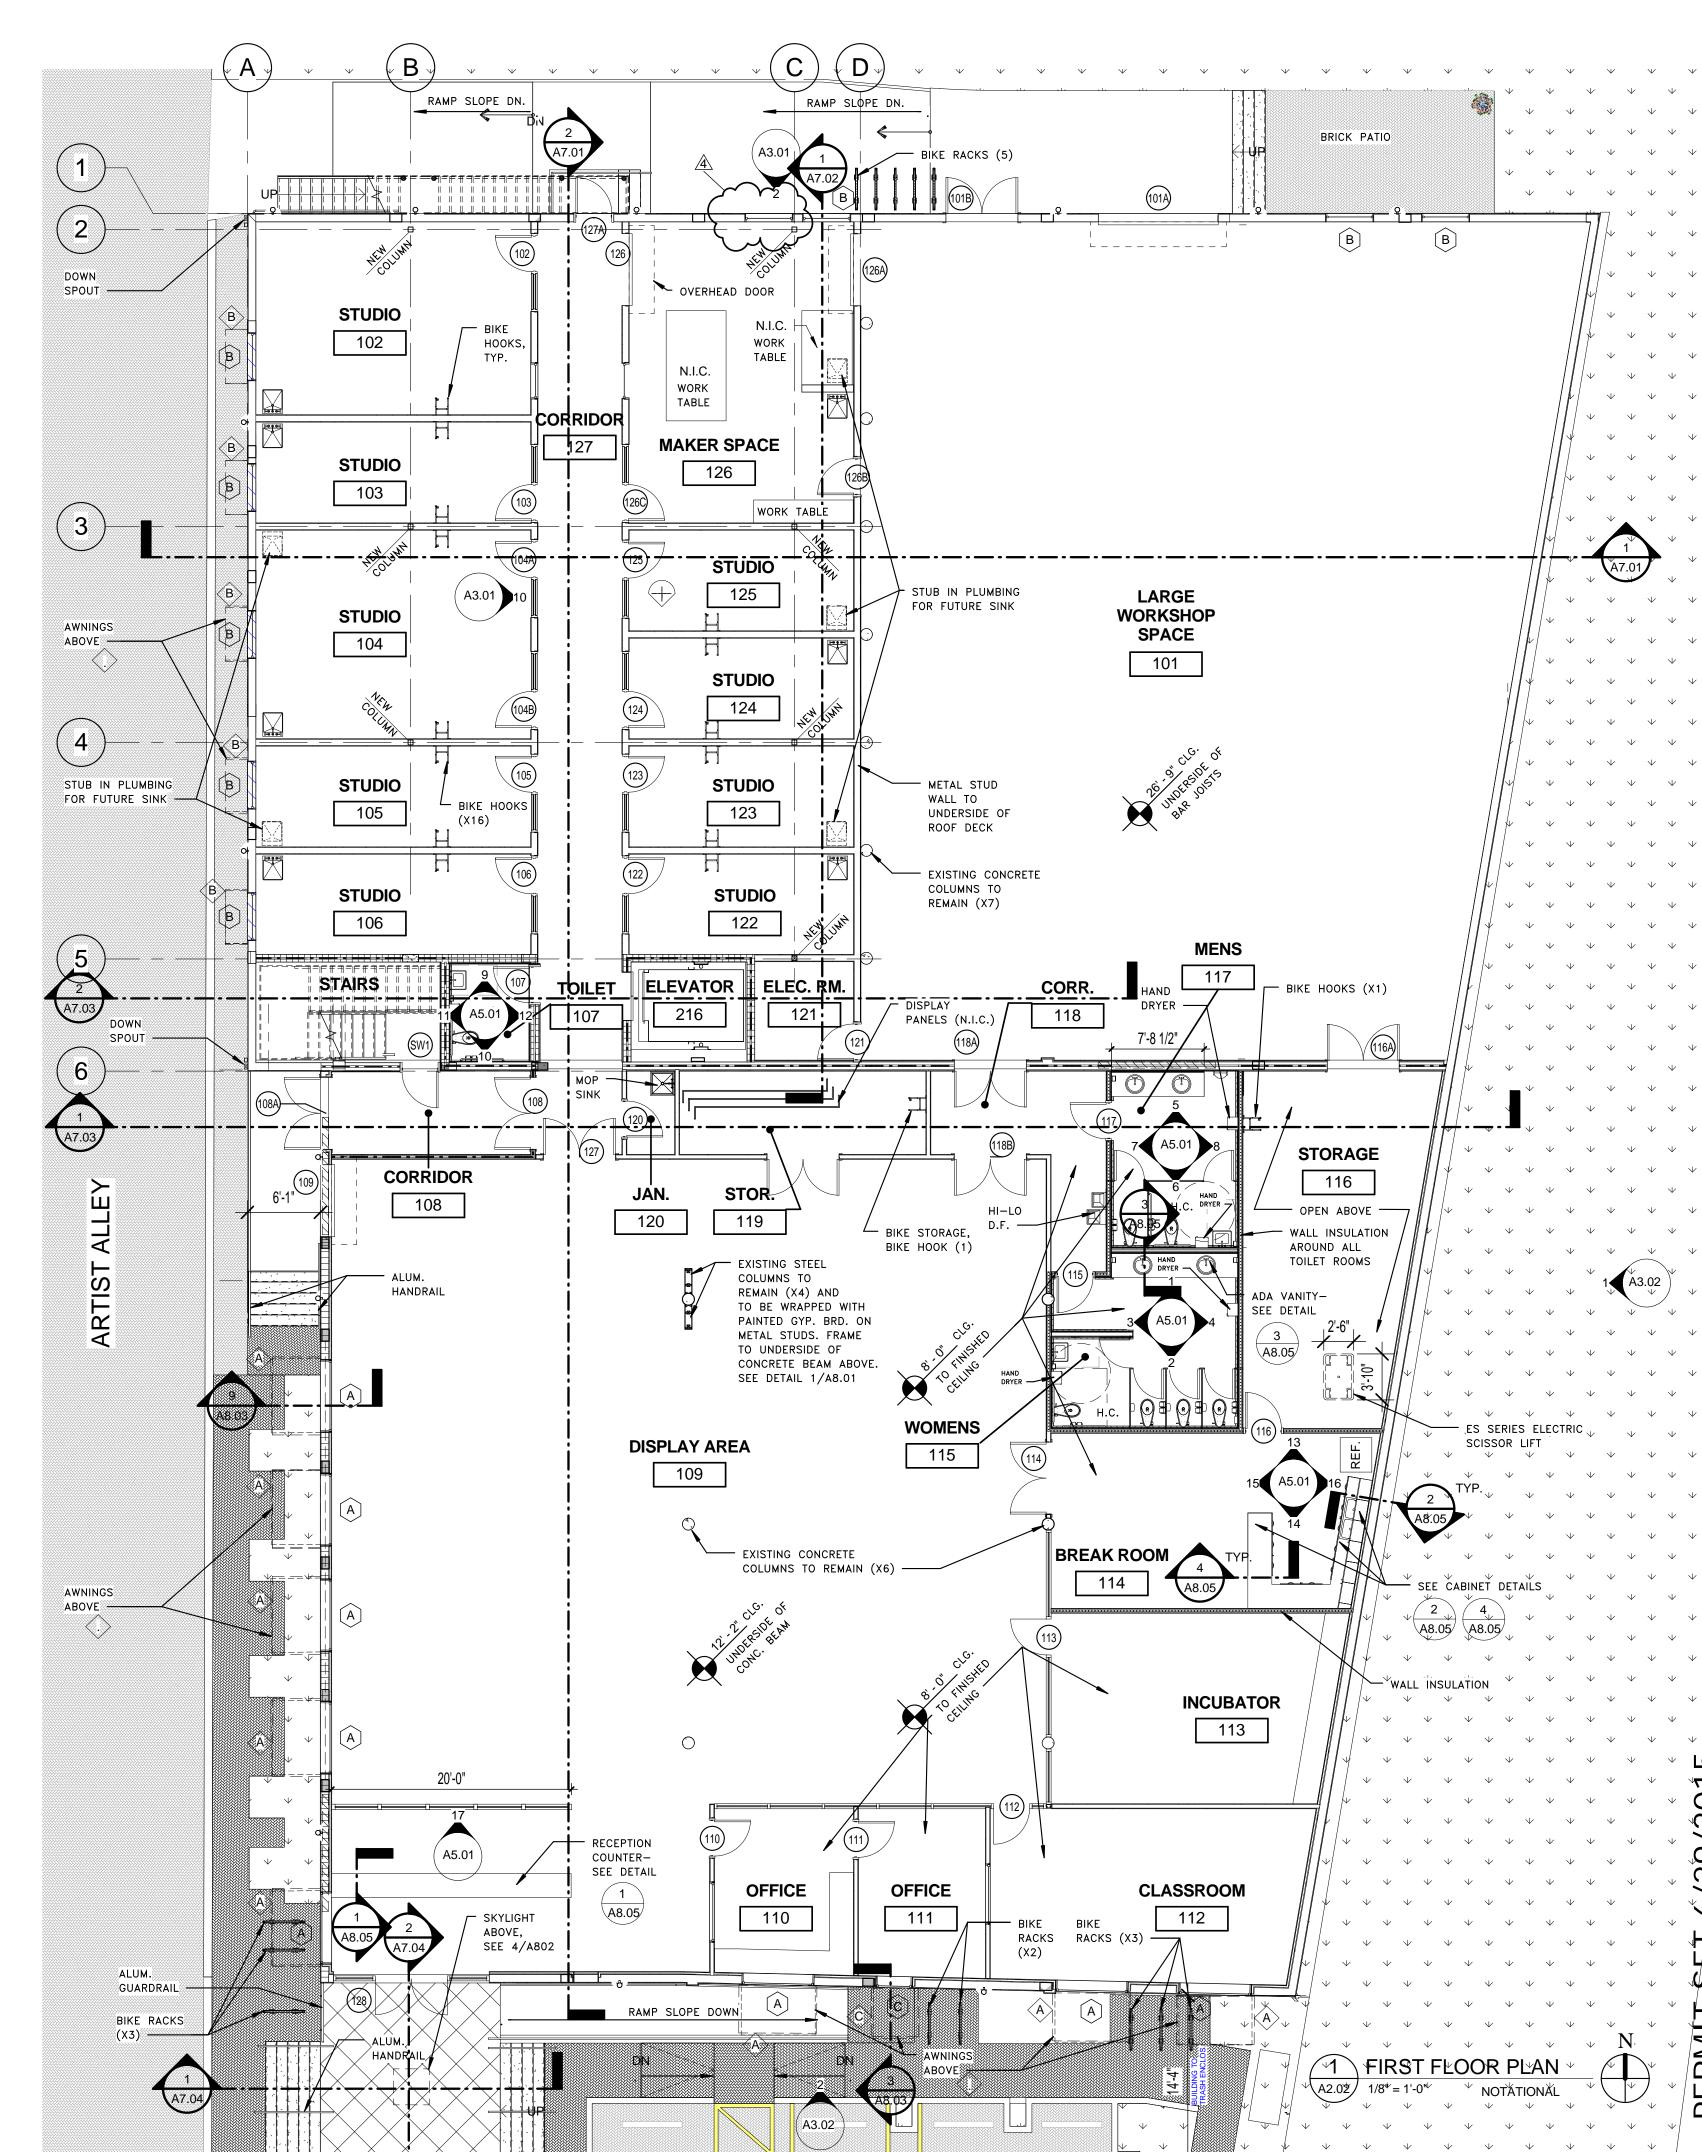



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**AGUILA** architects

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Sustainable Design AA26001584

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SEAL

PROJECT TITLE

Art Warehouse Renovation

313 NE 3rd Street, Delray Beach, Florida 33444

 REVISIONS

 NUM.
 DESCRIPTION
 DATE

 1
 Bidg. Dept. comments
 8/21/2015

 4
 Bidg. Dept. Cmnts
 1/19/2016

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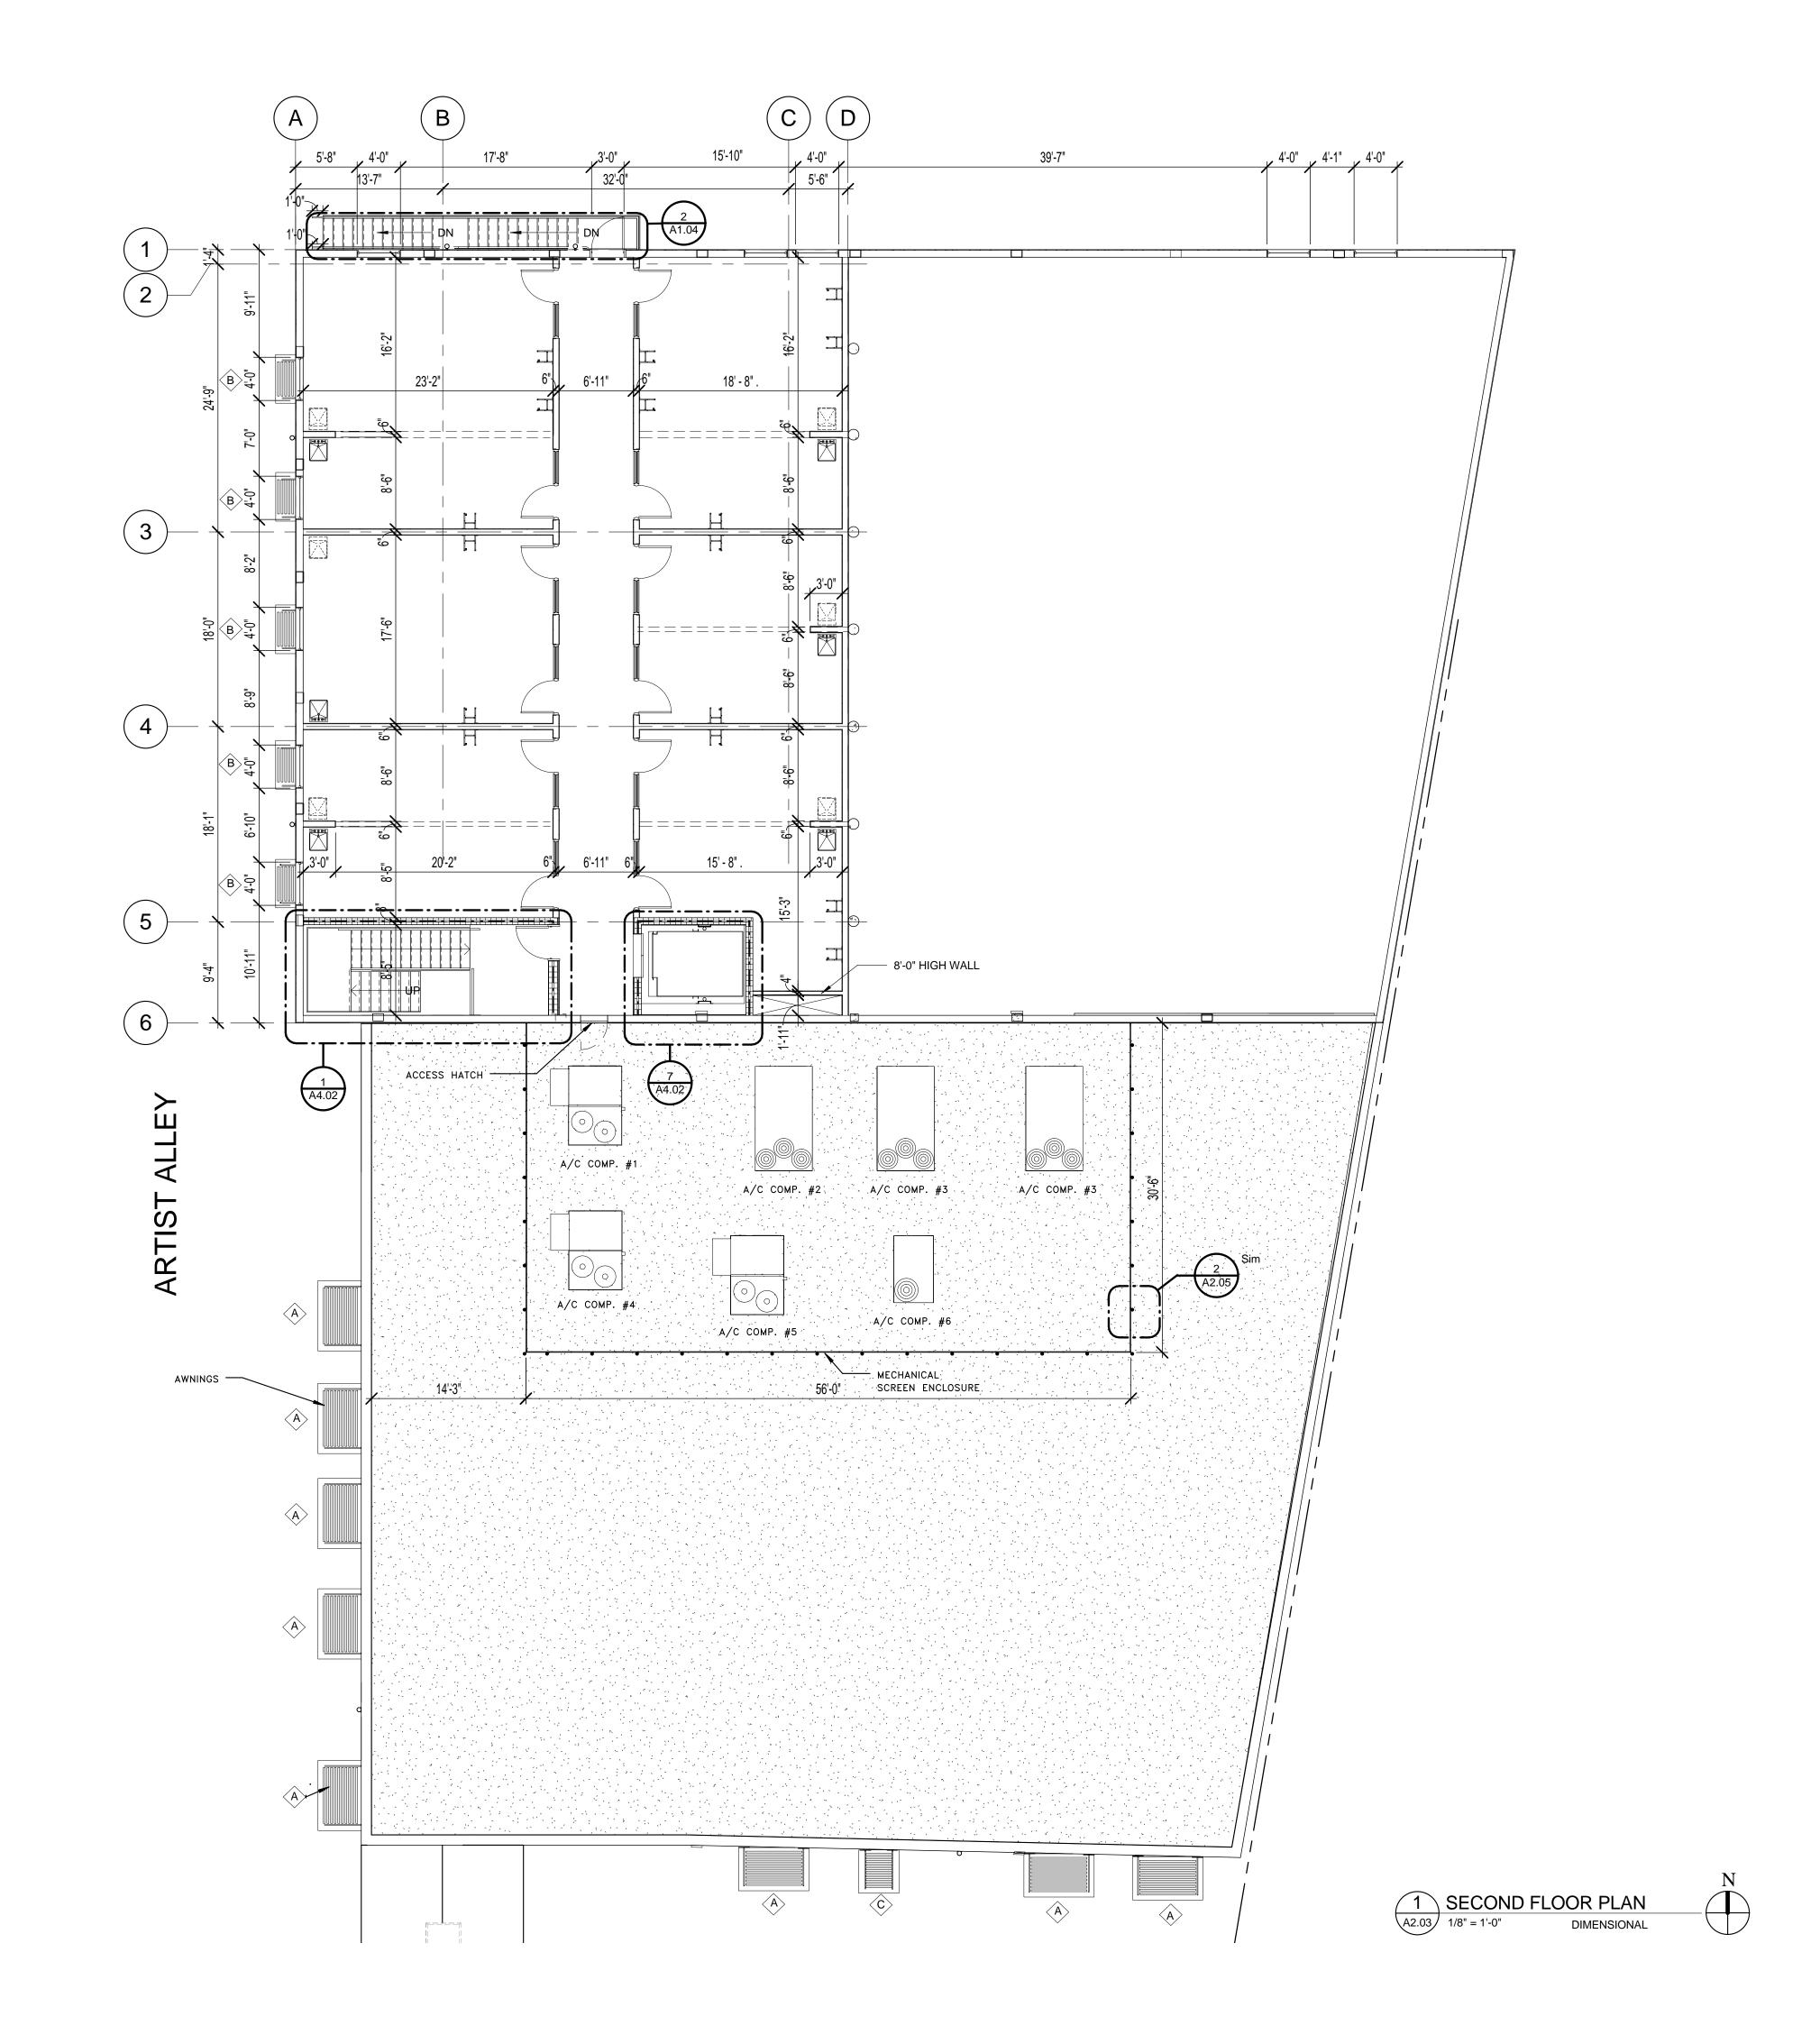
FIRST FLOOR
PLANNOTATIONAL

DATE DRAWN BY 6/29/2015 IG,JC,MM

JOB NUMBER
100701

DRAWING NUMBER

A2.02





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Architecture, Planning, Interiors, & Sustainable Design AA26001584 185 NE 4TH AVENUE SUITE 101

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313 NE 3rd Street, Delray Beach, Florida 33444

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1 Bldg. Dept. comments 8/21/
2015


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6/29/2015 FN/JC

100701 PERMI





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CENTRAL\_jim@csa-architects.com.rvt

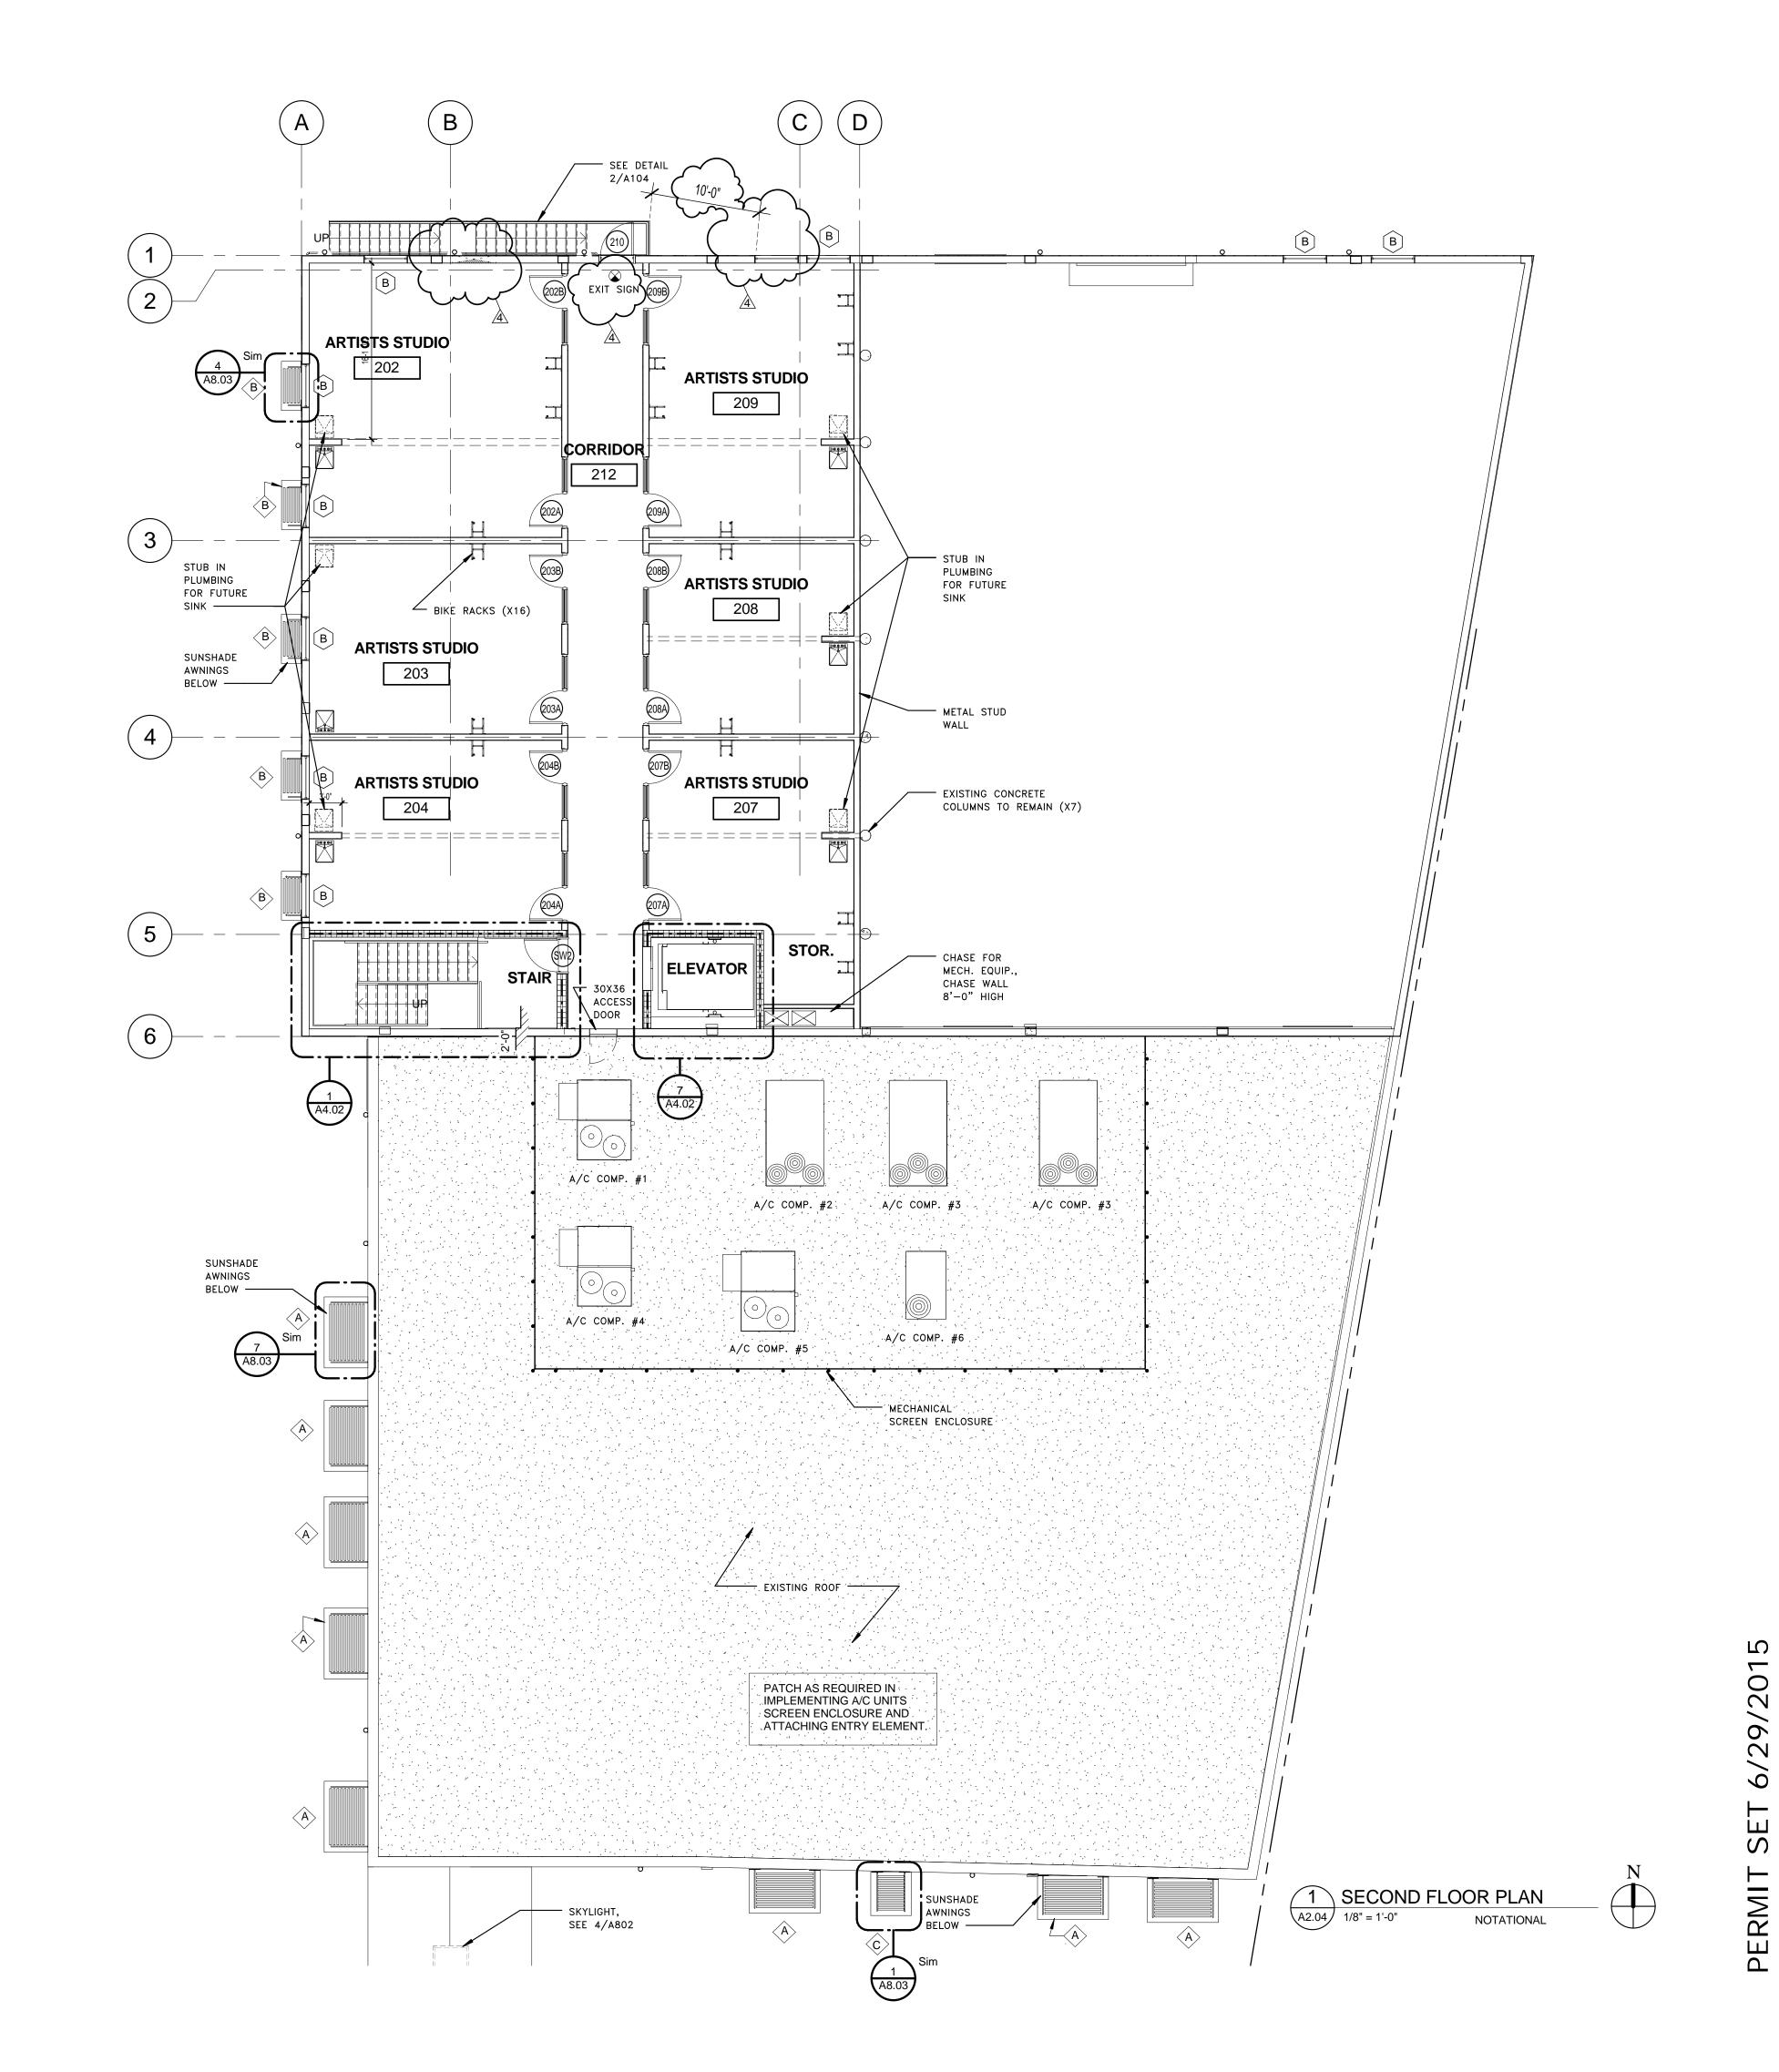DRAWING TITLE

SECOND FLOOR O PLAN-NOTATIONAL

6/29/2015 100701



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E-MAIL: office@csa-architects.com

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PROOF PLAN


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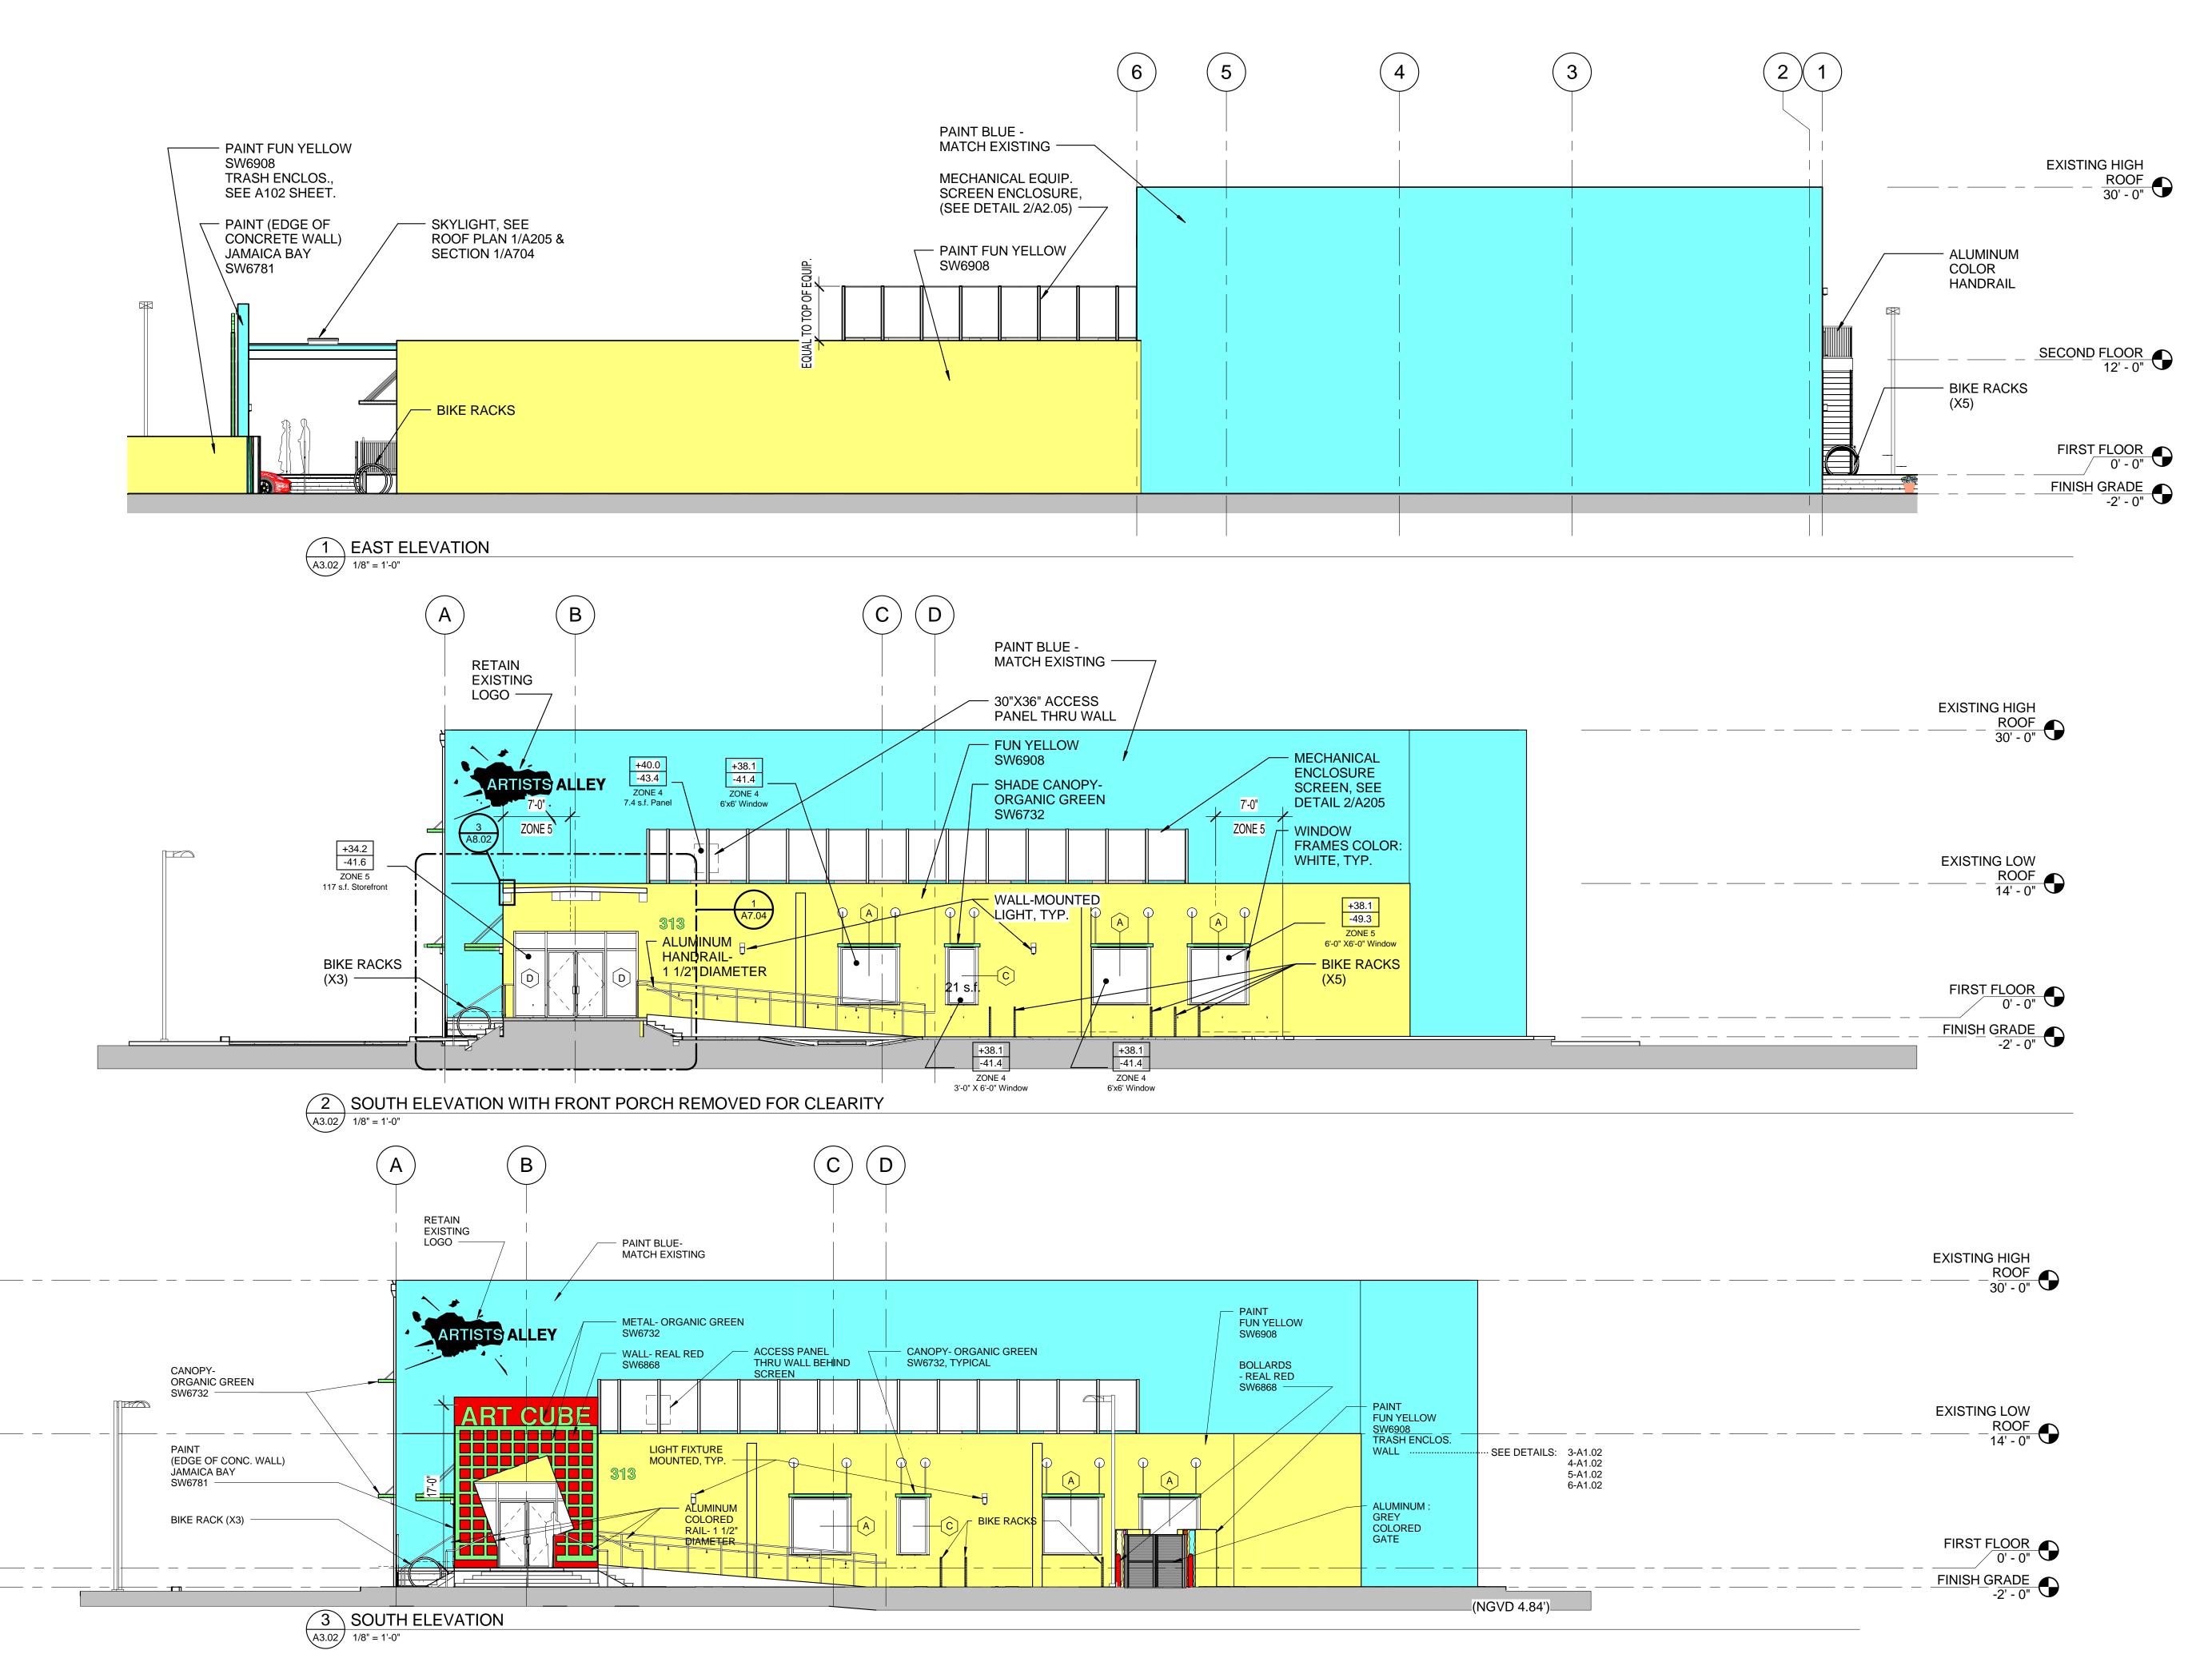
DATE
6/29/2015 JC

JOB NUMBER
100701

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DATE

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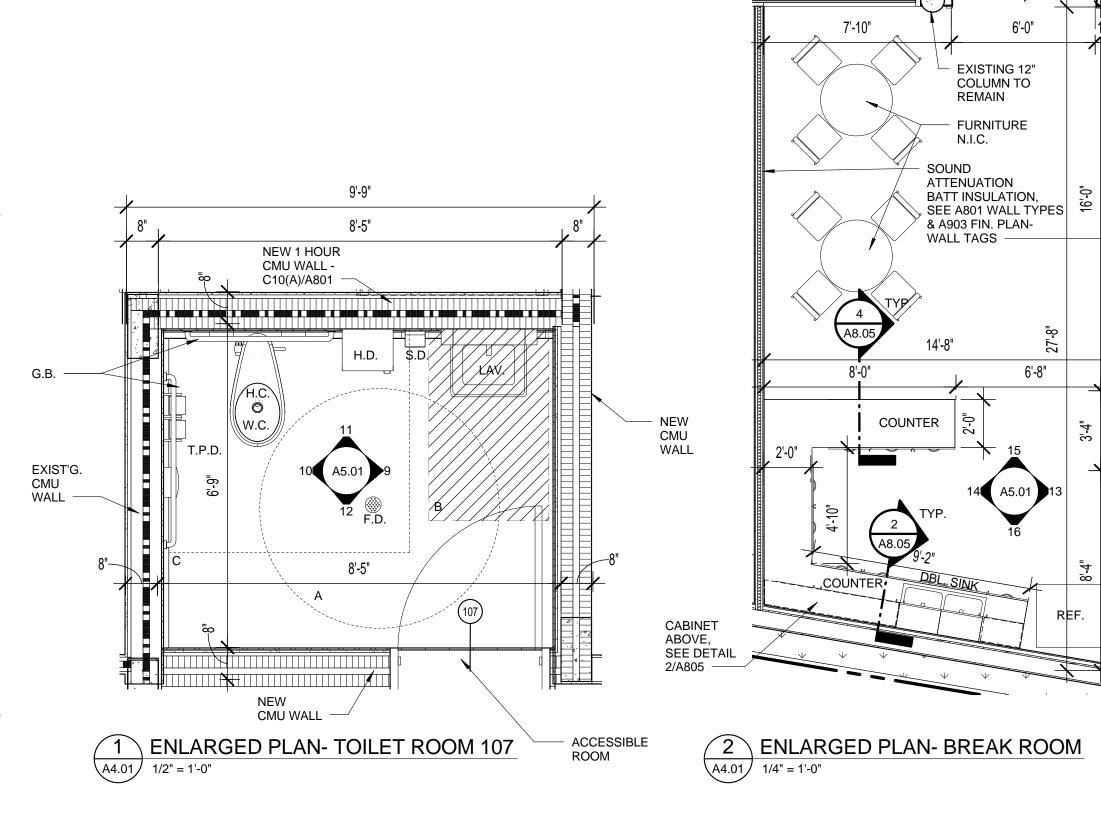
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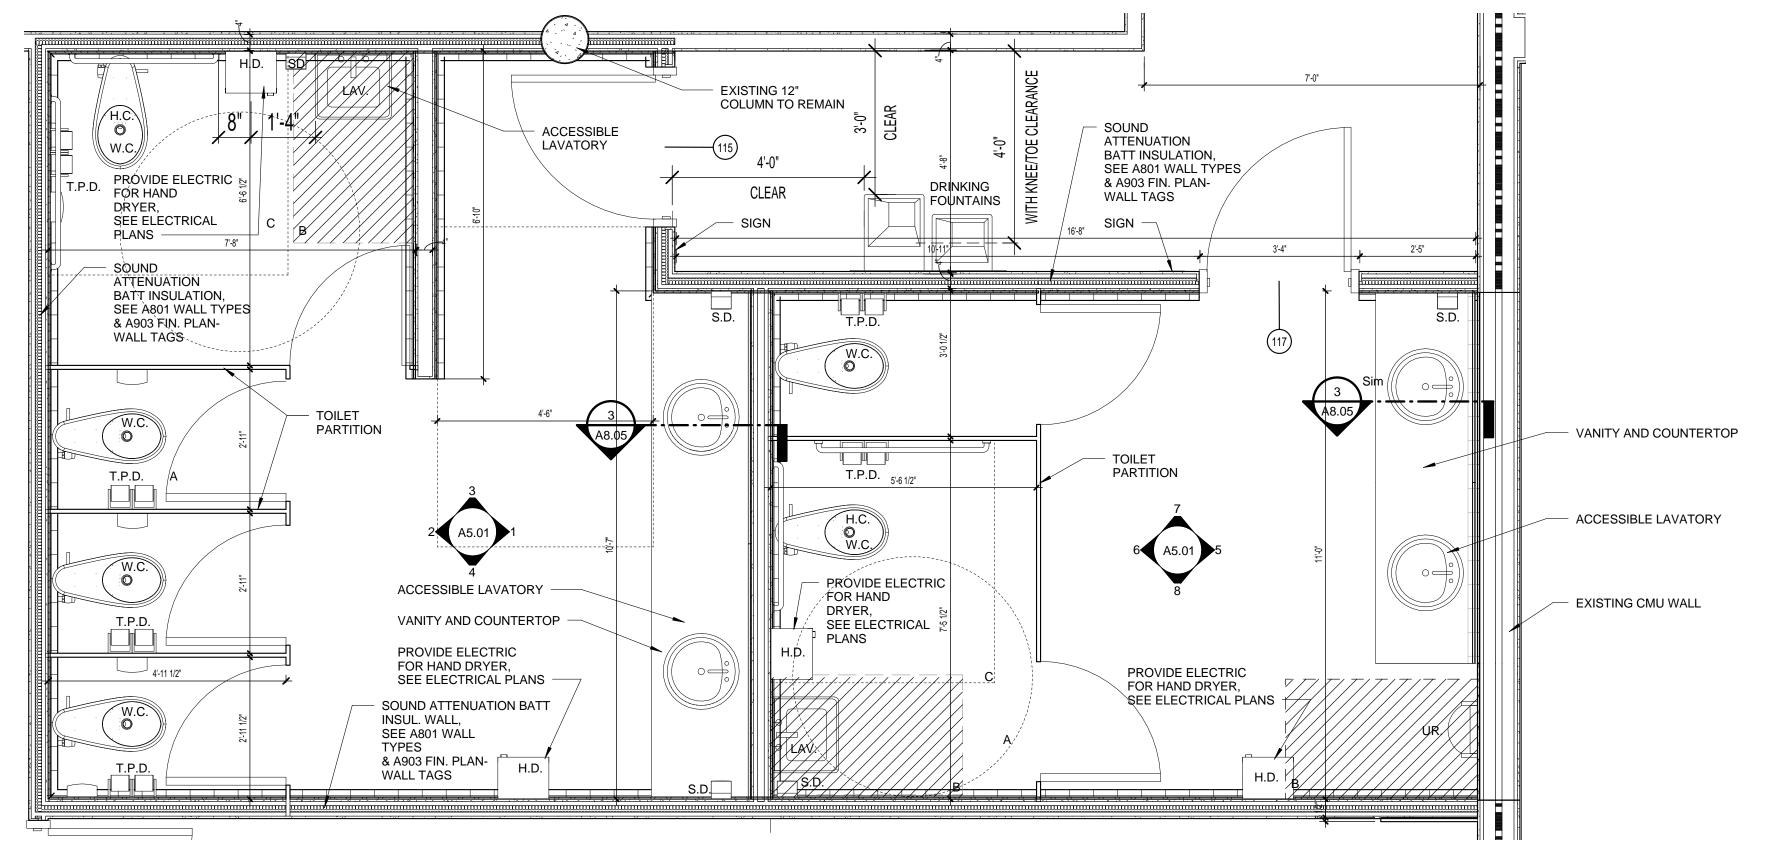
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A3.02



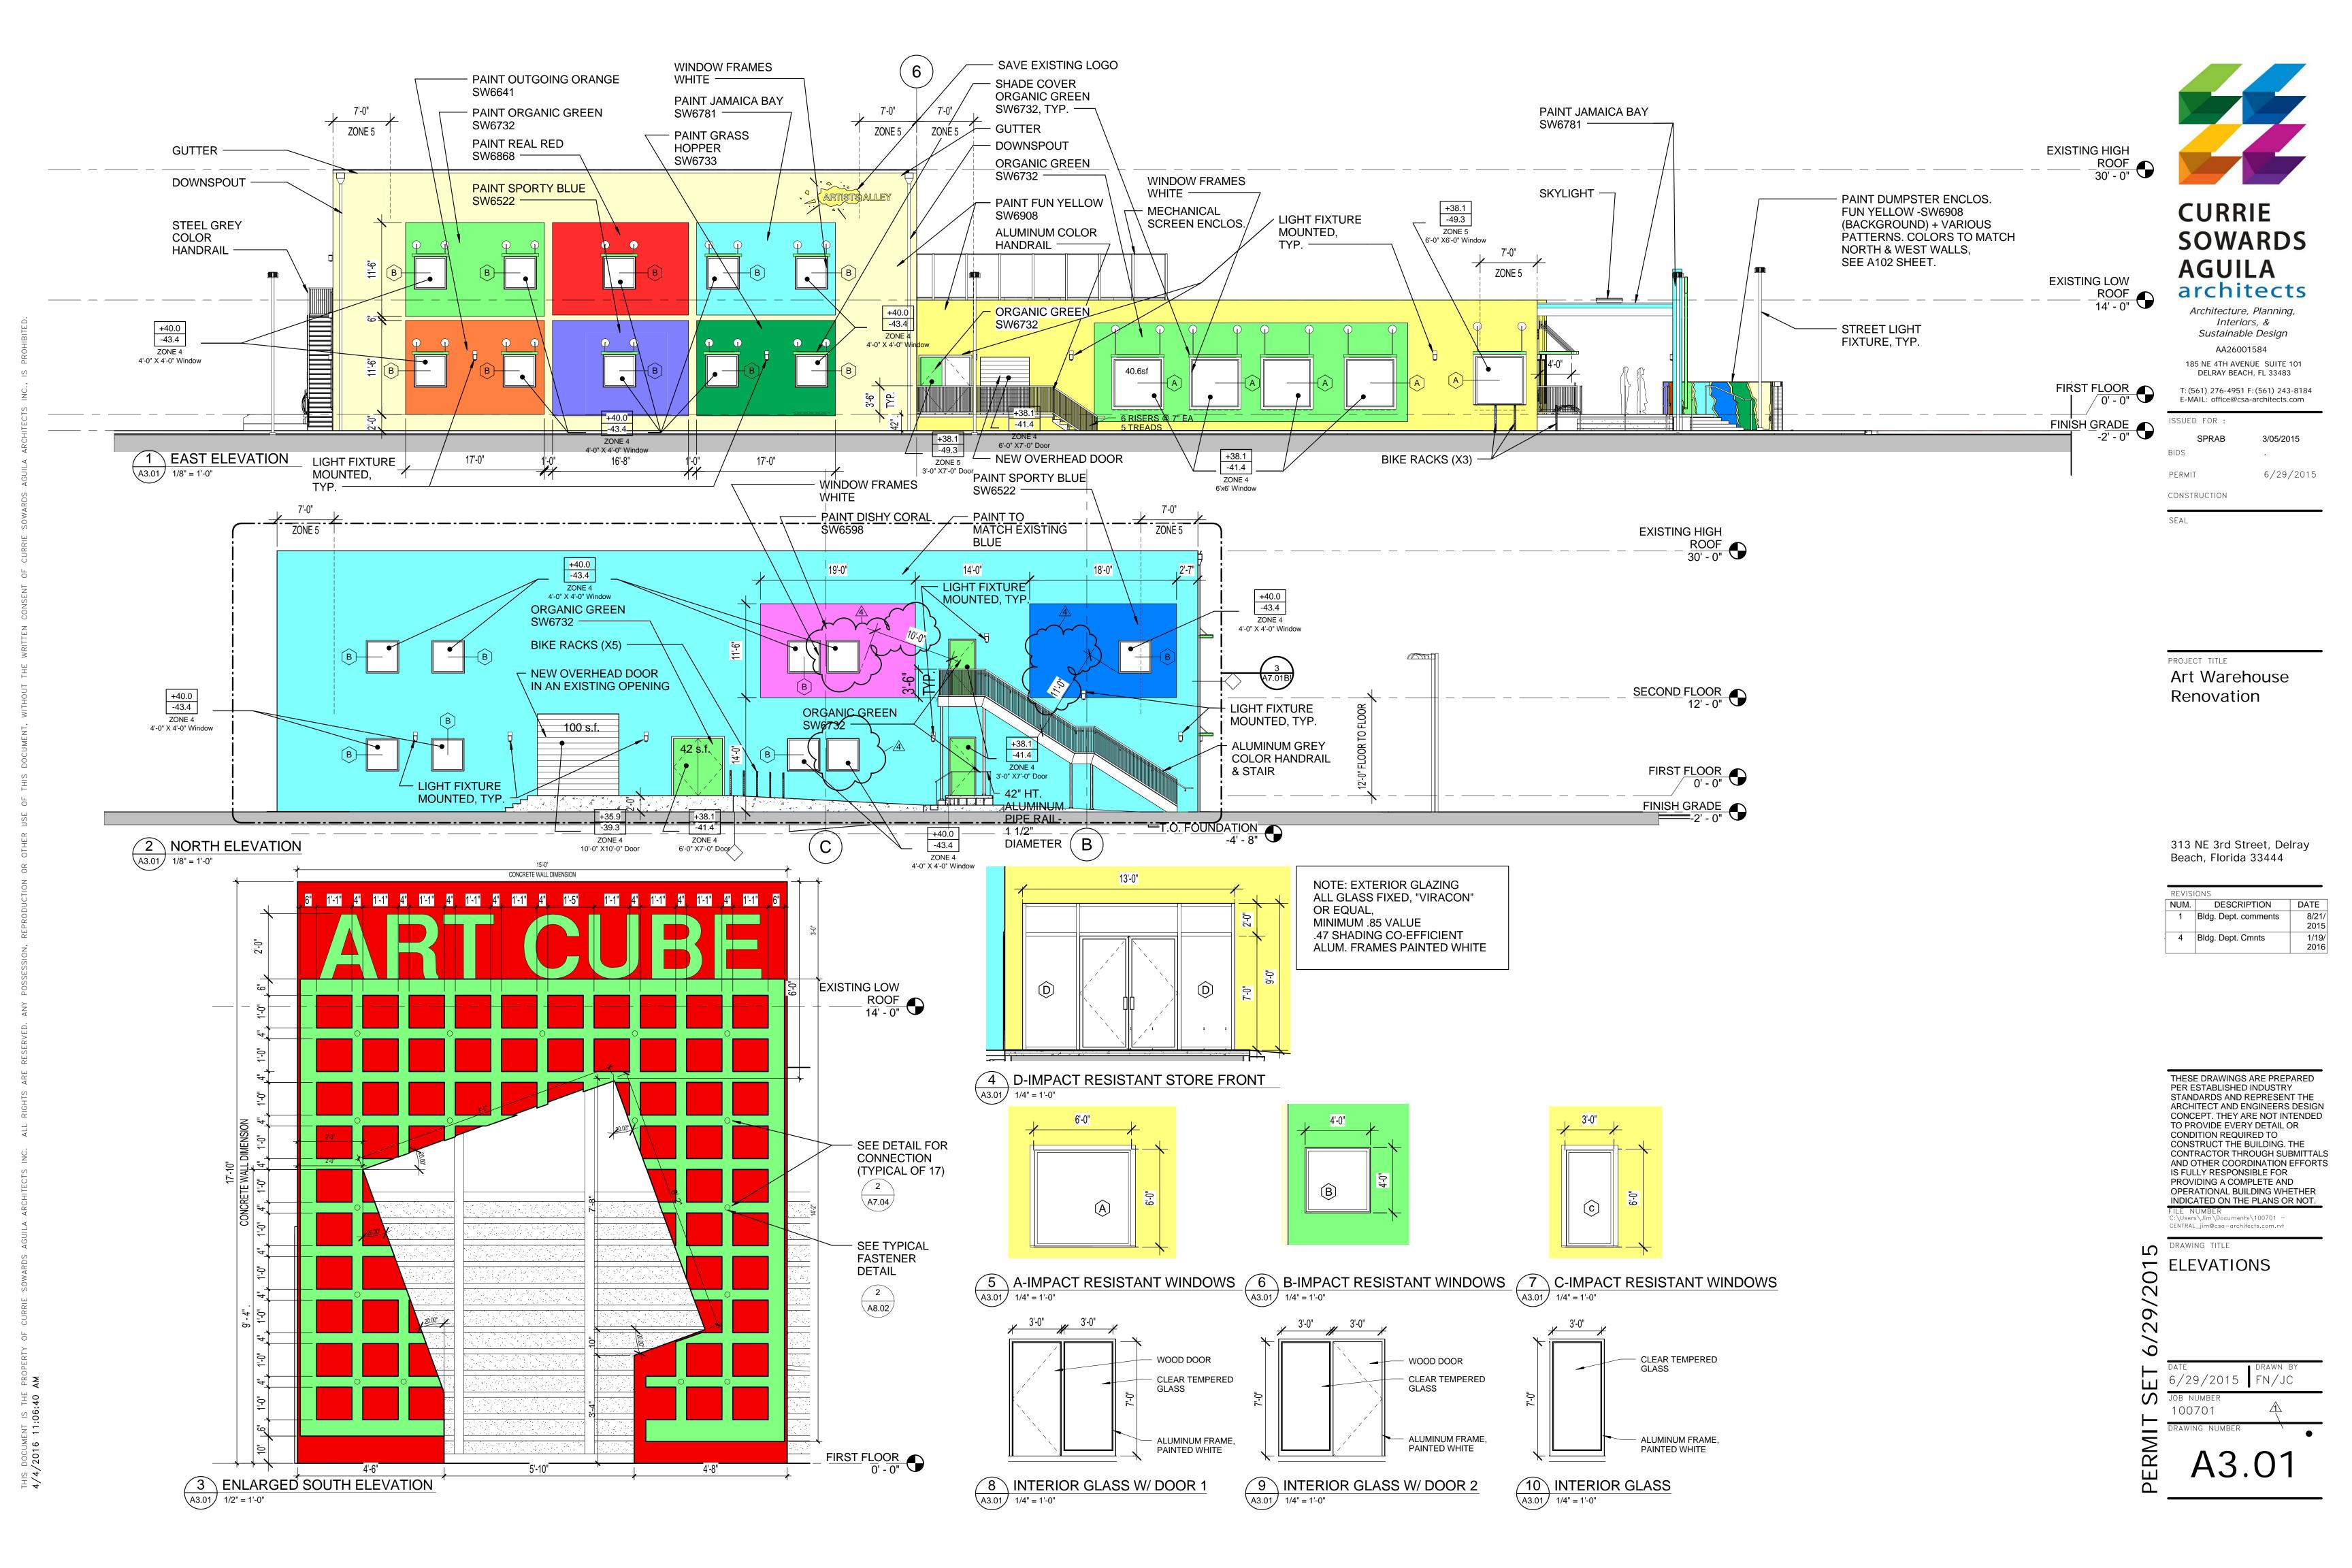

EMERGENCY LIGHT FIXTURE, FIRE ALARM, AUDIO VISUAL DEVICE

ALARM PULL STATION

RECEPTACLES \_\_\_\_\_

SWITCHES, FIRE

- THERMOSTAT

NOTE: WHERE MORE THAN ONE ITEM APPEARS IN PLAN AT

SAME LOCATION, THEY SHALL BE VERTICALLY CENTERED.

/OUTLETS

FIRE

NAPKIN 5

**CURRIE SOWARDS** AGUILA architects Architecture, Planning, Interiors, & Sustainable Design AA26001584 185 NE 4TH AVENUE SUITE 101 DELRAY BEACH, FL 33483 T: (561) 276-4951 F: (561) 243-8184 E-MAIL: office@csa-architects.com ISSUED FOR : 3/05/2015 PERMIT 6/29/2015 CONSTRUCTION SEAL

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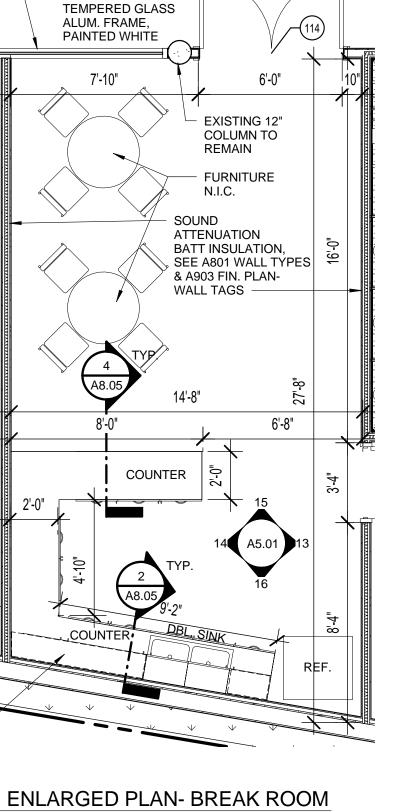
#### **GENERAL NOTES:**

COMPLIANT TO BE INSTALLED PER

ABBREVIATIONS / FIXTURE LEGEND				
F.D.	FLOOR DRAIN			
H.C.	HANDICAP			
G.B.	GRAB BAR			
T.P.D.	DOUBLE SURFACE TOILET PAPER DISPENSER			
H.D.	HAND DRYER			
MIRR.	MIRROR			
LAV.	LAVATORY			
W.C.	WATER CLOSET			
UR.	URINAL			
S.D.	WALL MOUNTED SOAP DISPENSER			
S.S	STAINLESS STEEL SHELF			
P.T.D.	PAPER TOWEL DISPENSER			
·				

1. ACCESSIBLE CLEAR FLOOR AREAS 'A' 60" DIA. CLEAR FLOOR TURNAROUND 'B' 30"x48" CLEAR FLOOR AREA 'C' 56"x60" WATER CLOSET SPACE 'D' 54" HINGE APPROACH, PULL SIDE, WITH 42" MIN CLEAR ON THE LATCH SIDE

2. ALL TOILET ACCESSORIES TO BE ADA MANUFACTURER'S PUBLISHED INSTRUCTIONS 6/29/2015 MM,JC



CLEAR FIXED TRANSPARENT




5'-0"

TYP. HANDICAP

RESTROOM

FIXTURE MOUNTING HTS

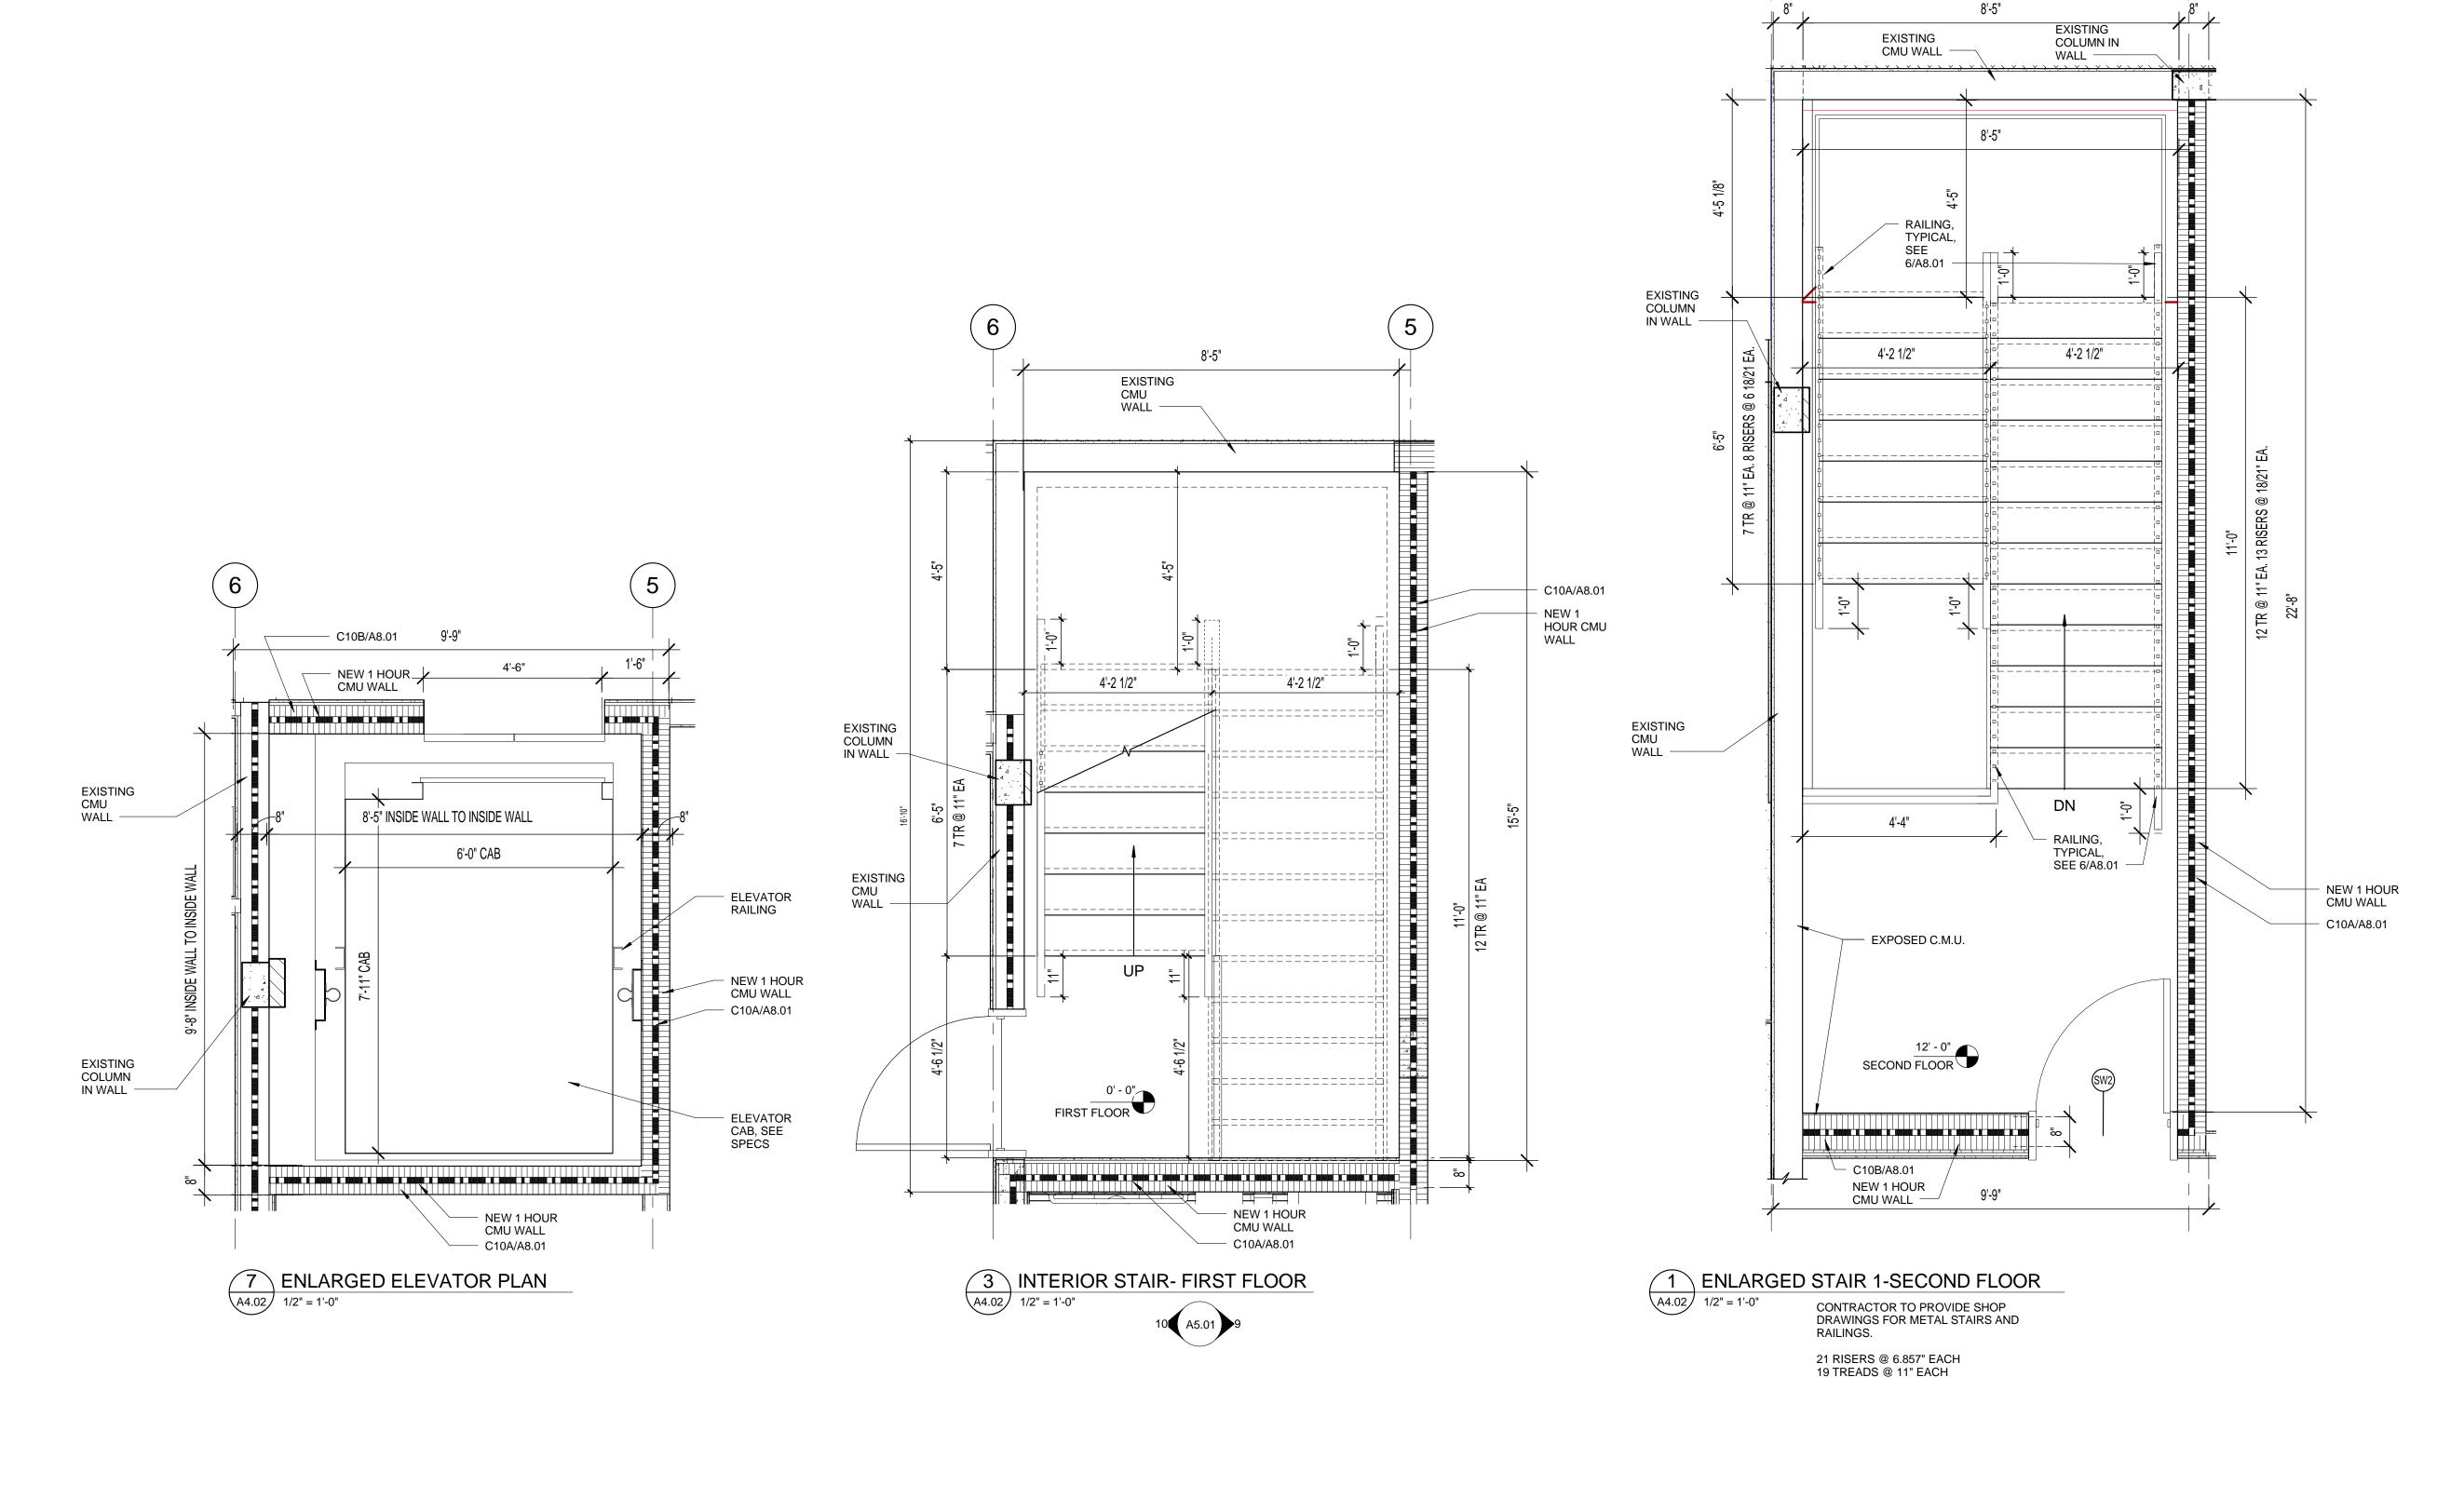



SOWARDS AGUILA architects

Interiors, & Sustainable Design AA26001584

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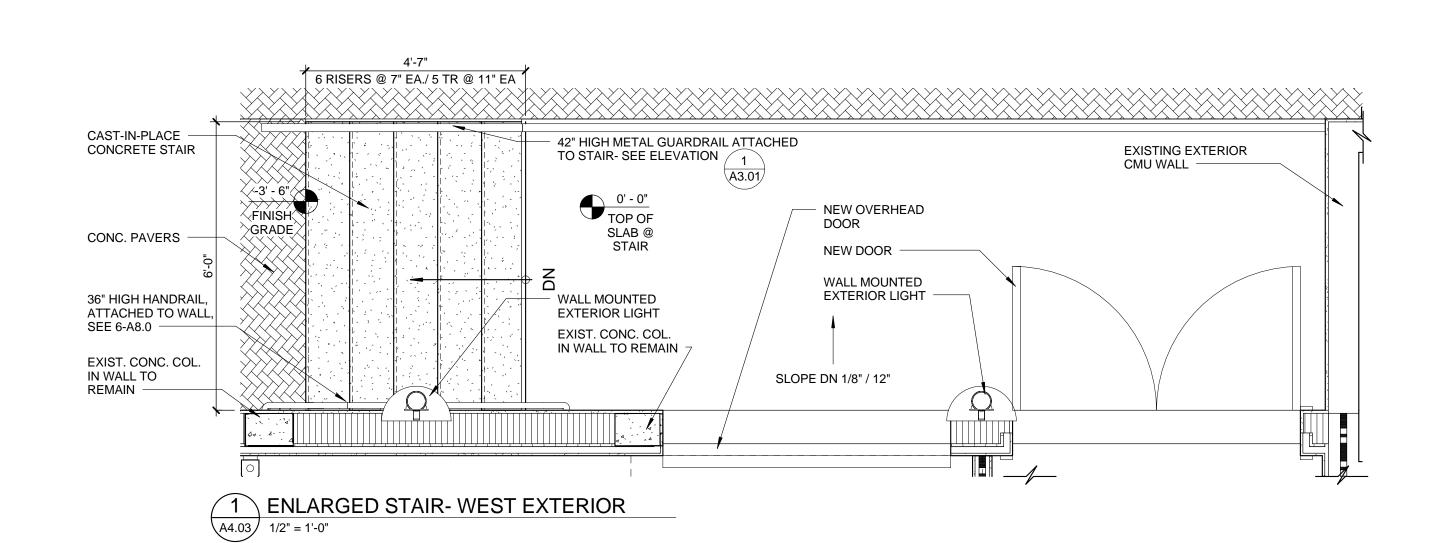
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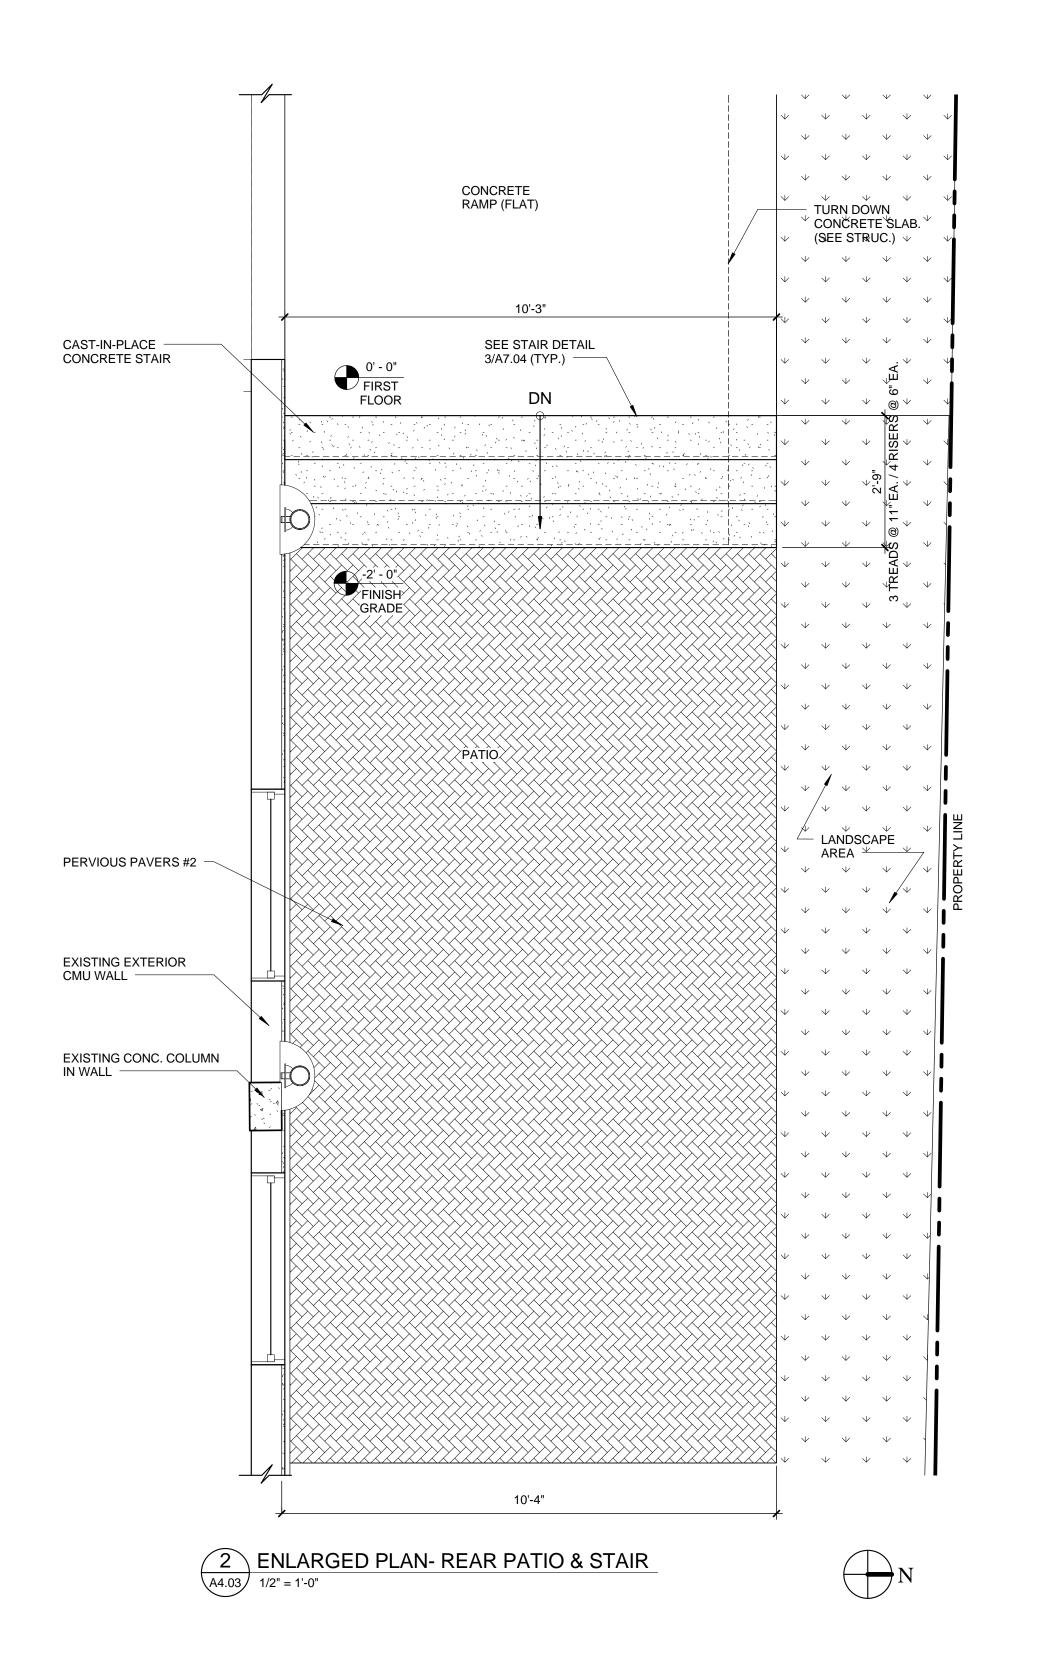
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A4.02







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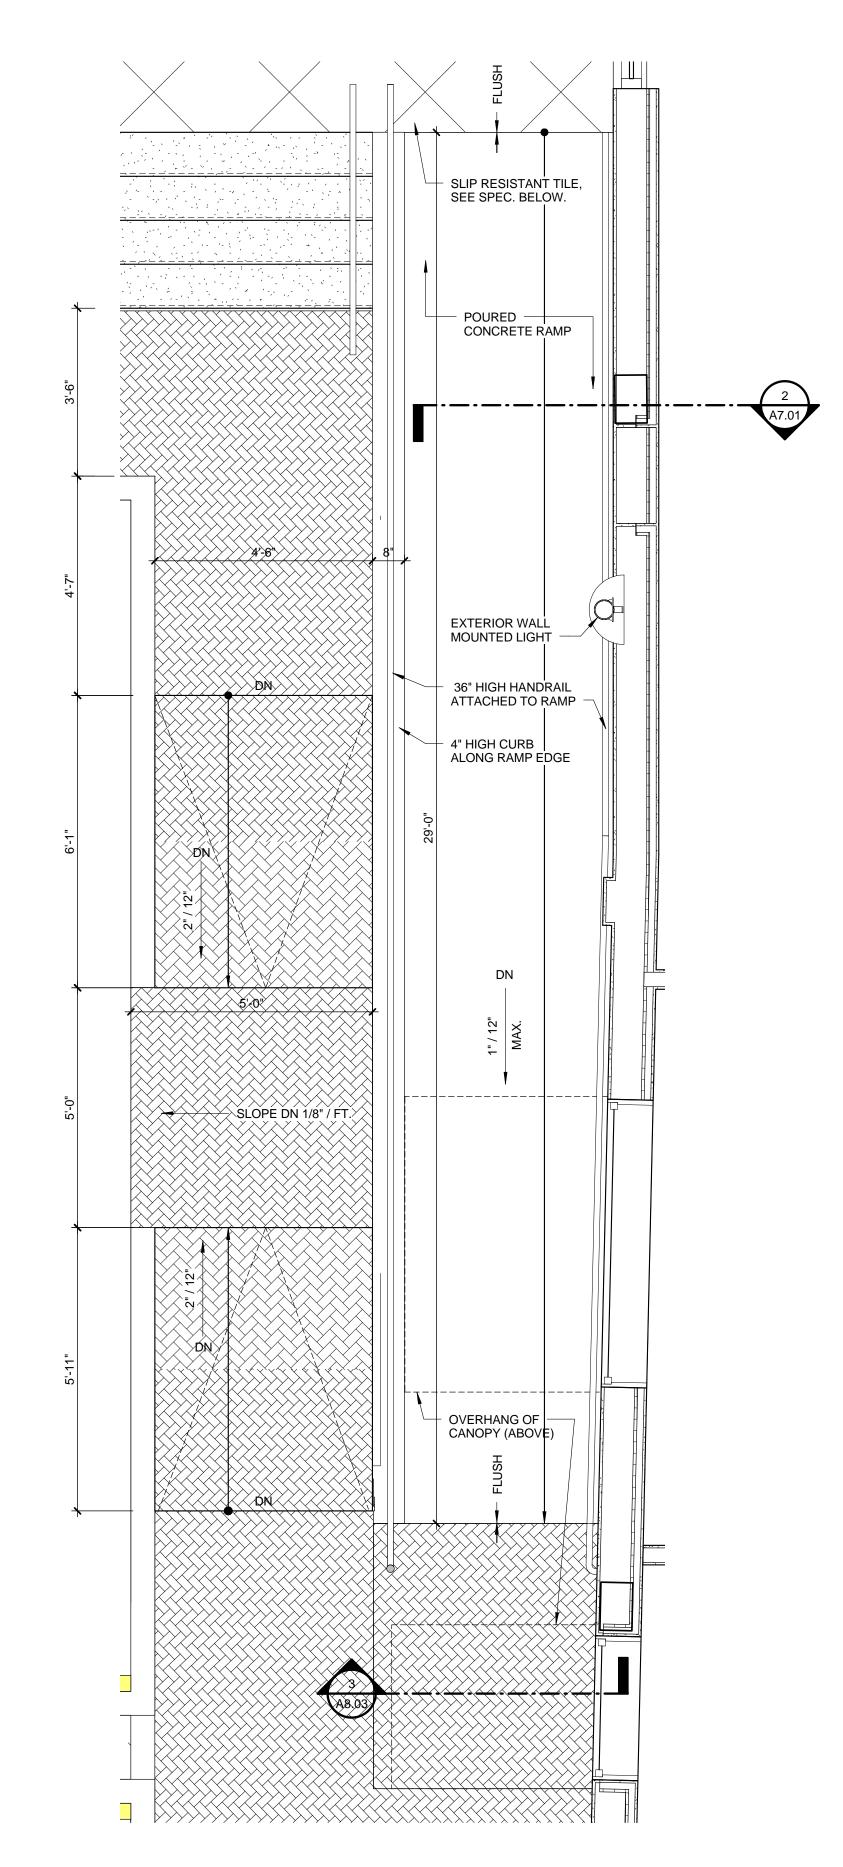
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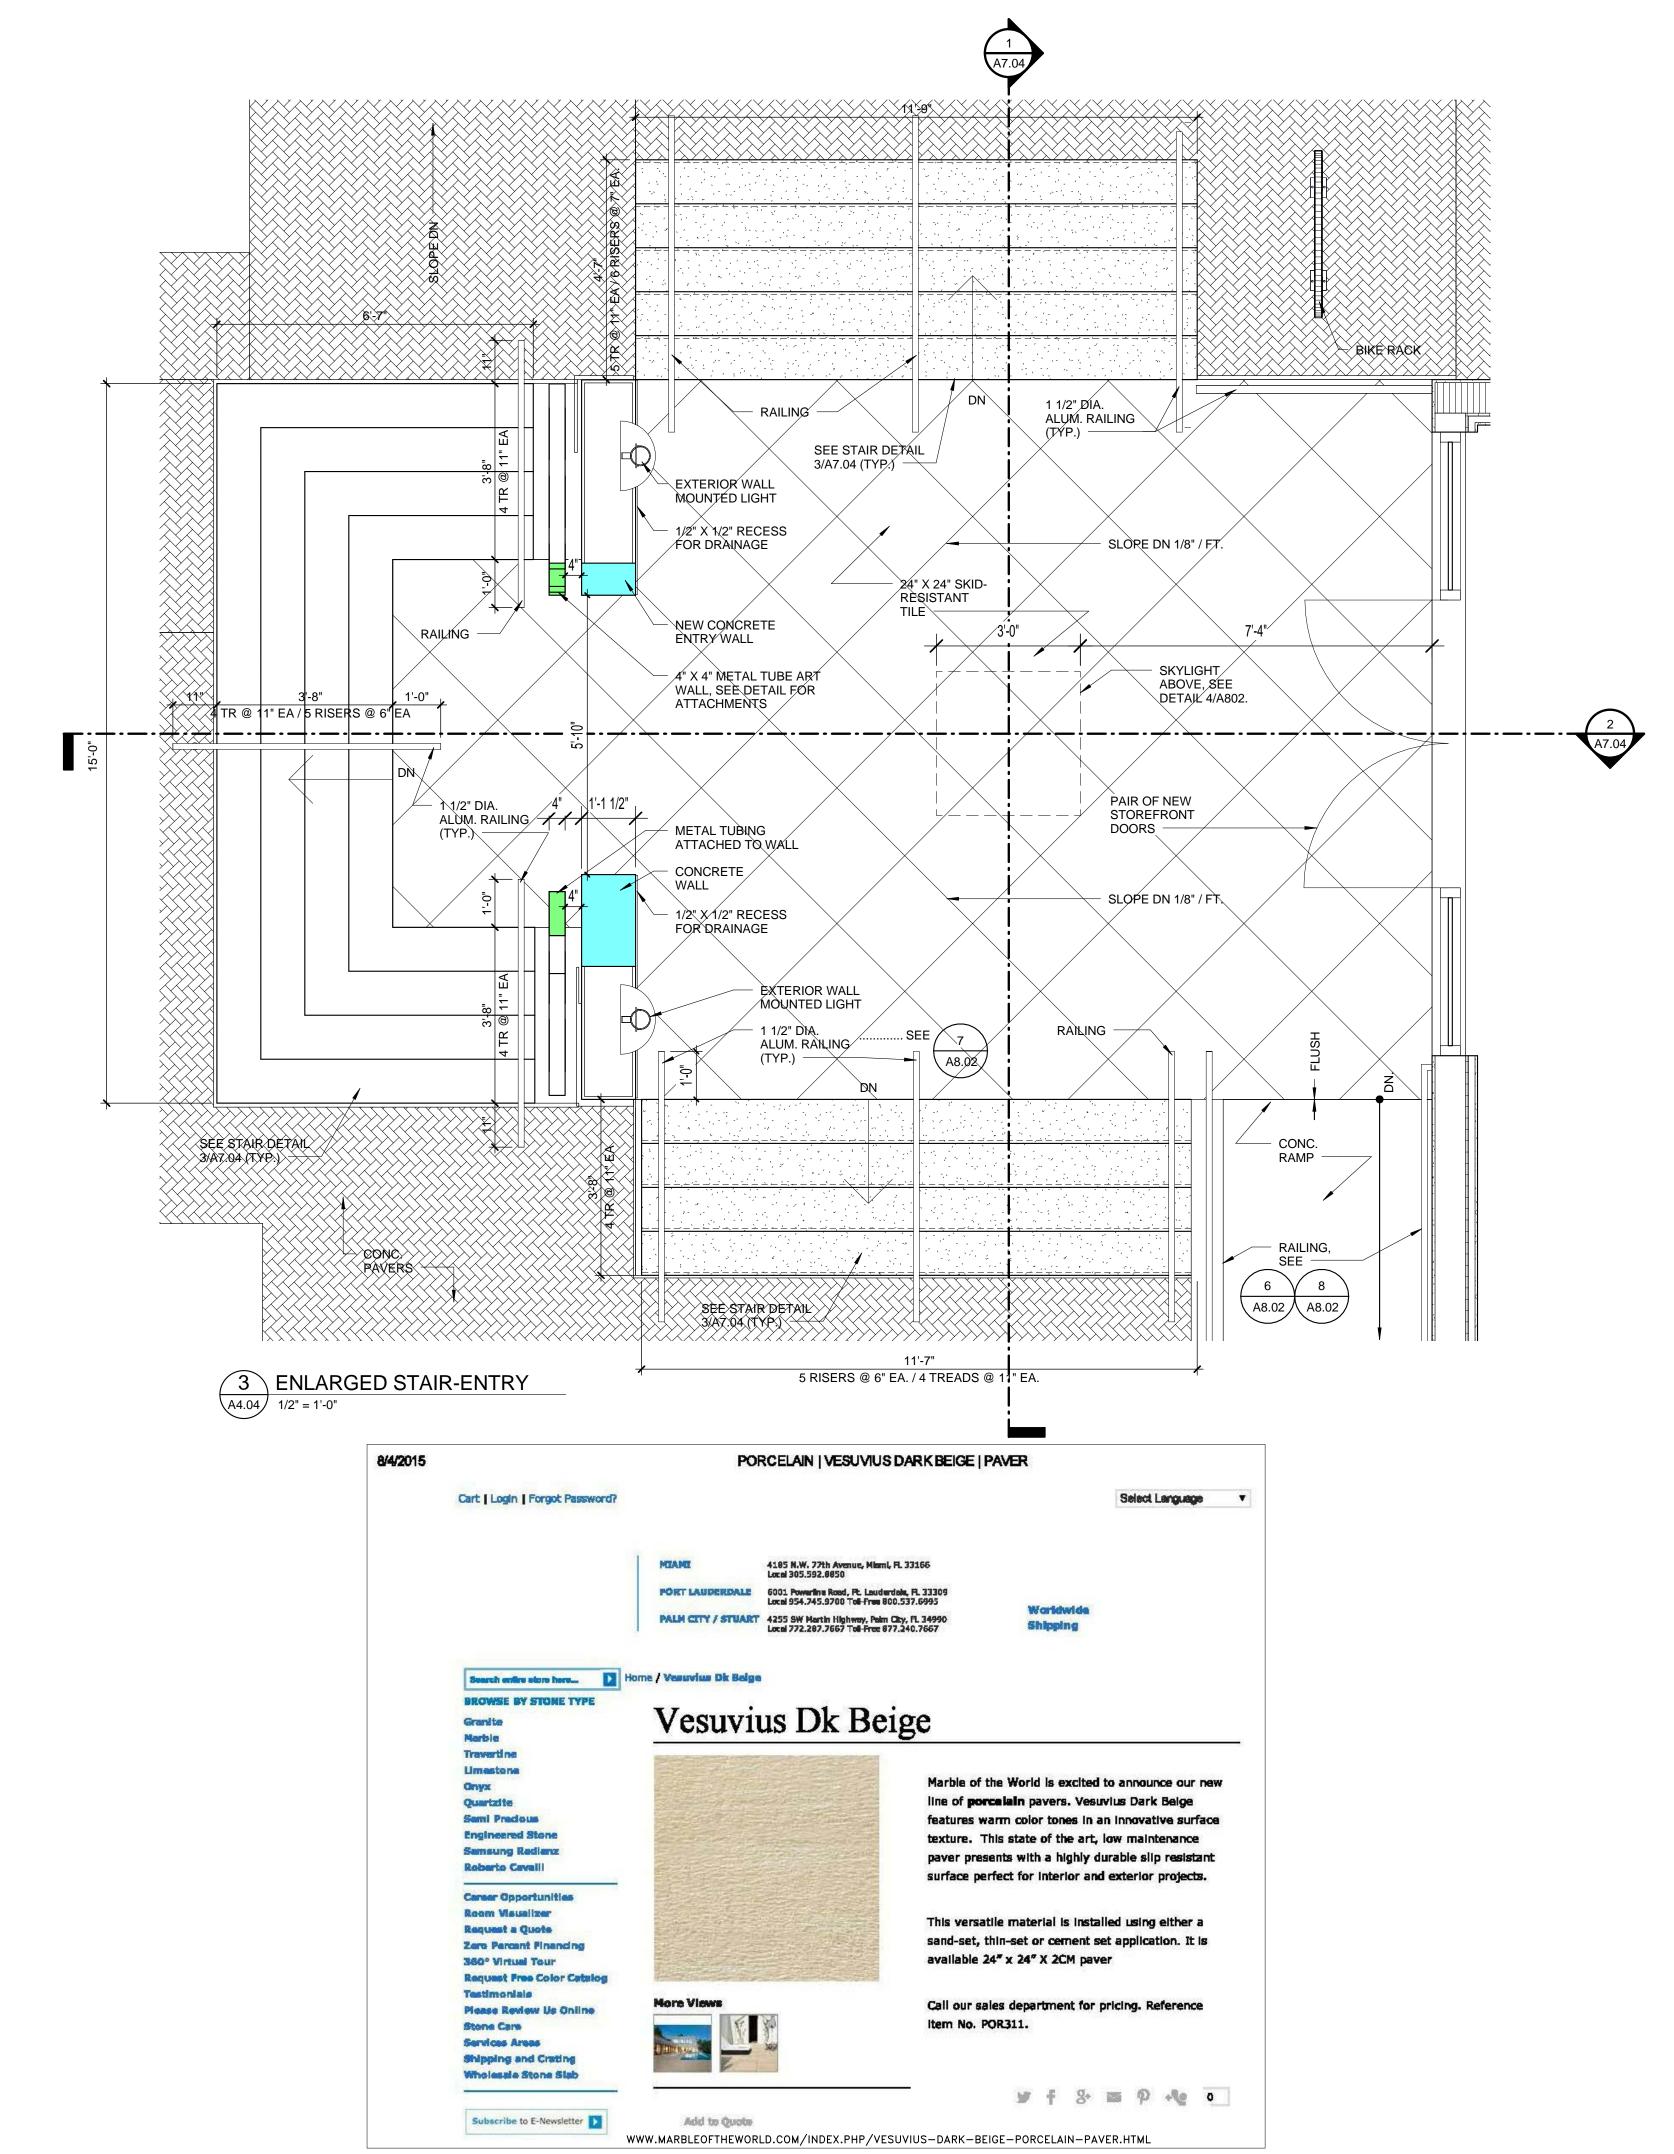
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A4.03



4 ENLARGED PLAN- RAMP
1/2" = 1'-0"





## CURRIE SOWARDS AGUILA architects

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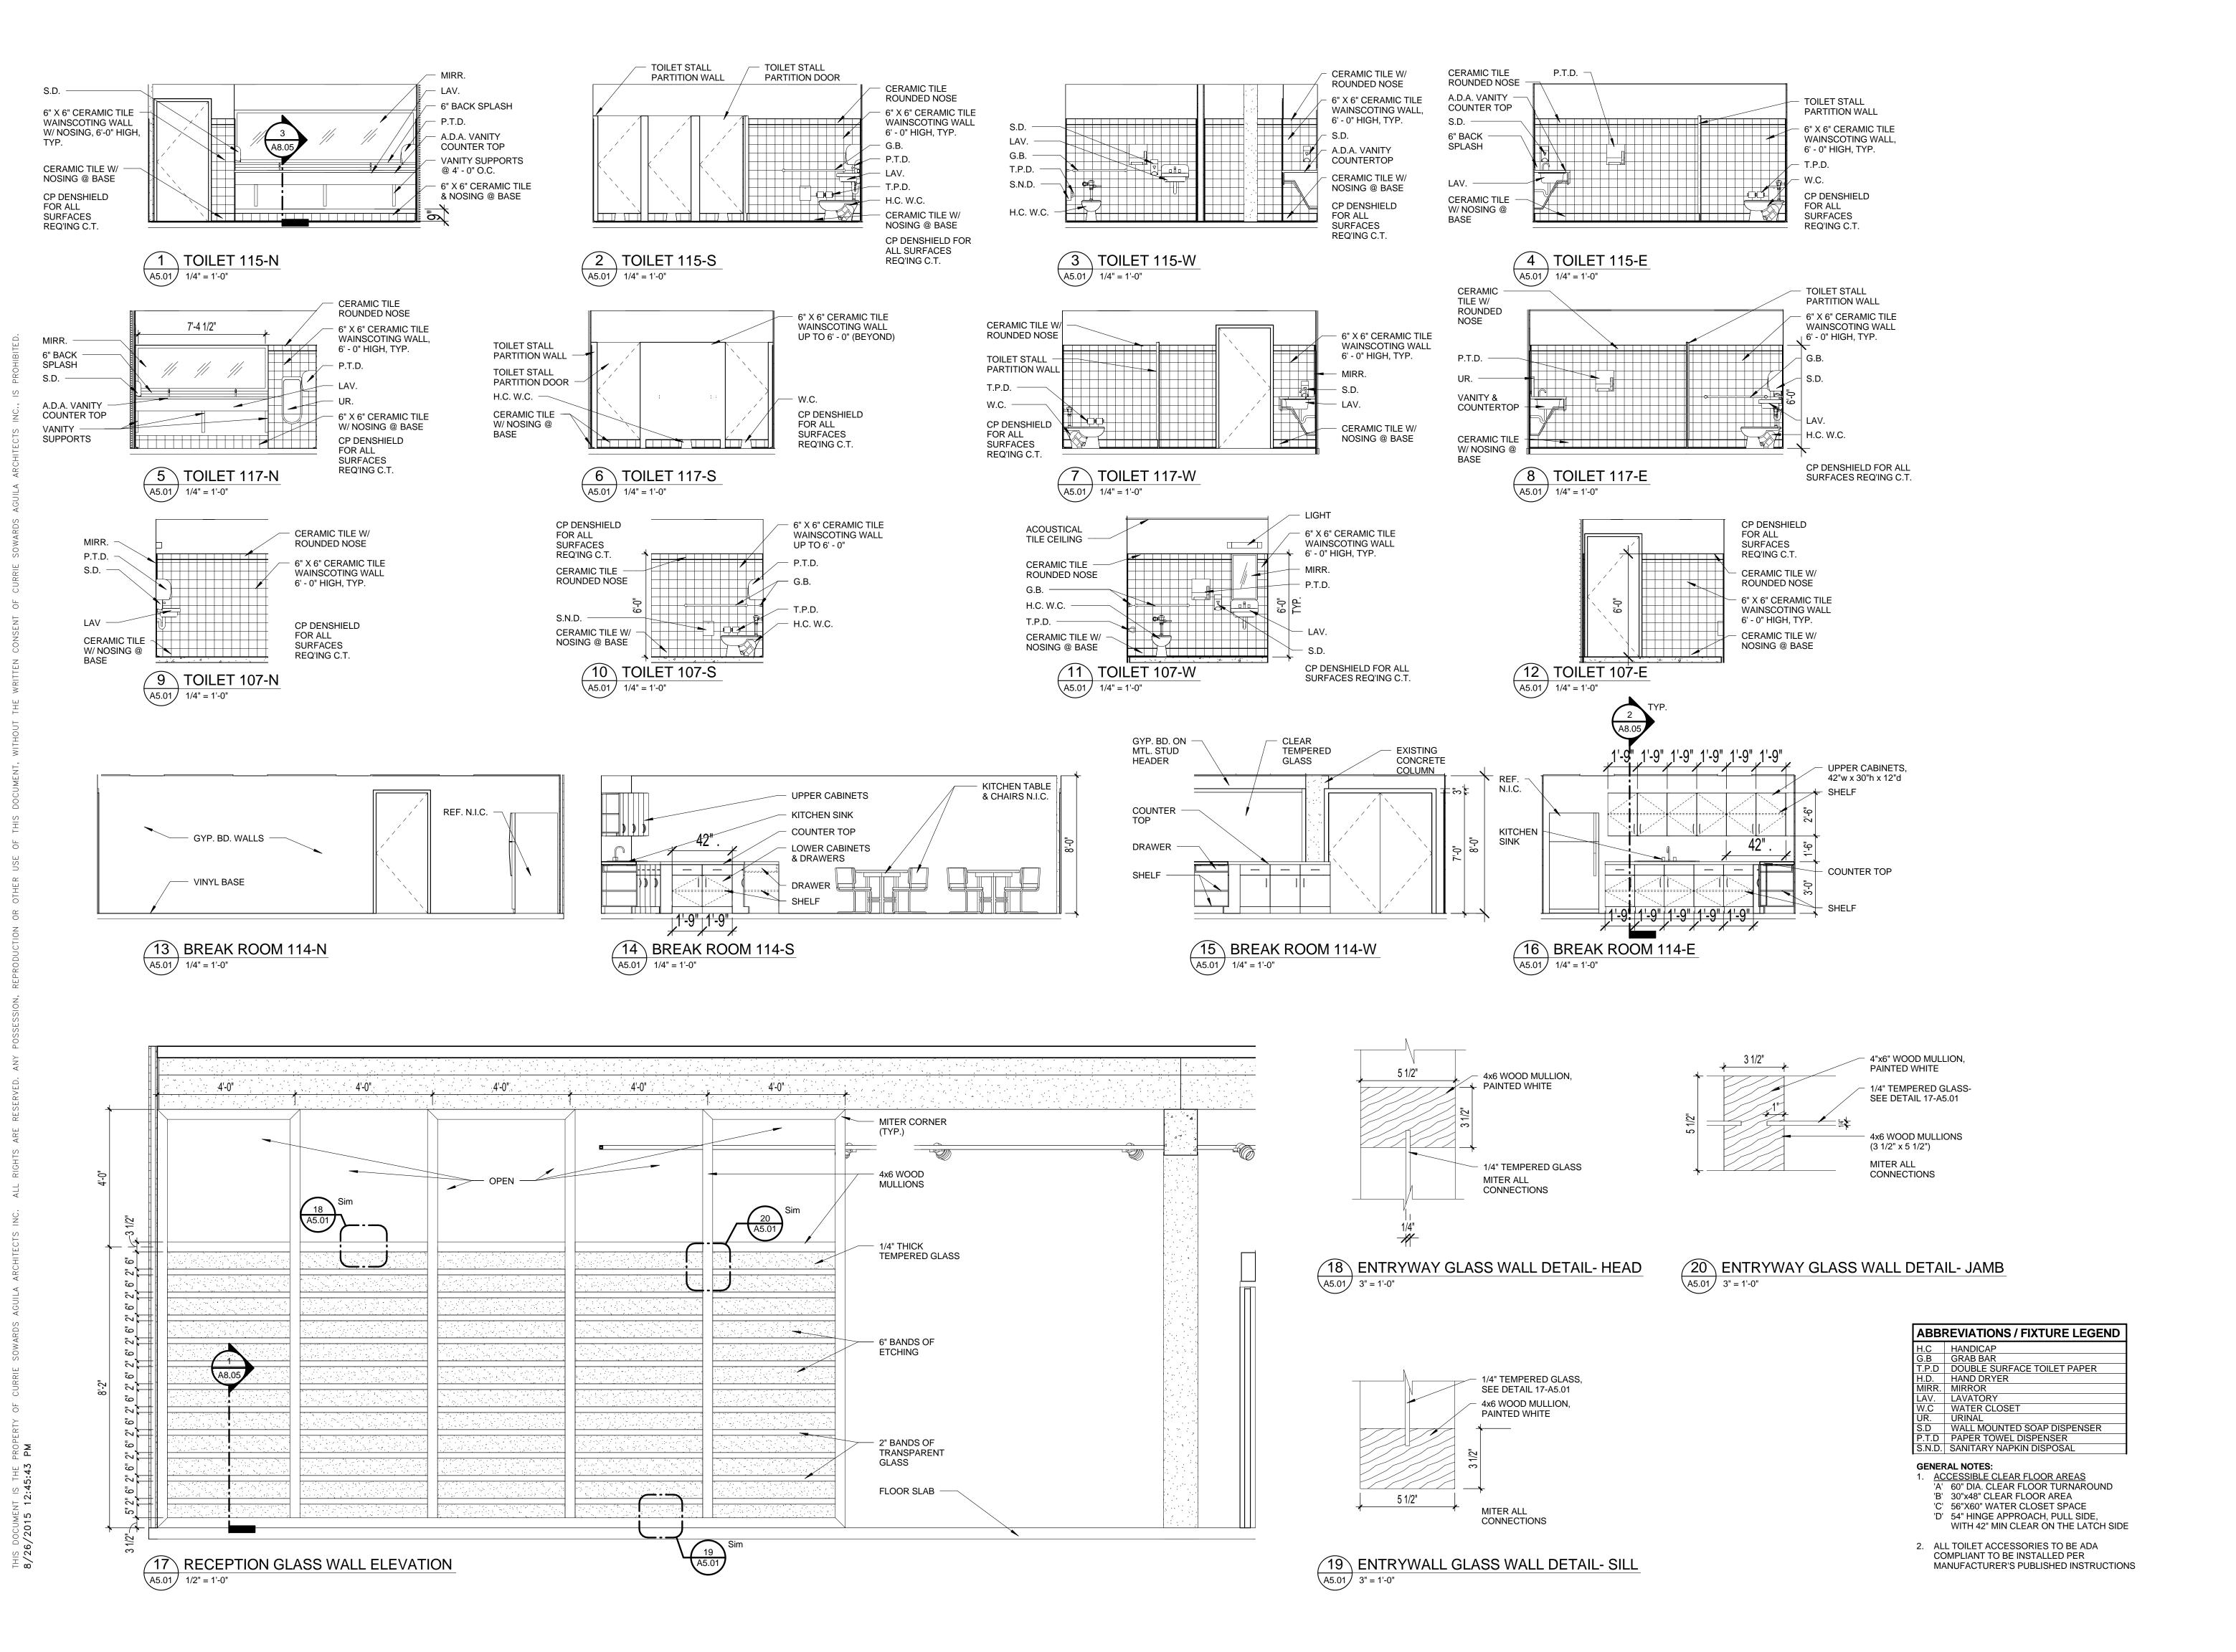
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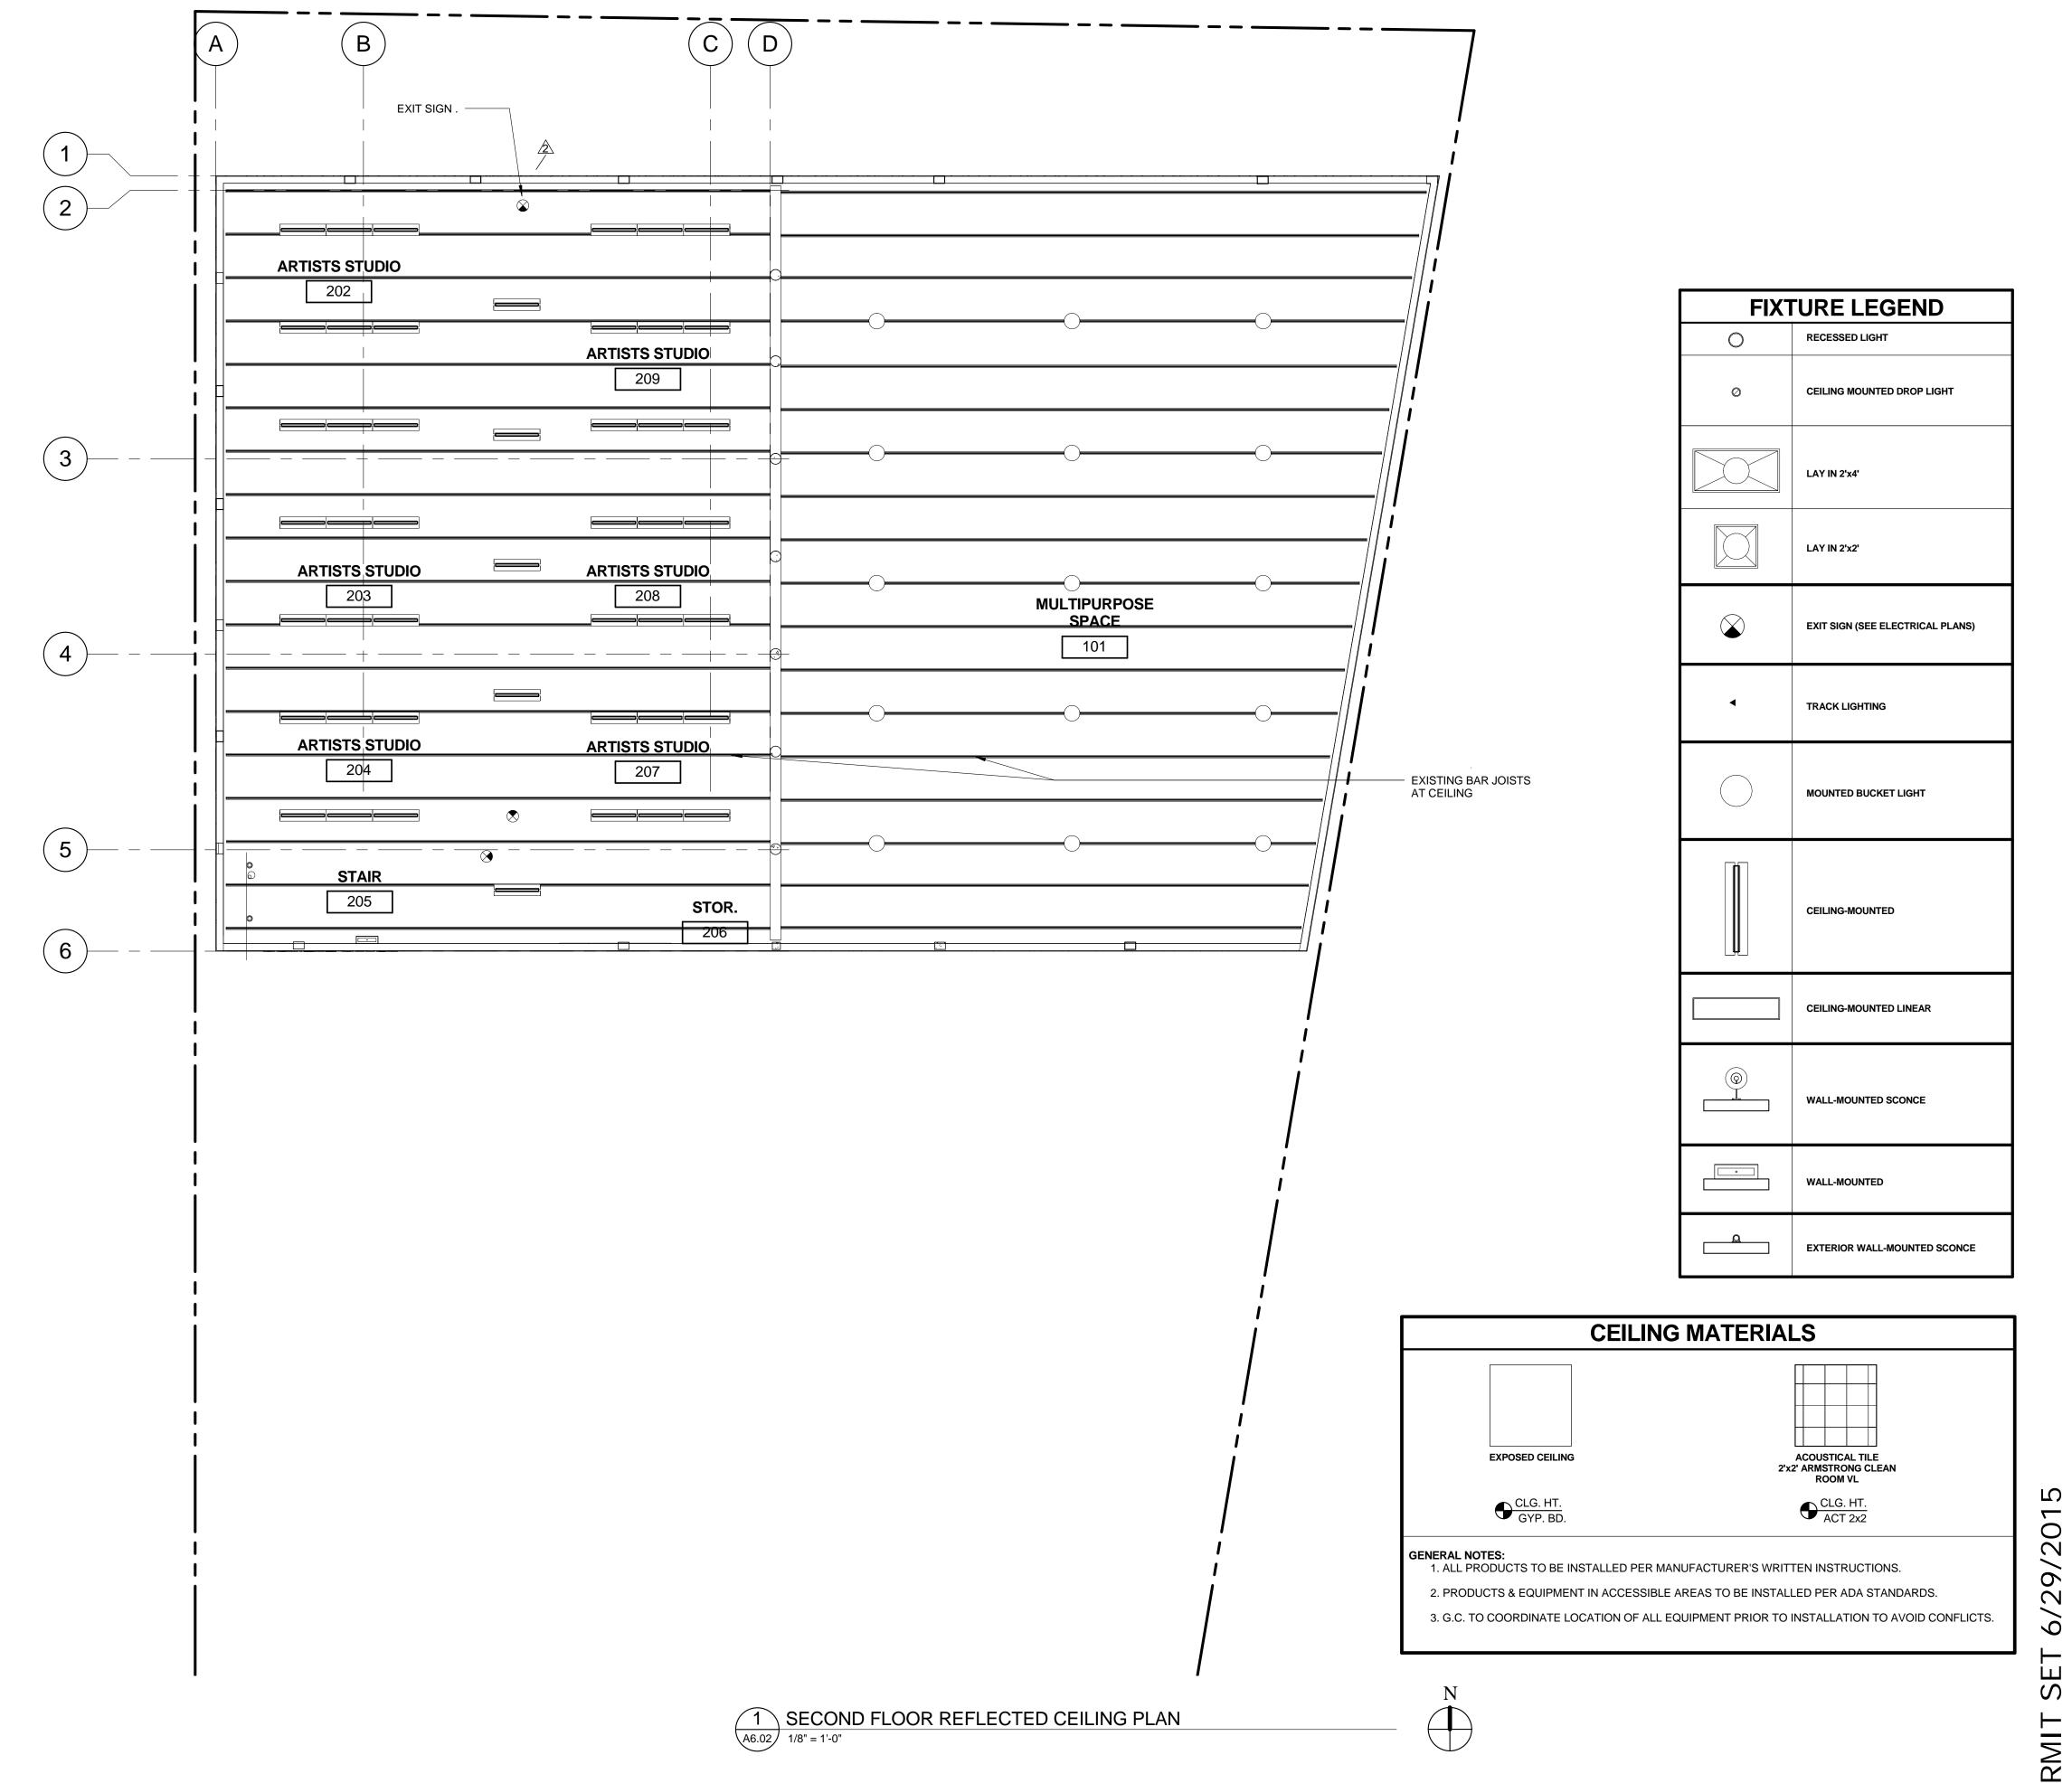
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DRAWING TITLE

NTERIOR ELEVATION

DATE 6/29/2015 MM

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## CURRIE SOWARDS

**AGUILA** architects

Architecture, Planning, Interiors, &

Sustainable Design AA26001584

185 NE 4TH AVENUE SUITE 101 DELRAY BEACH, FL 33483 T: (561) 276-4951 F: (561) 243-8184 E-MAIL: office@csa-architects.com

ISSUED FOR :

SPRAB 3/05/2015

BIDS .

PERMIT 6/29/2015

CONSTRUCTION

Art Warehouse Renovation

313 NE 3rd Street, Delray Beach, Florida 33444

 REVISIONS

 NUM.
 DESCRIPTION
 DATE

 1
 Bldg. Dept. comments
 8/21/2015

 2
 Bldg. Dept. comments
 10/23/2015

THESE DRAWINGS ARE PREPARED PER ESTABLISHED INDUSTRY STANDARDS AND REPRESENT THE ARCHITECT AND ENGINEERS DESIGN CONCEPT. THEY ARE NOT INTENDED TO PROVIDE EVERY DETAIL OR CONDITION REQUIRED TO CONSTRUCT THE BUILDING. THE CONTRACTOR THROUGH SUBMITTALS AND OTHER COORDINATION EFFORTS IS FULLY RESPONSIBLE FOR PROVIDING A COMPLETE AND OPERATIONAL BUILDING WHETHER INDICATED ON THE PLANS OR NOT.

FILE NUMBER


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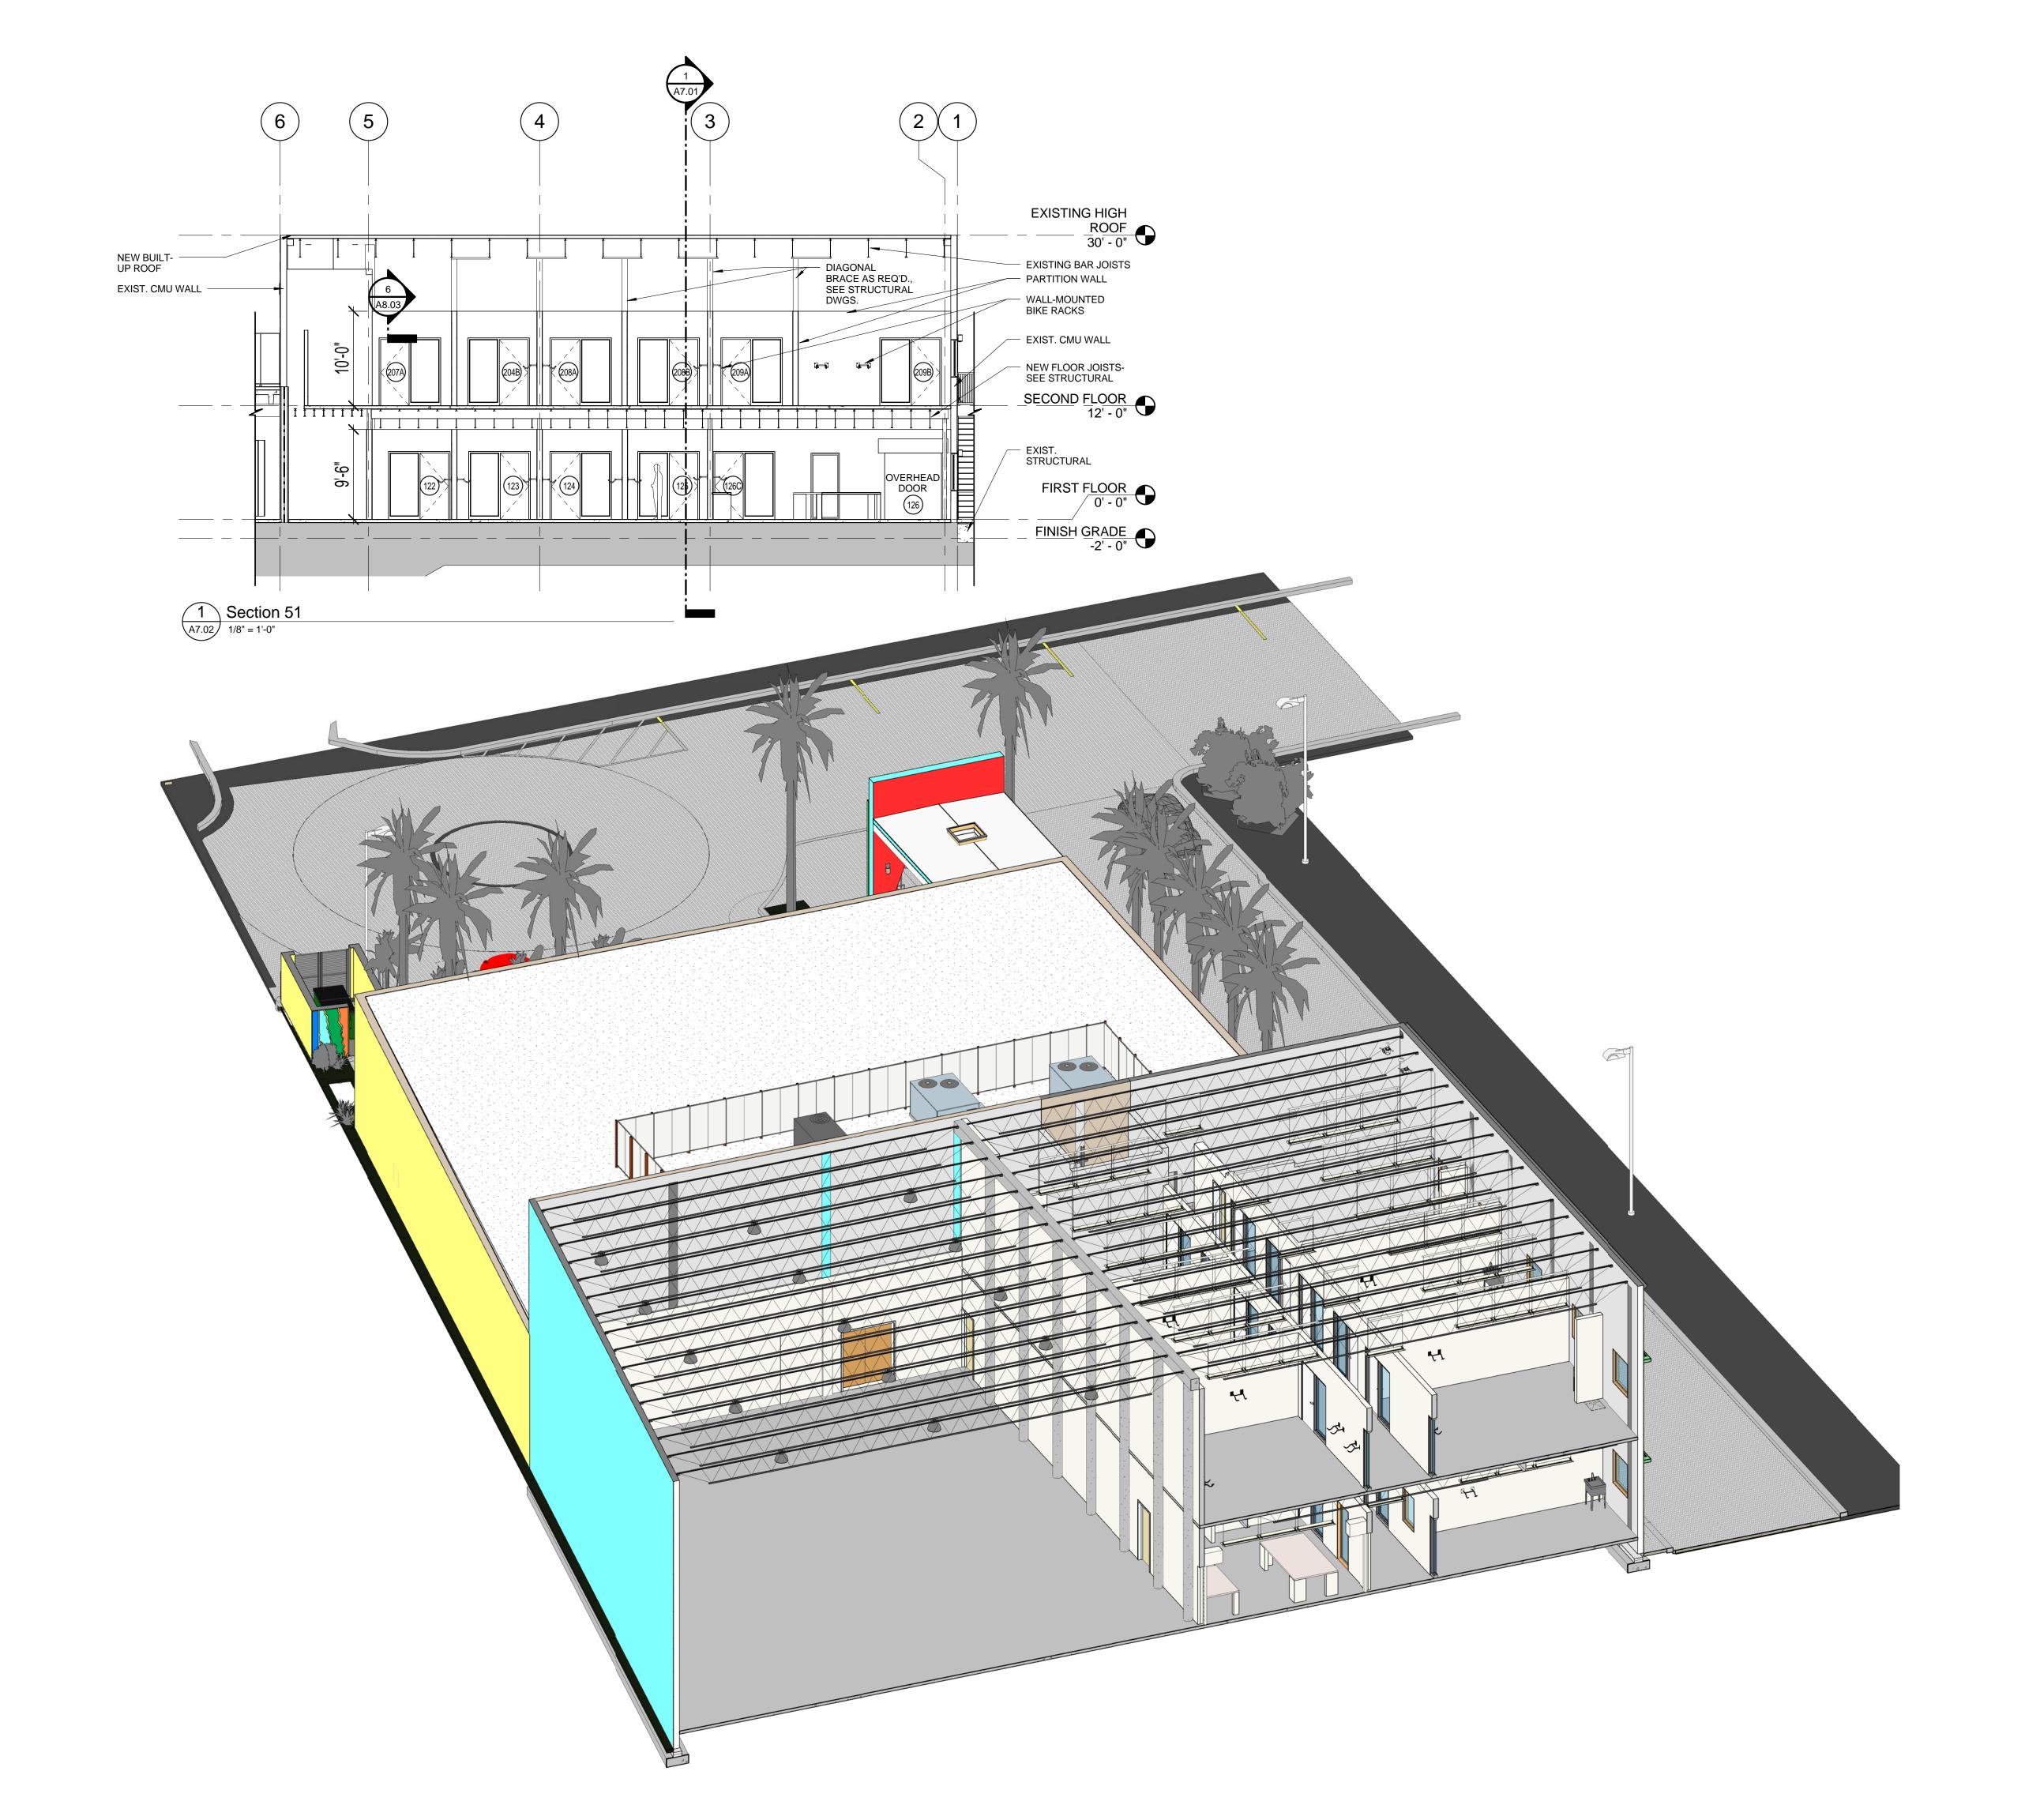
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REFLECTED
CEILING PLAN

DATE | DRAWN BY | 6/29/2015 | JC | JOB NUMBER | 100701

A6 02





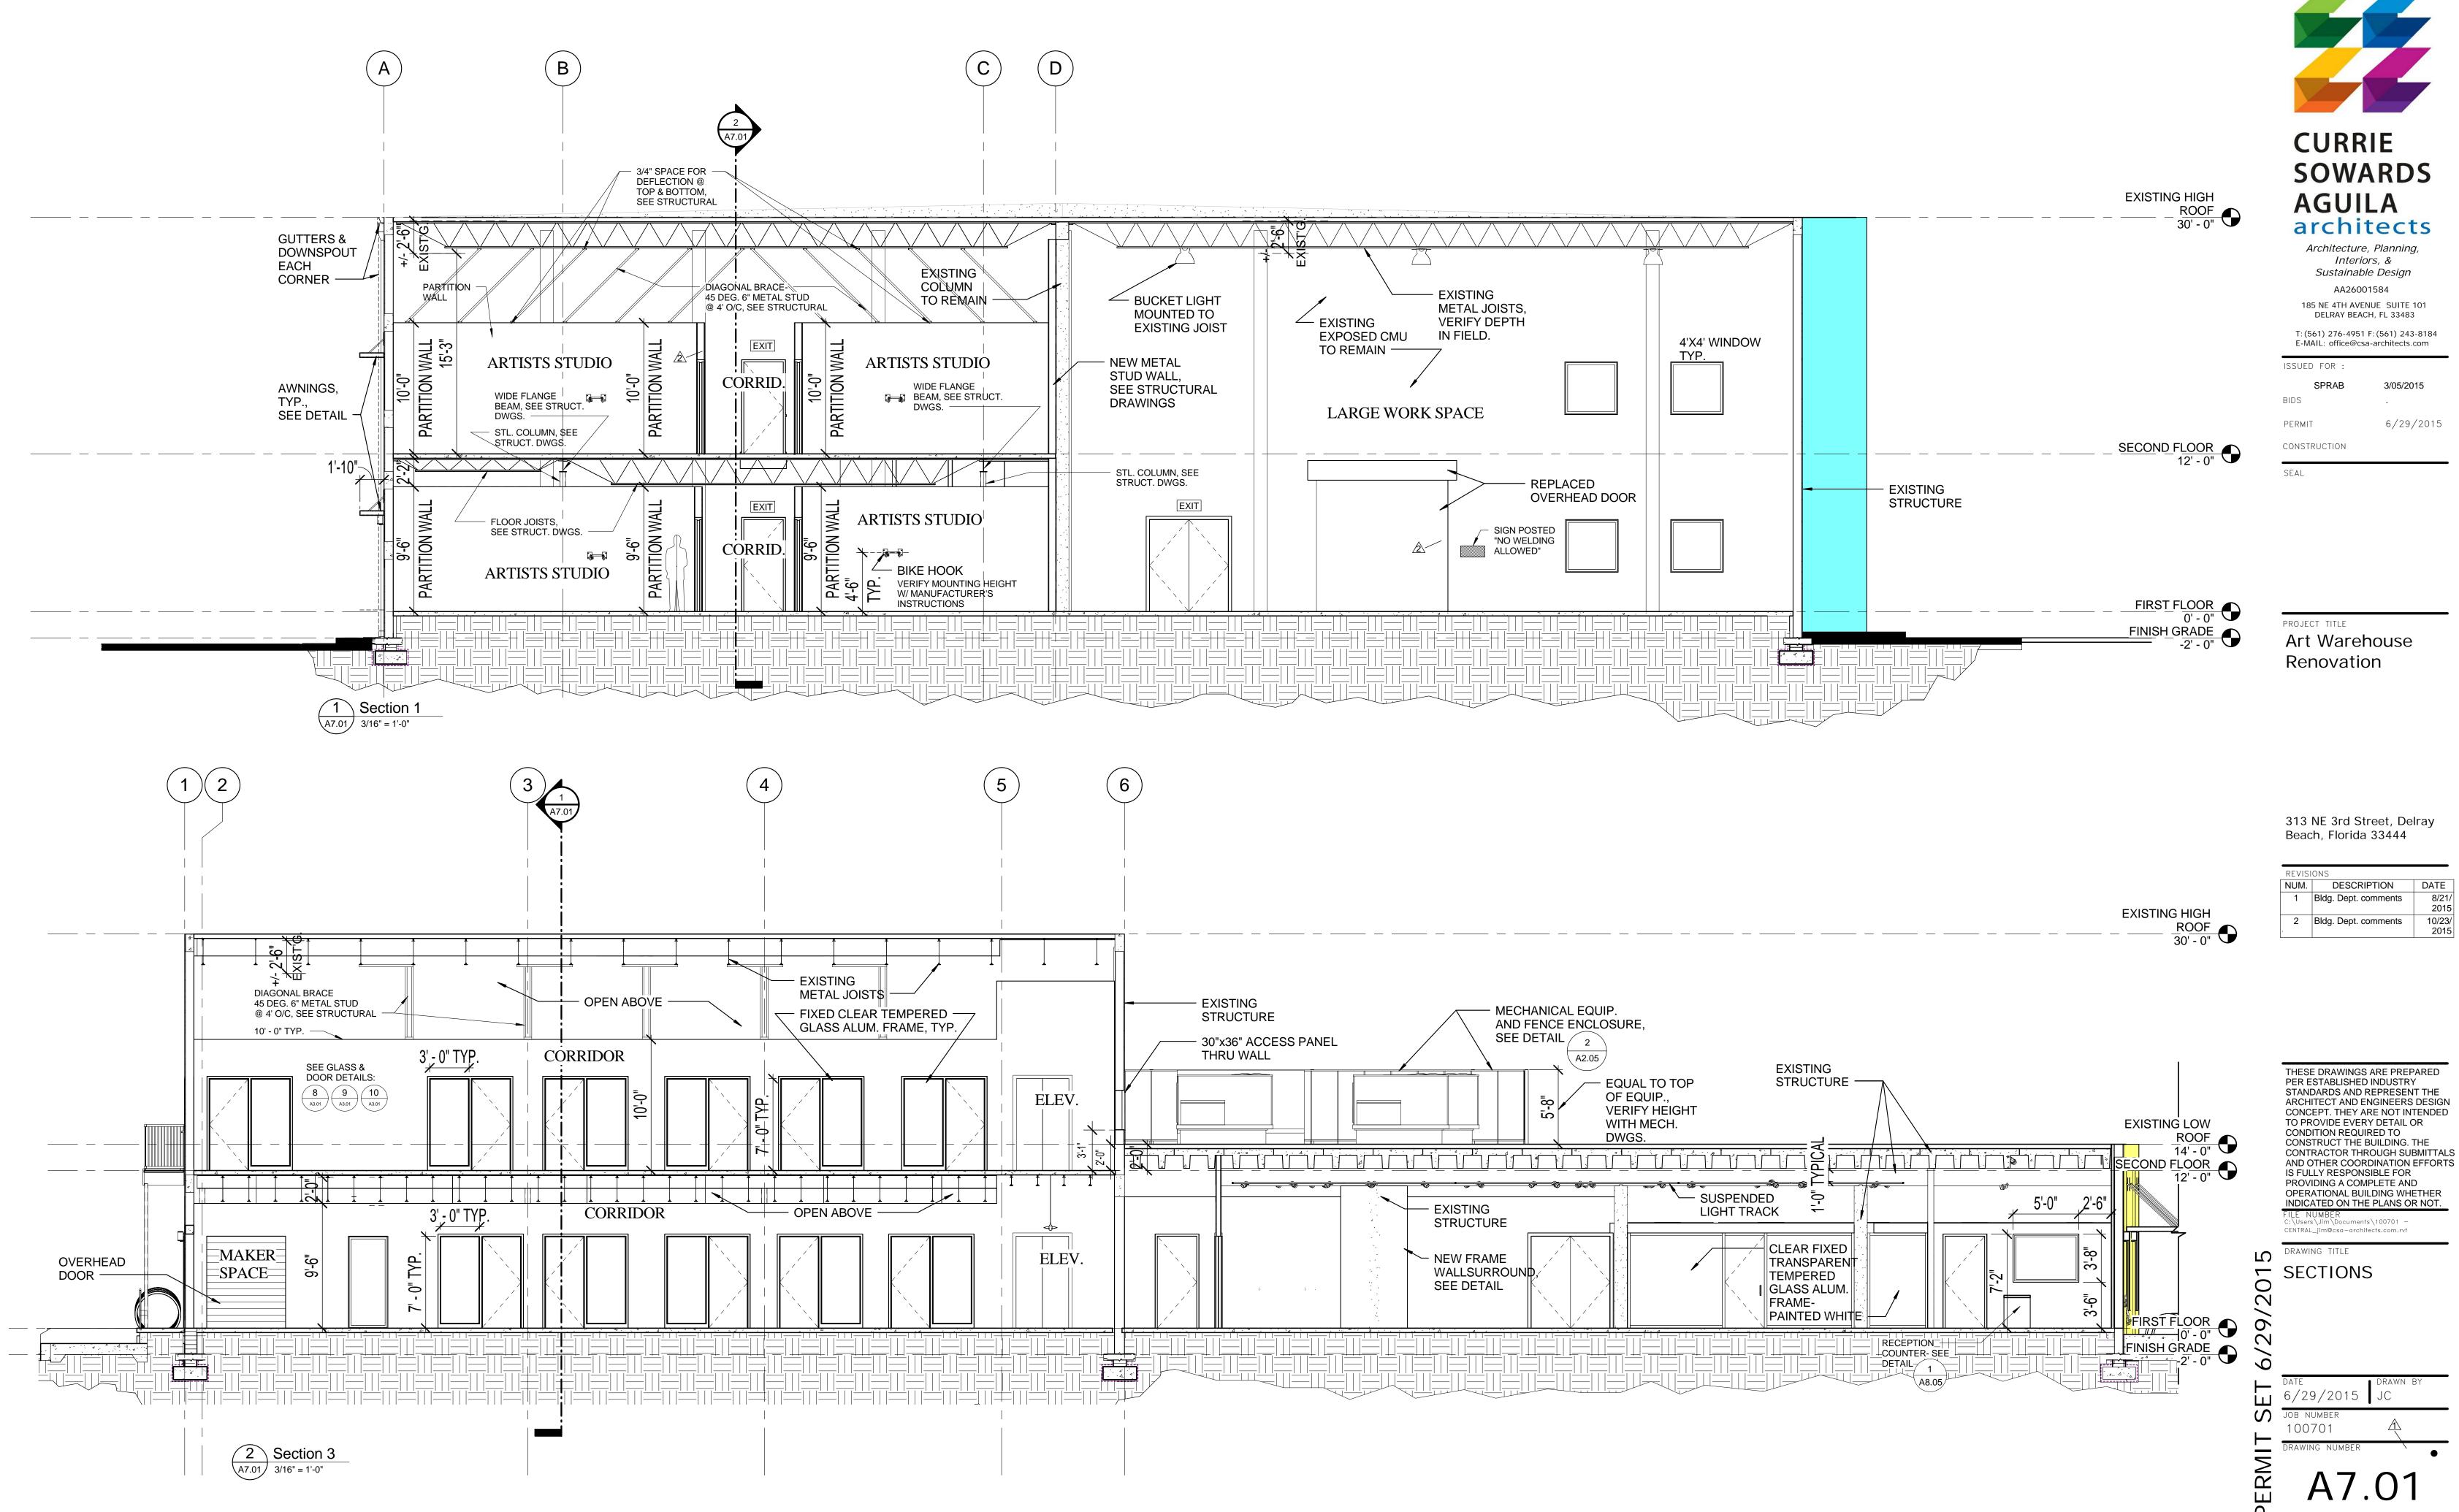

## SOWARDS AGUILA architects

Architecture, Planning, Interiors, & Sustainable Design AA26001584

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REVISIONSNUM.DESCRIPTIONDATE1Bldg. Dept. comments8/21/2015

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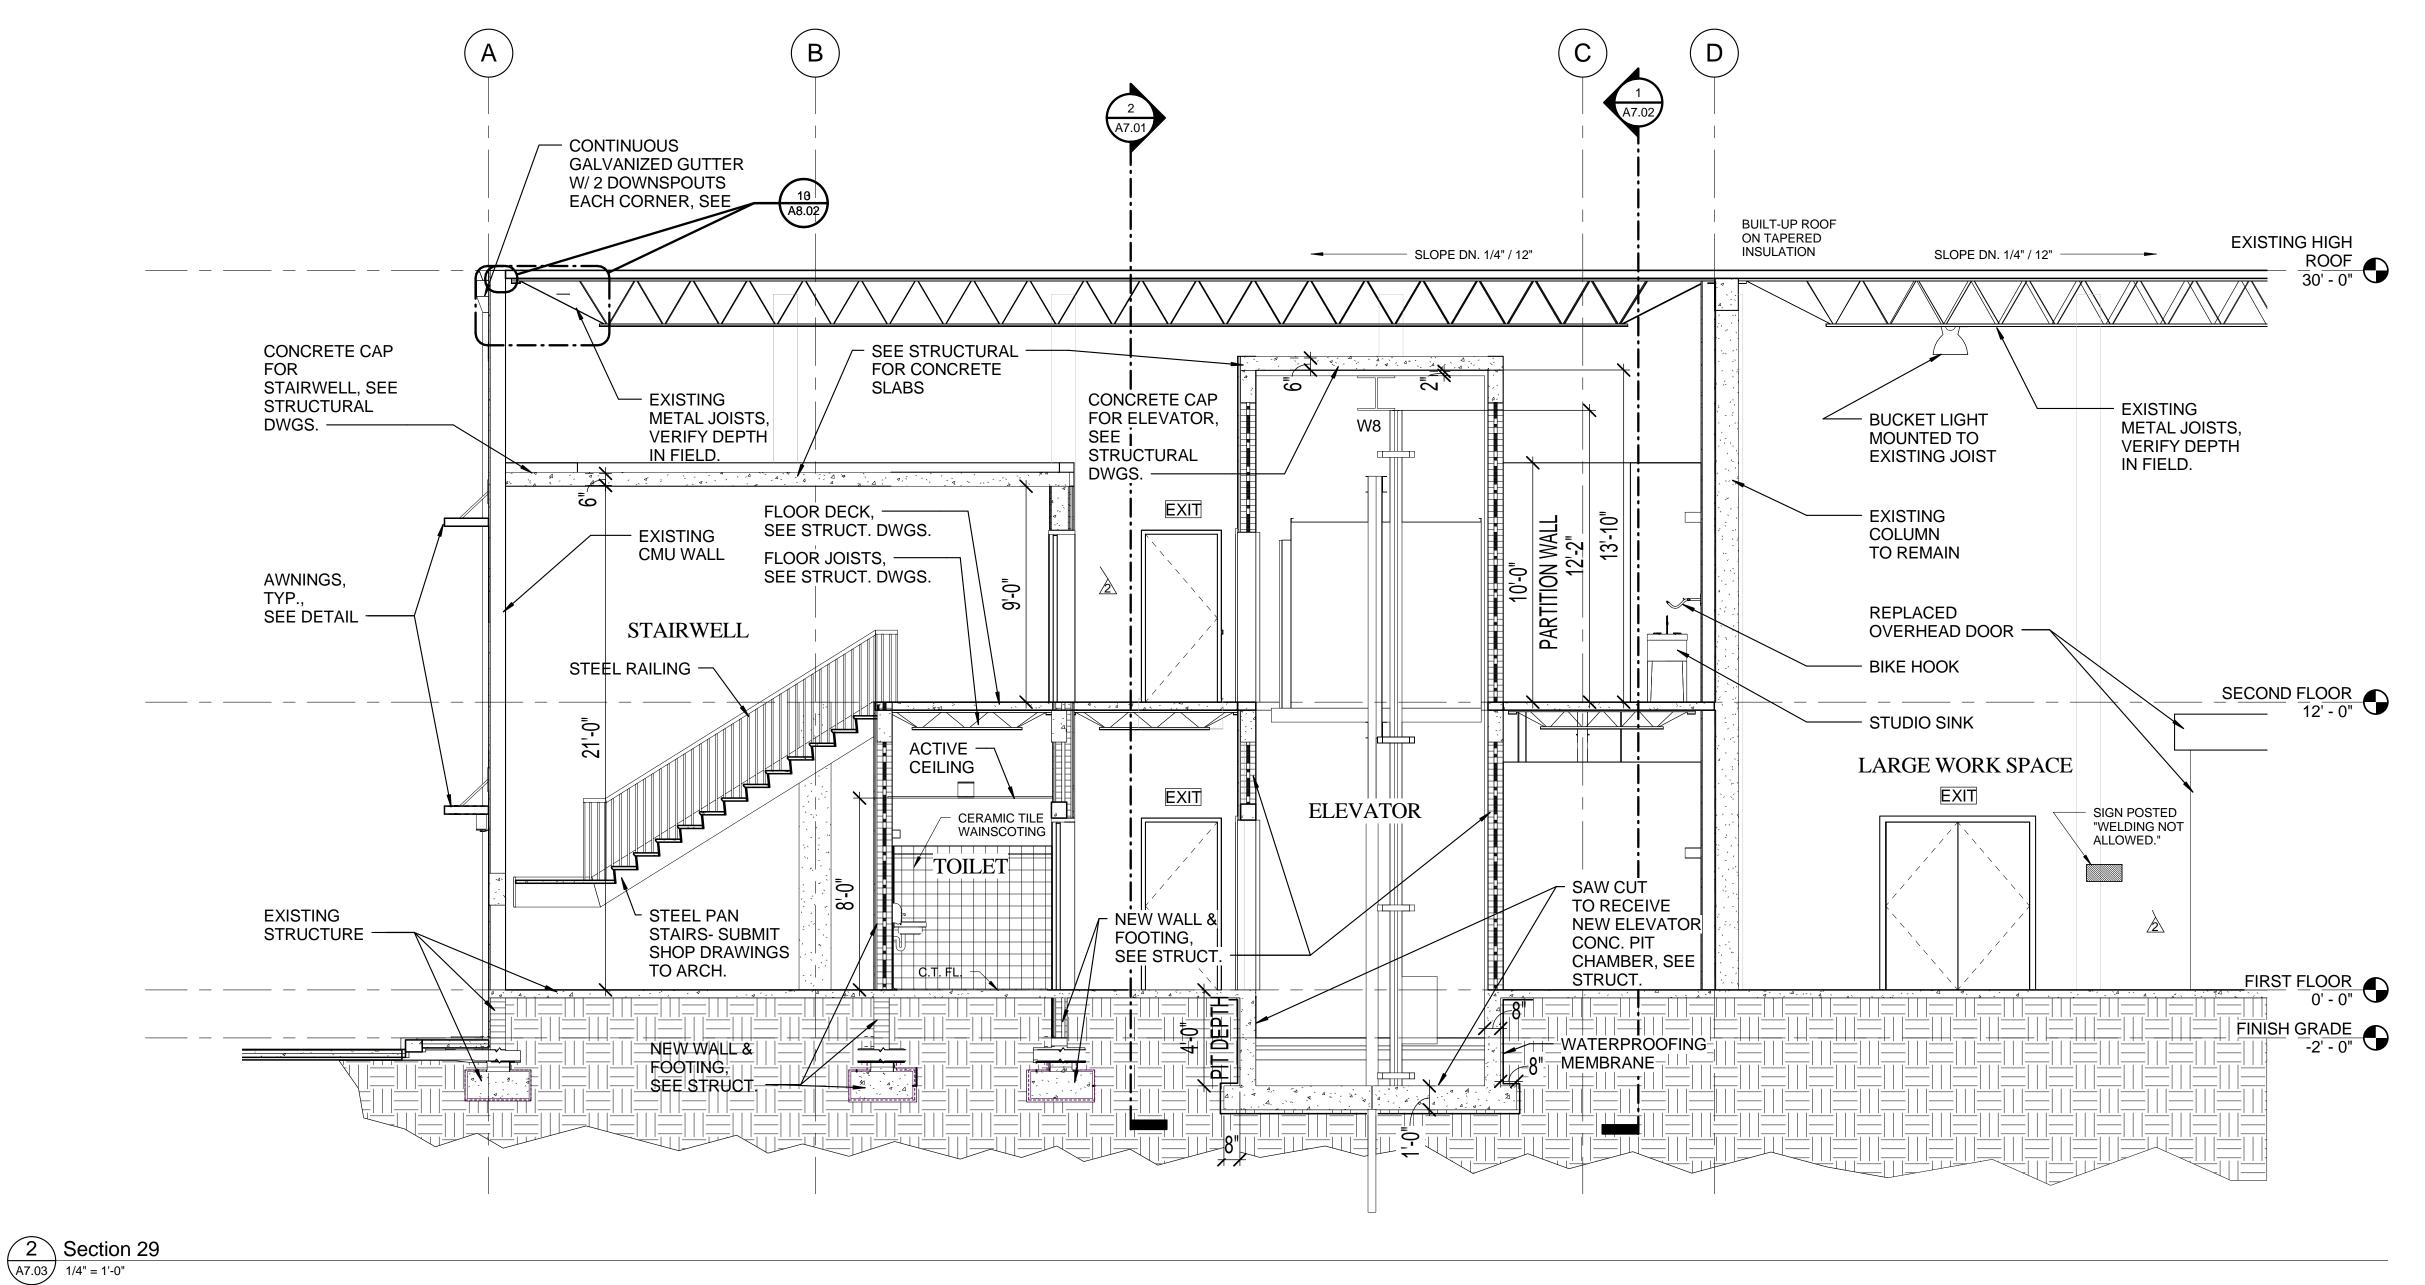
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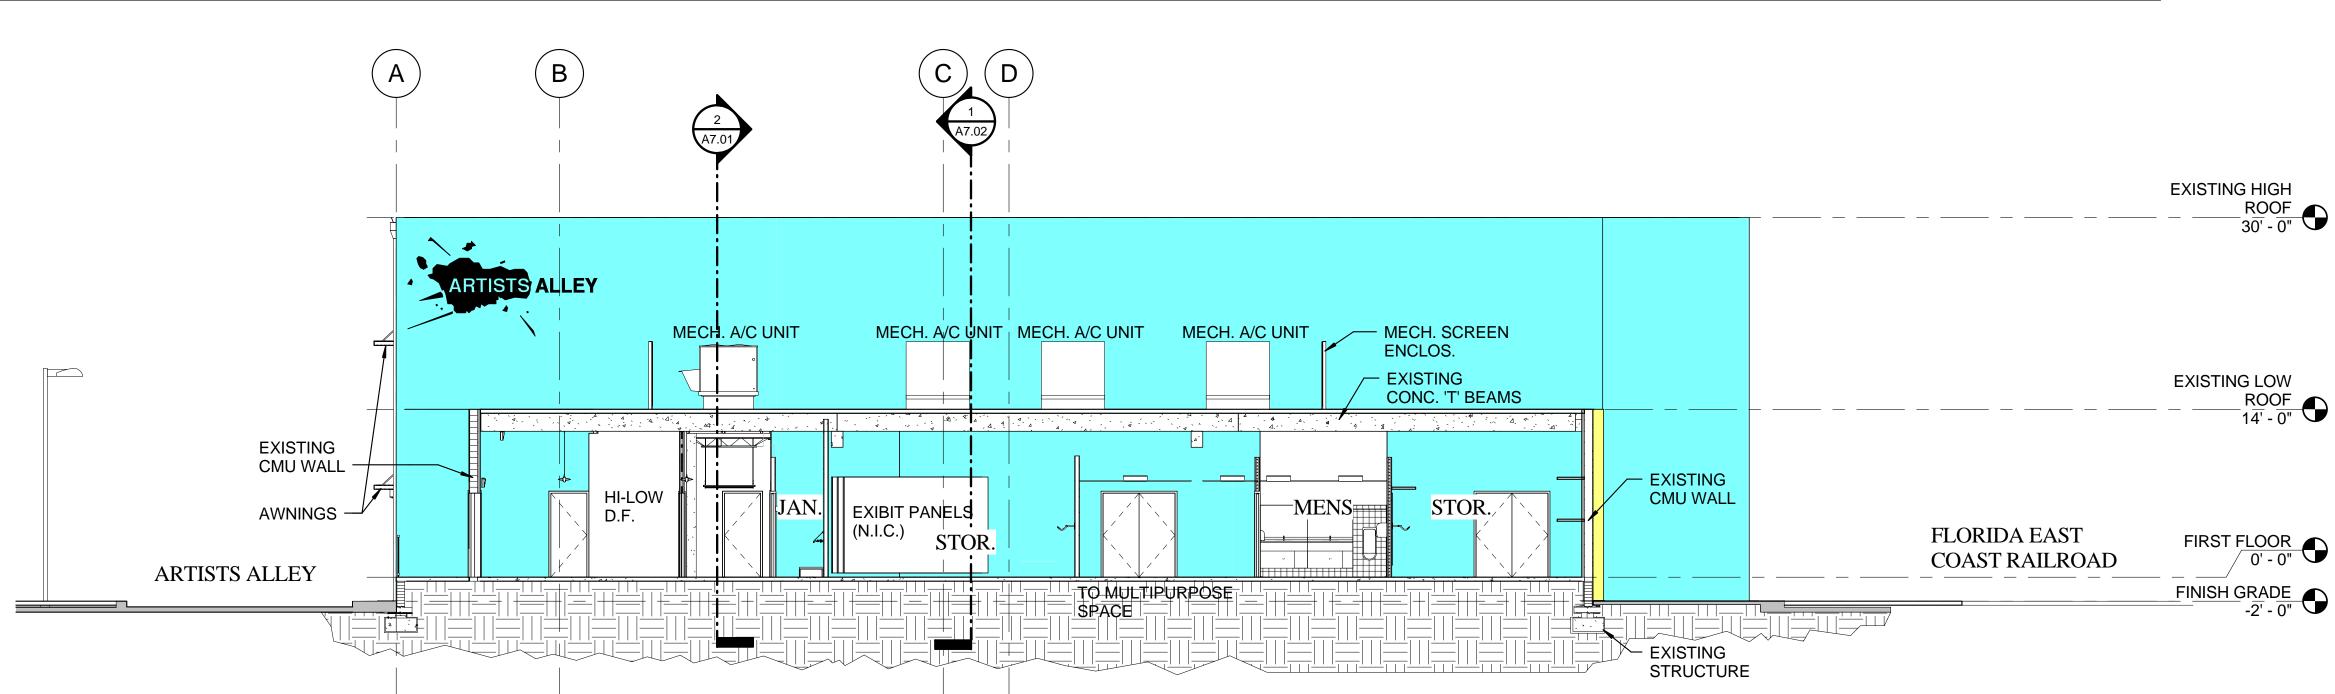
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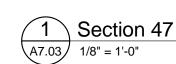
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DATE | DRAWN | 6/29/2015 | JC | JOB NUMBER | 100701 | 1

A7.02









Sustainable Design
AA26001584

185 NE 4TH AVENUE SUITE 101
DELRAY BEACH, FL 33483

6/29/2015

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INDICATED ON THE PLANS OR NOT.

FILE NUMBER
C:\Users\Jim\Documents\100701 CENTRAL\_jim@csa-architects.com.rvt

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SECTIONS


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6/29/2015 JC

JOB NUMBER
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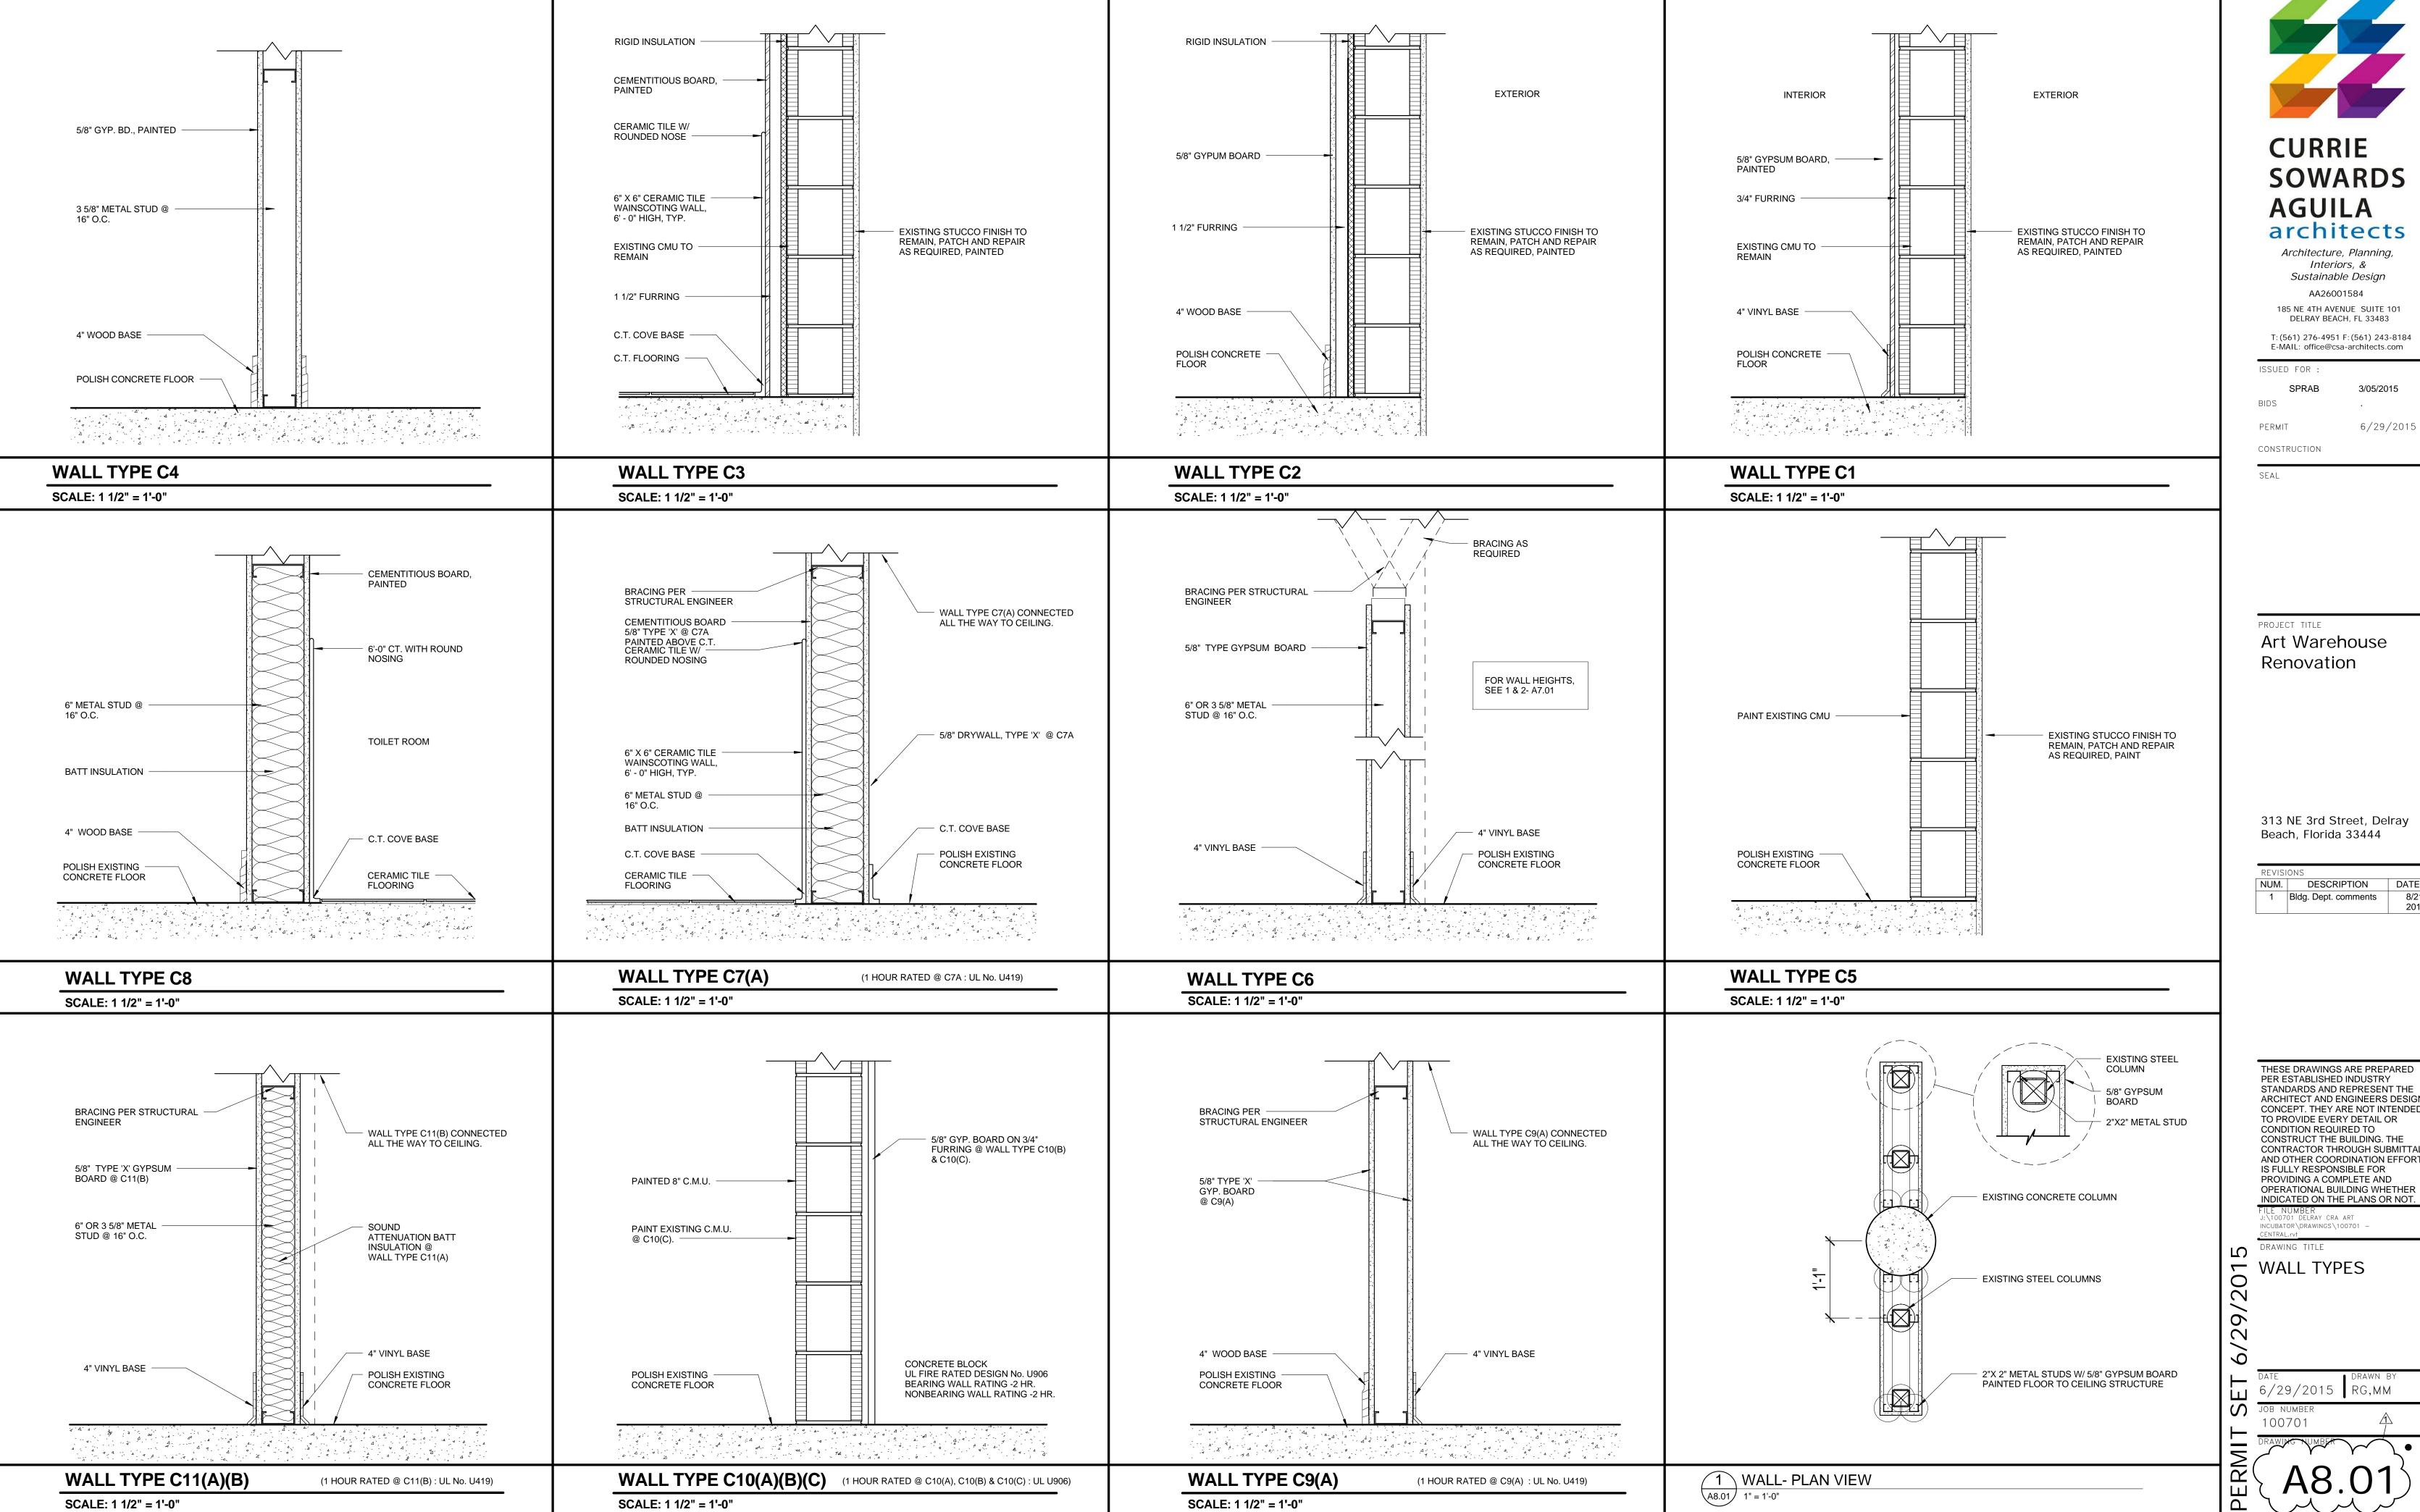


3 TYPICAL RISER

A7.04 3" = 1'-0"

4 TYPICAL BEAM DETAIL

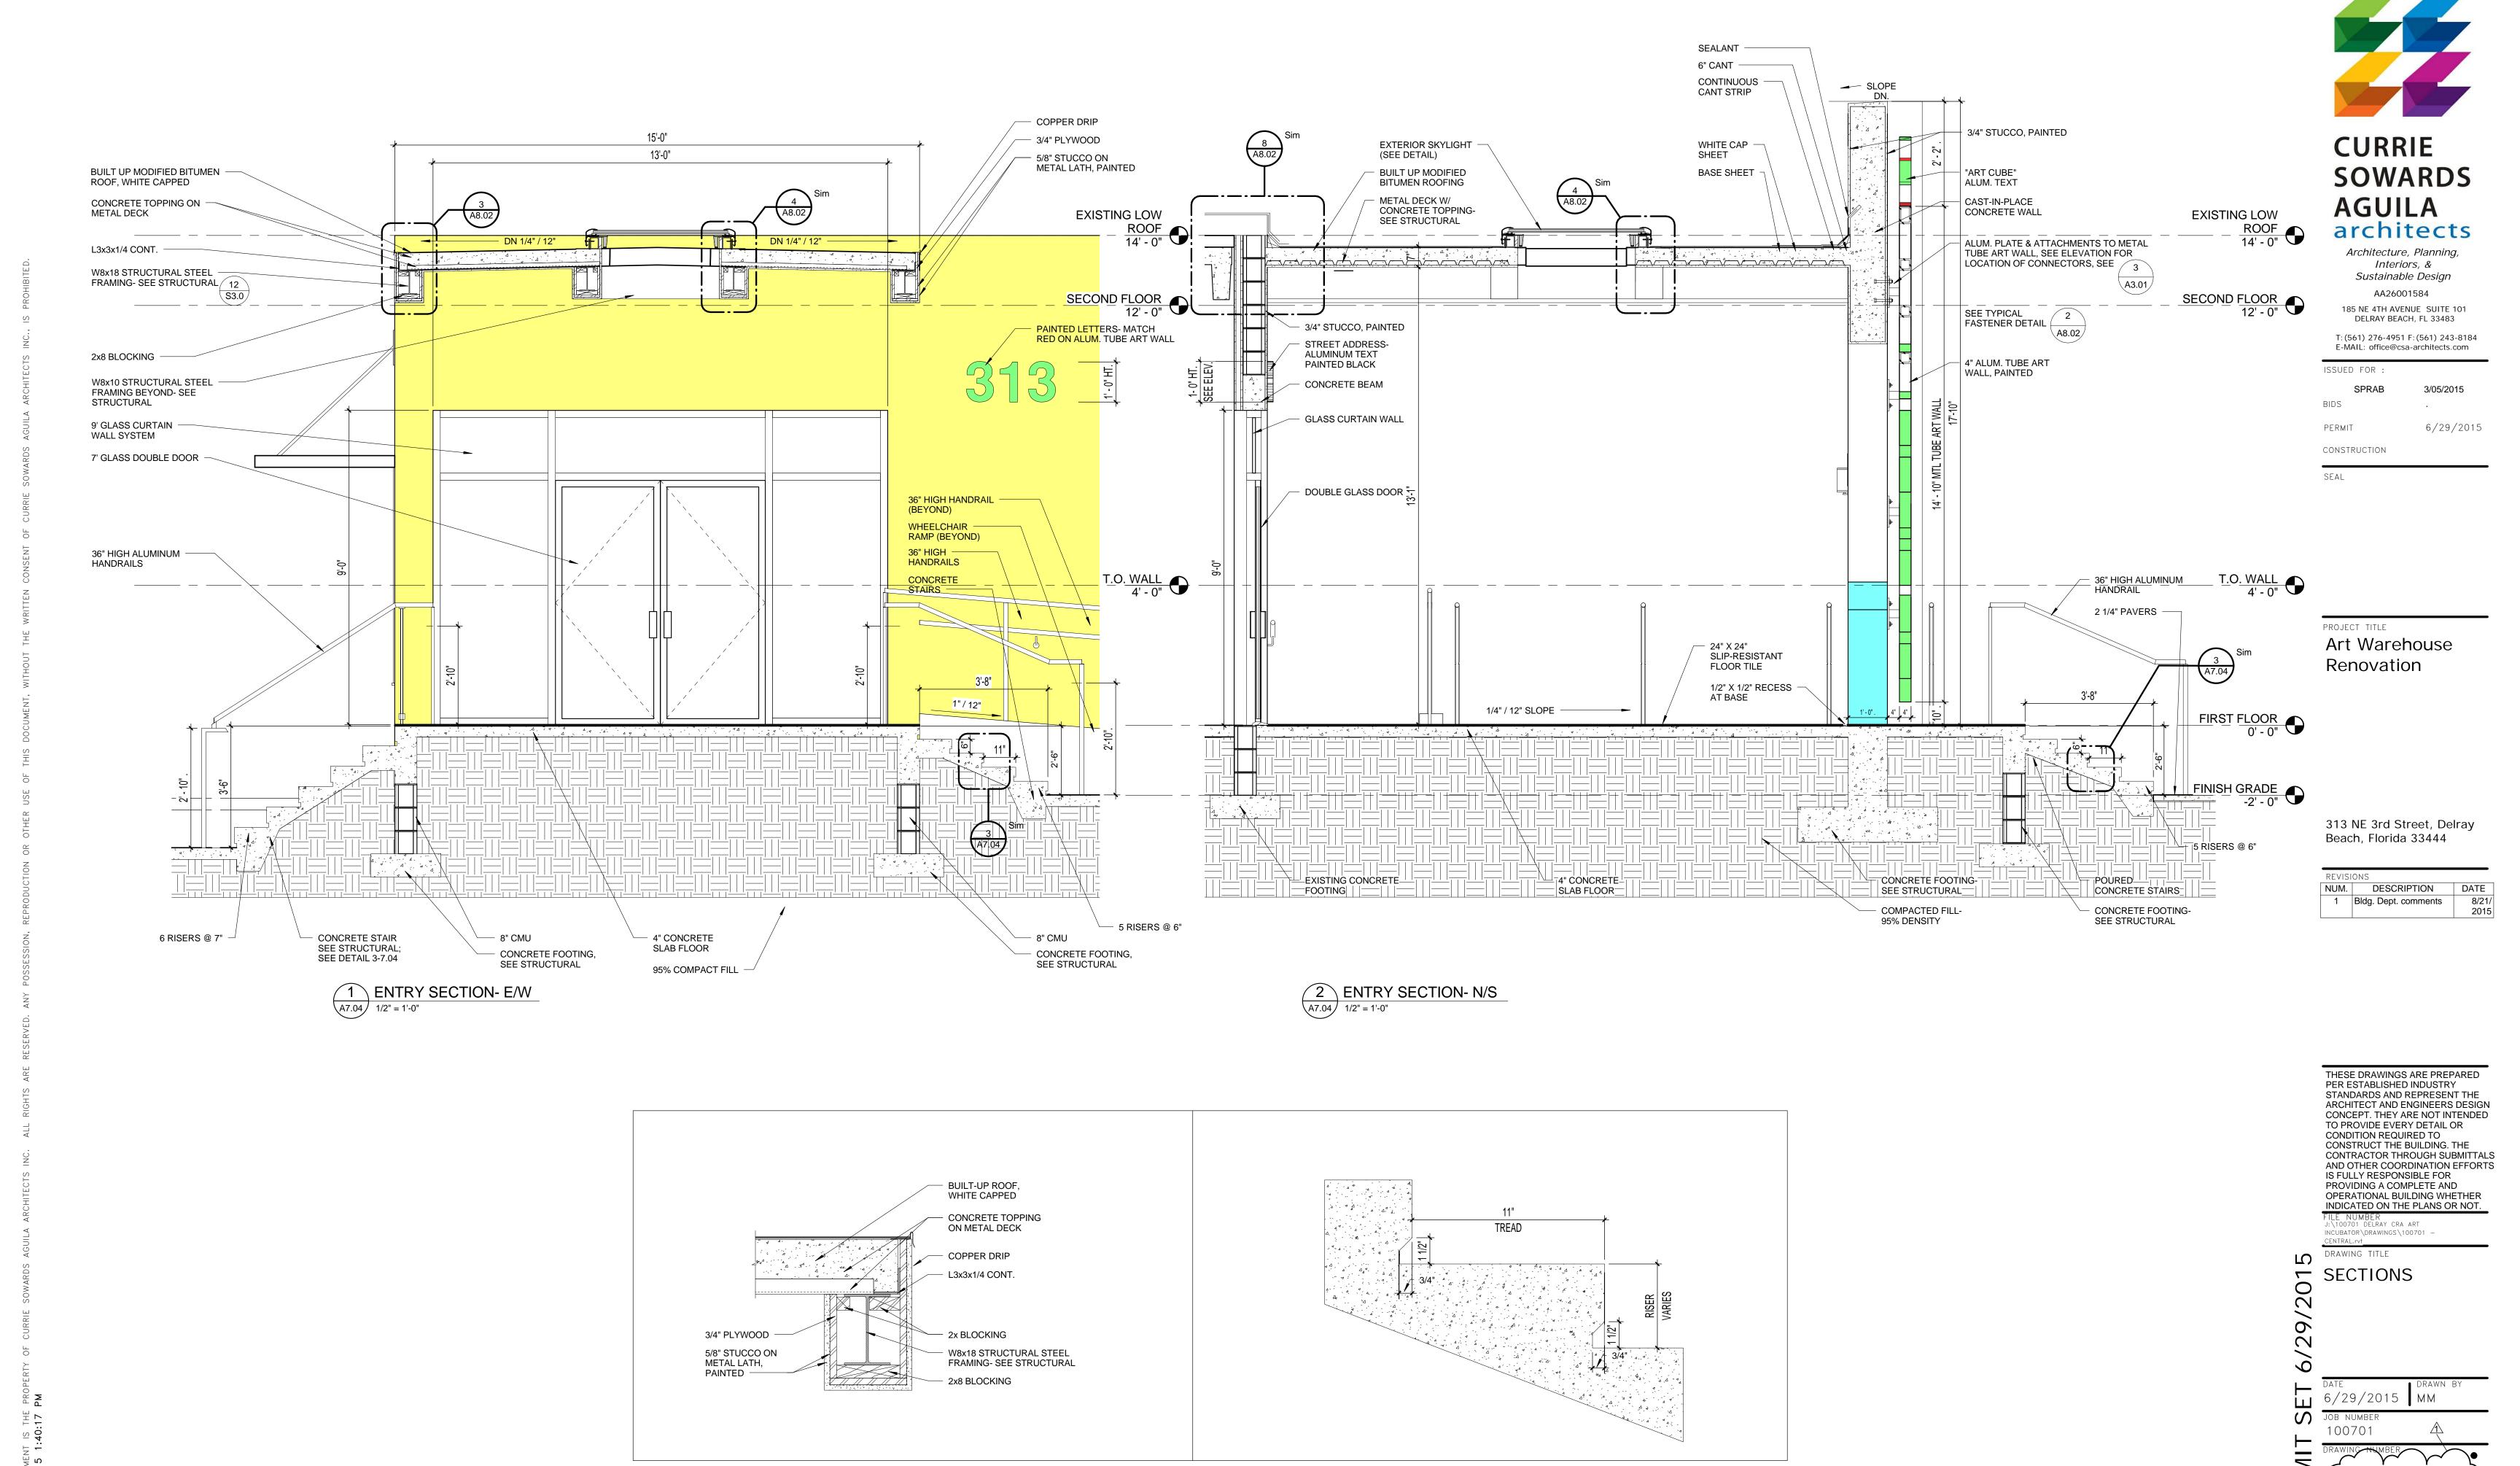A7.04 1 1/2" = 1'-0"



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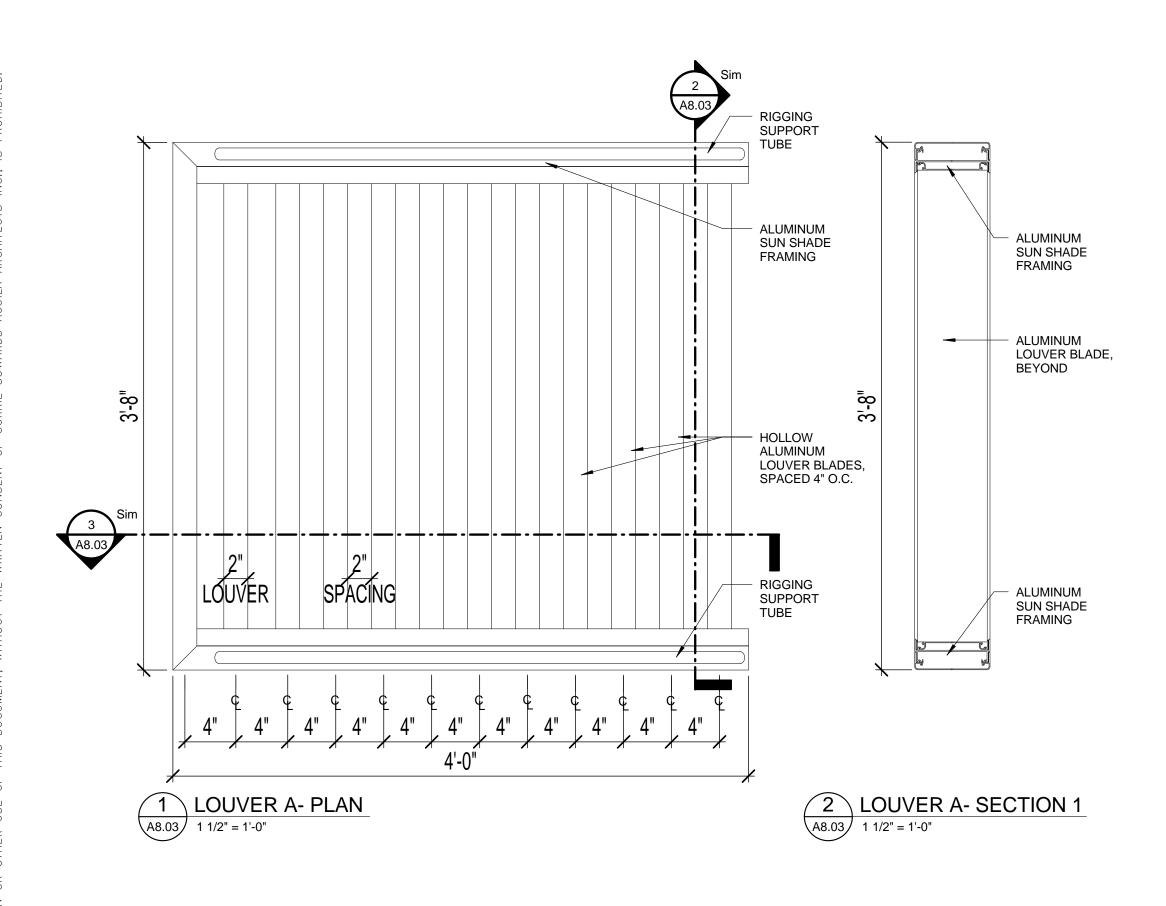
313 NE 3rd Street, Delray


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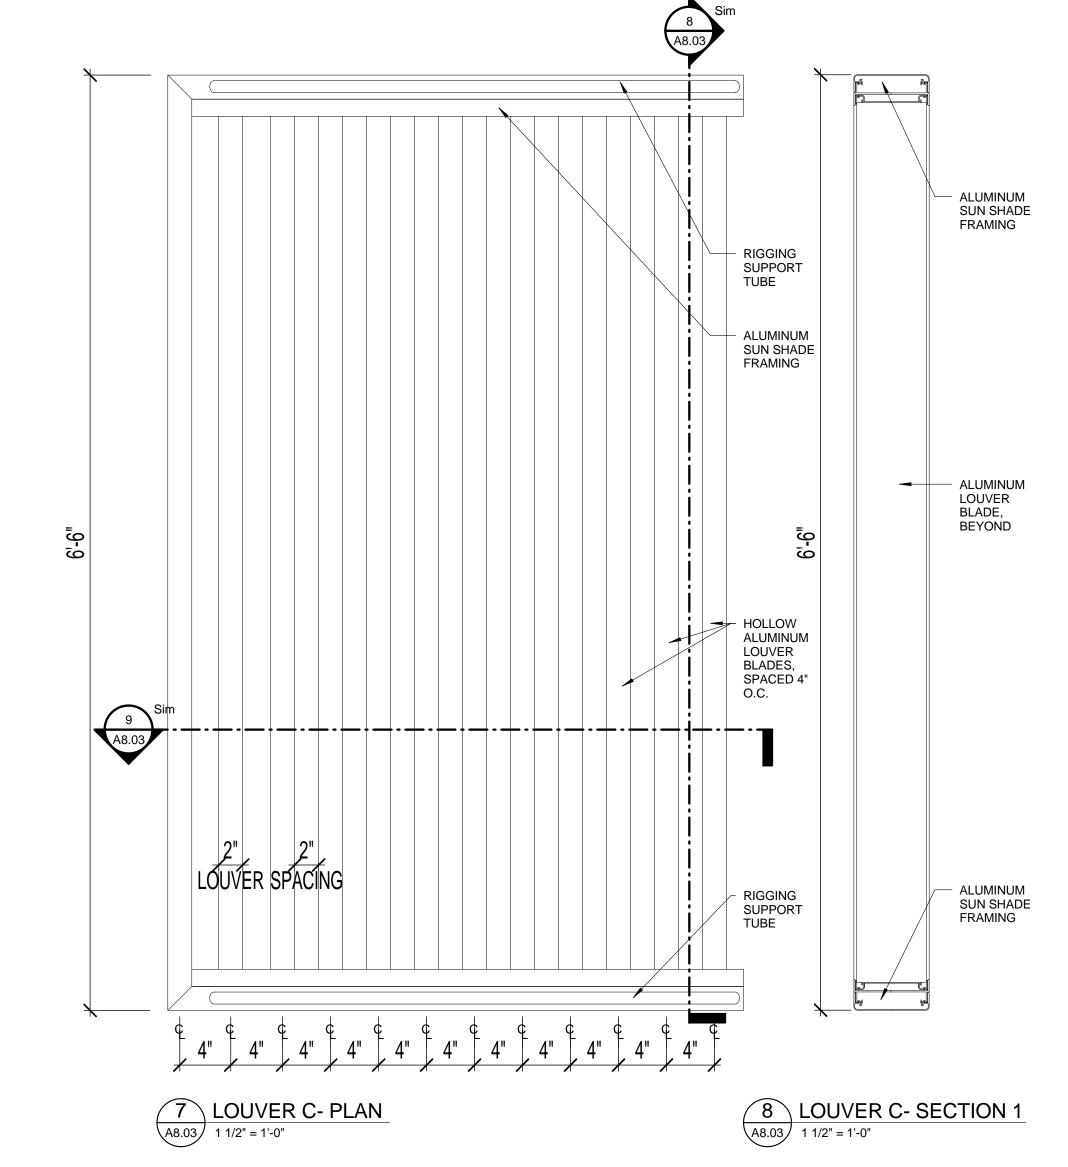
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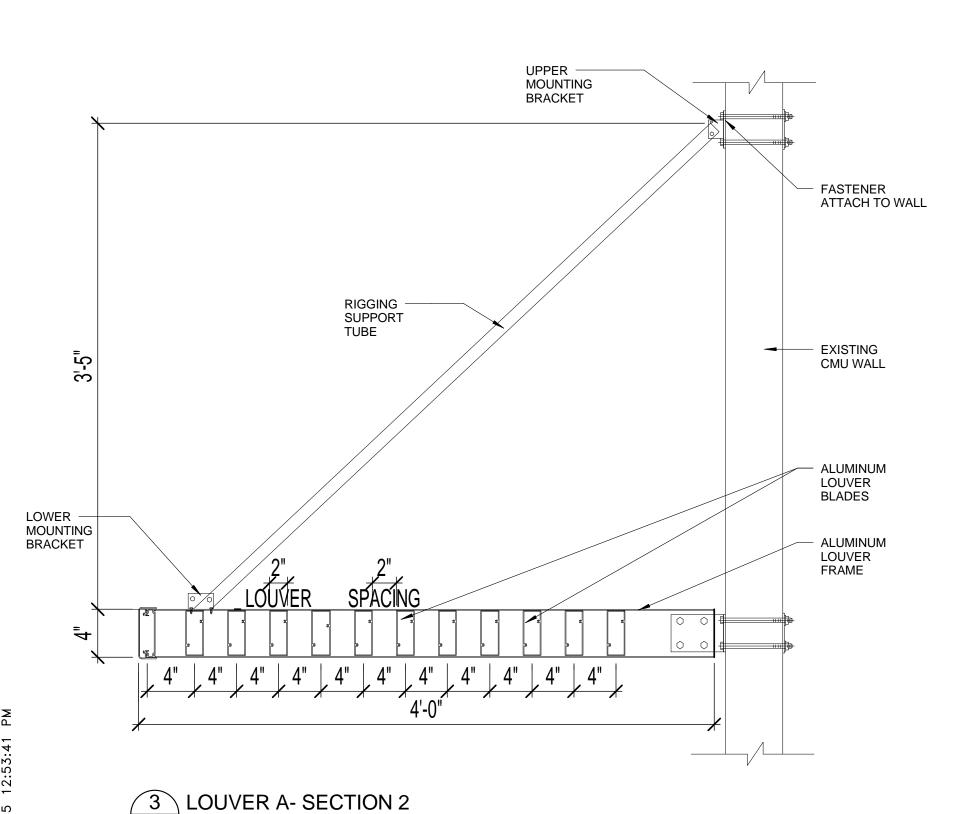
NUM. DESCRIPTION DATE 1 Bldg. Dept. comments 8/21/ 2015

STANDARDS AND REPRESENT THE ARCHITECT AND ENGINEERS DESIGN CONCEPT. THEY ARE NOT INTENDED CONSTRUCT THE BUILDING. THE CONTRACTOR THROUGH SUBMITTALS AND OTHER COORDINATION EFFORTS IS FULLY RESPONSIBLE FOR









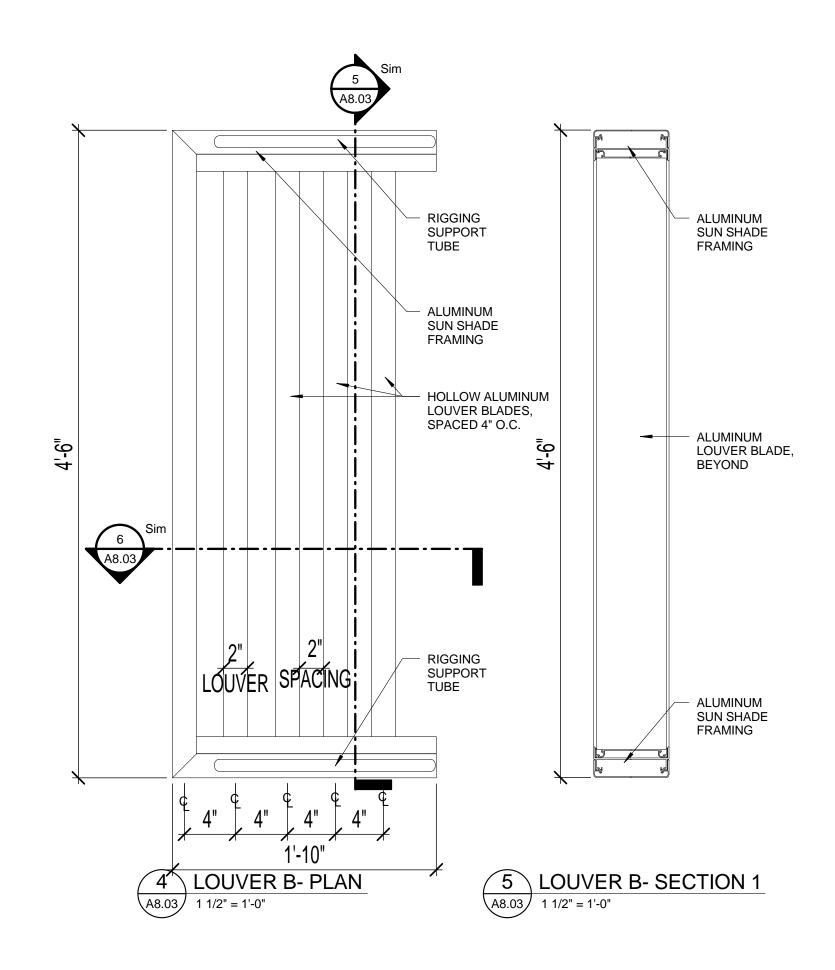


A8.03 1 1/2" = 1'-0"

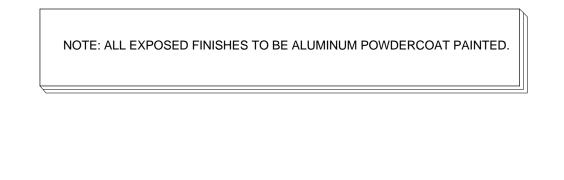

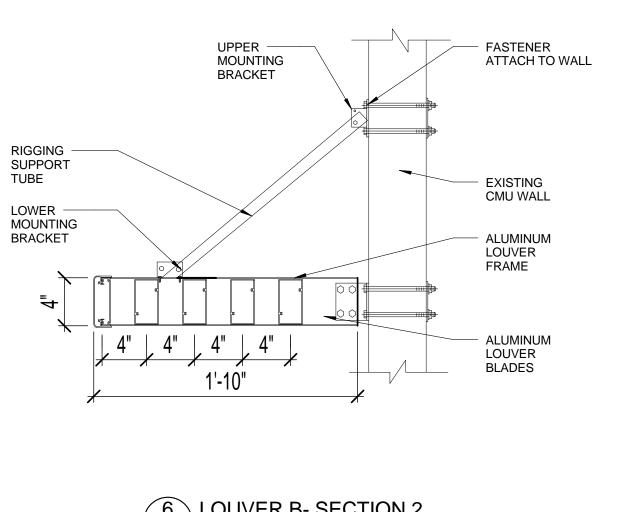

6 LOUVER B- SECTION 2
1 1/2" = 1'-0"

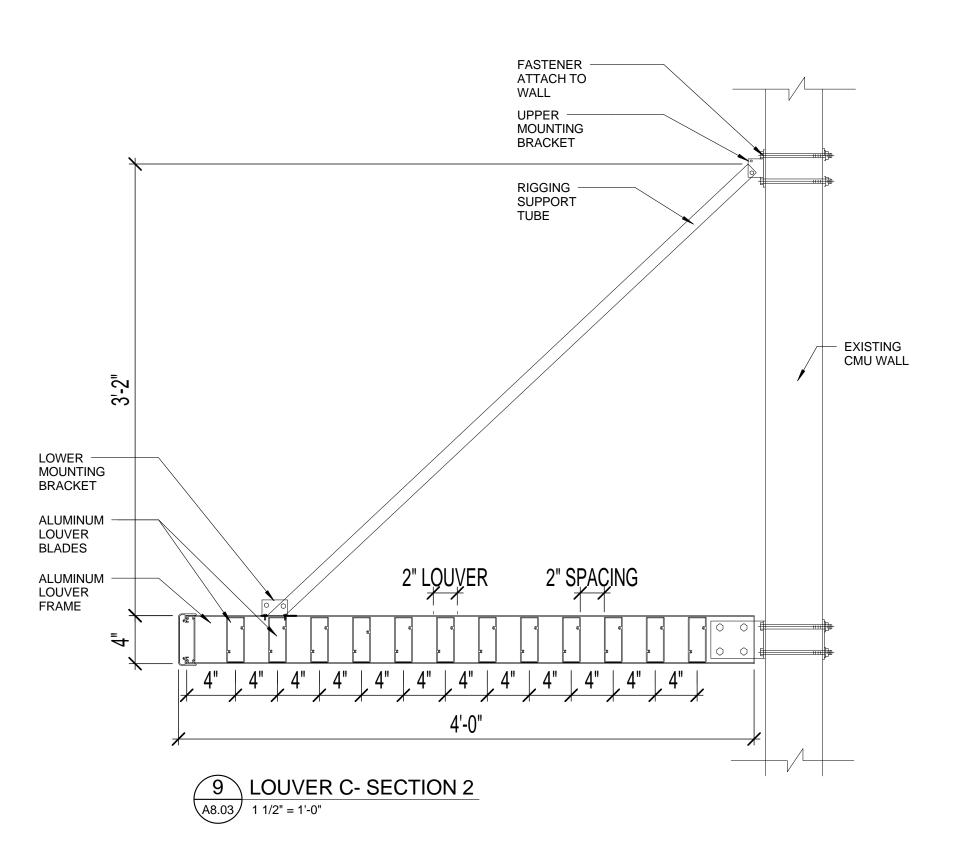

CURRIE

SOWARDS AGUILA architects

Architecture, Planning, Interiors, & Sustainable Design AA26001584

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ISSUED FOR:

SPRAB 3/05/2015

BIDS .

PERMIT 6/29/2015

CONSTRUCTION

Art Warehouse Renovation

313 NE 3rd Street, Delray Beach, Florida 33444

REVISIONS

NUM. DESCRIPTION DATE

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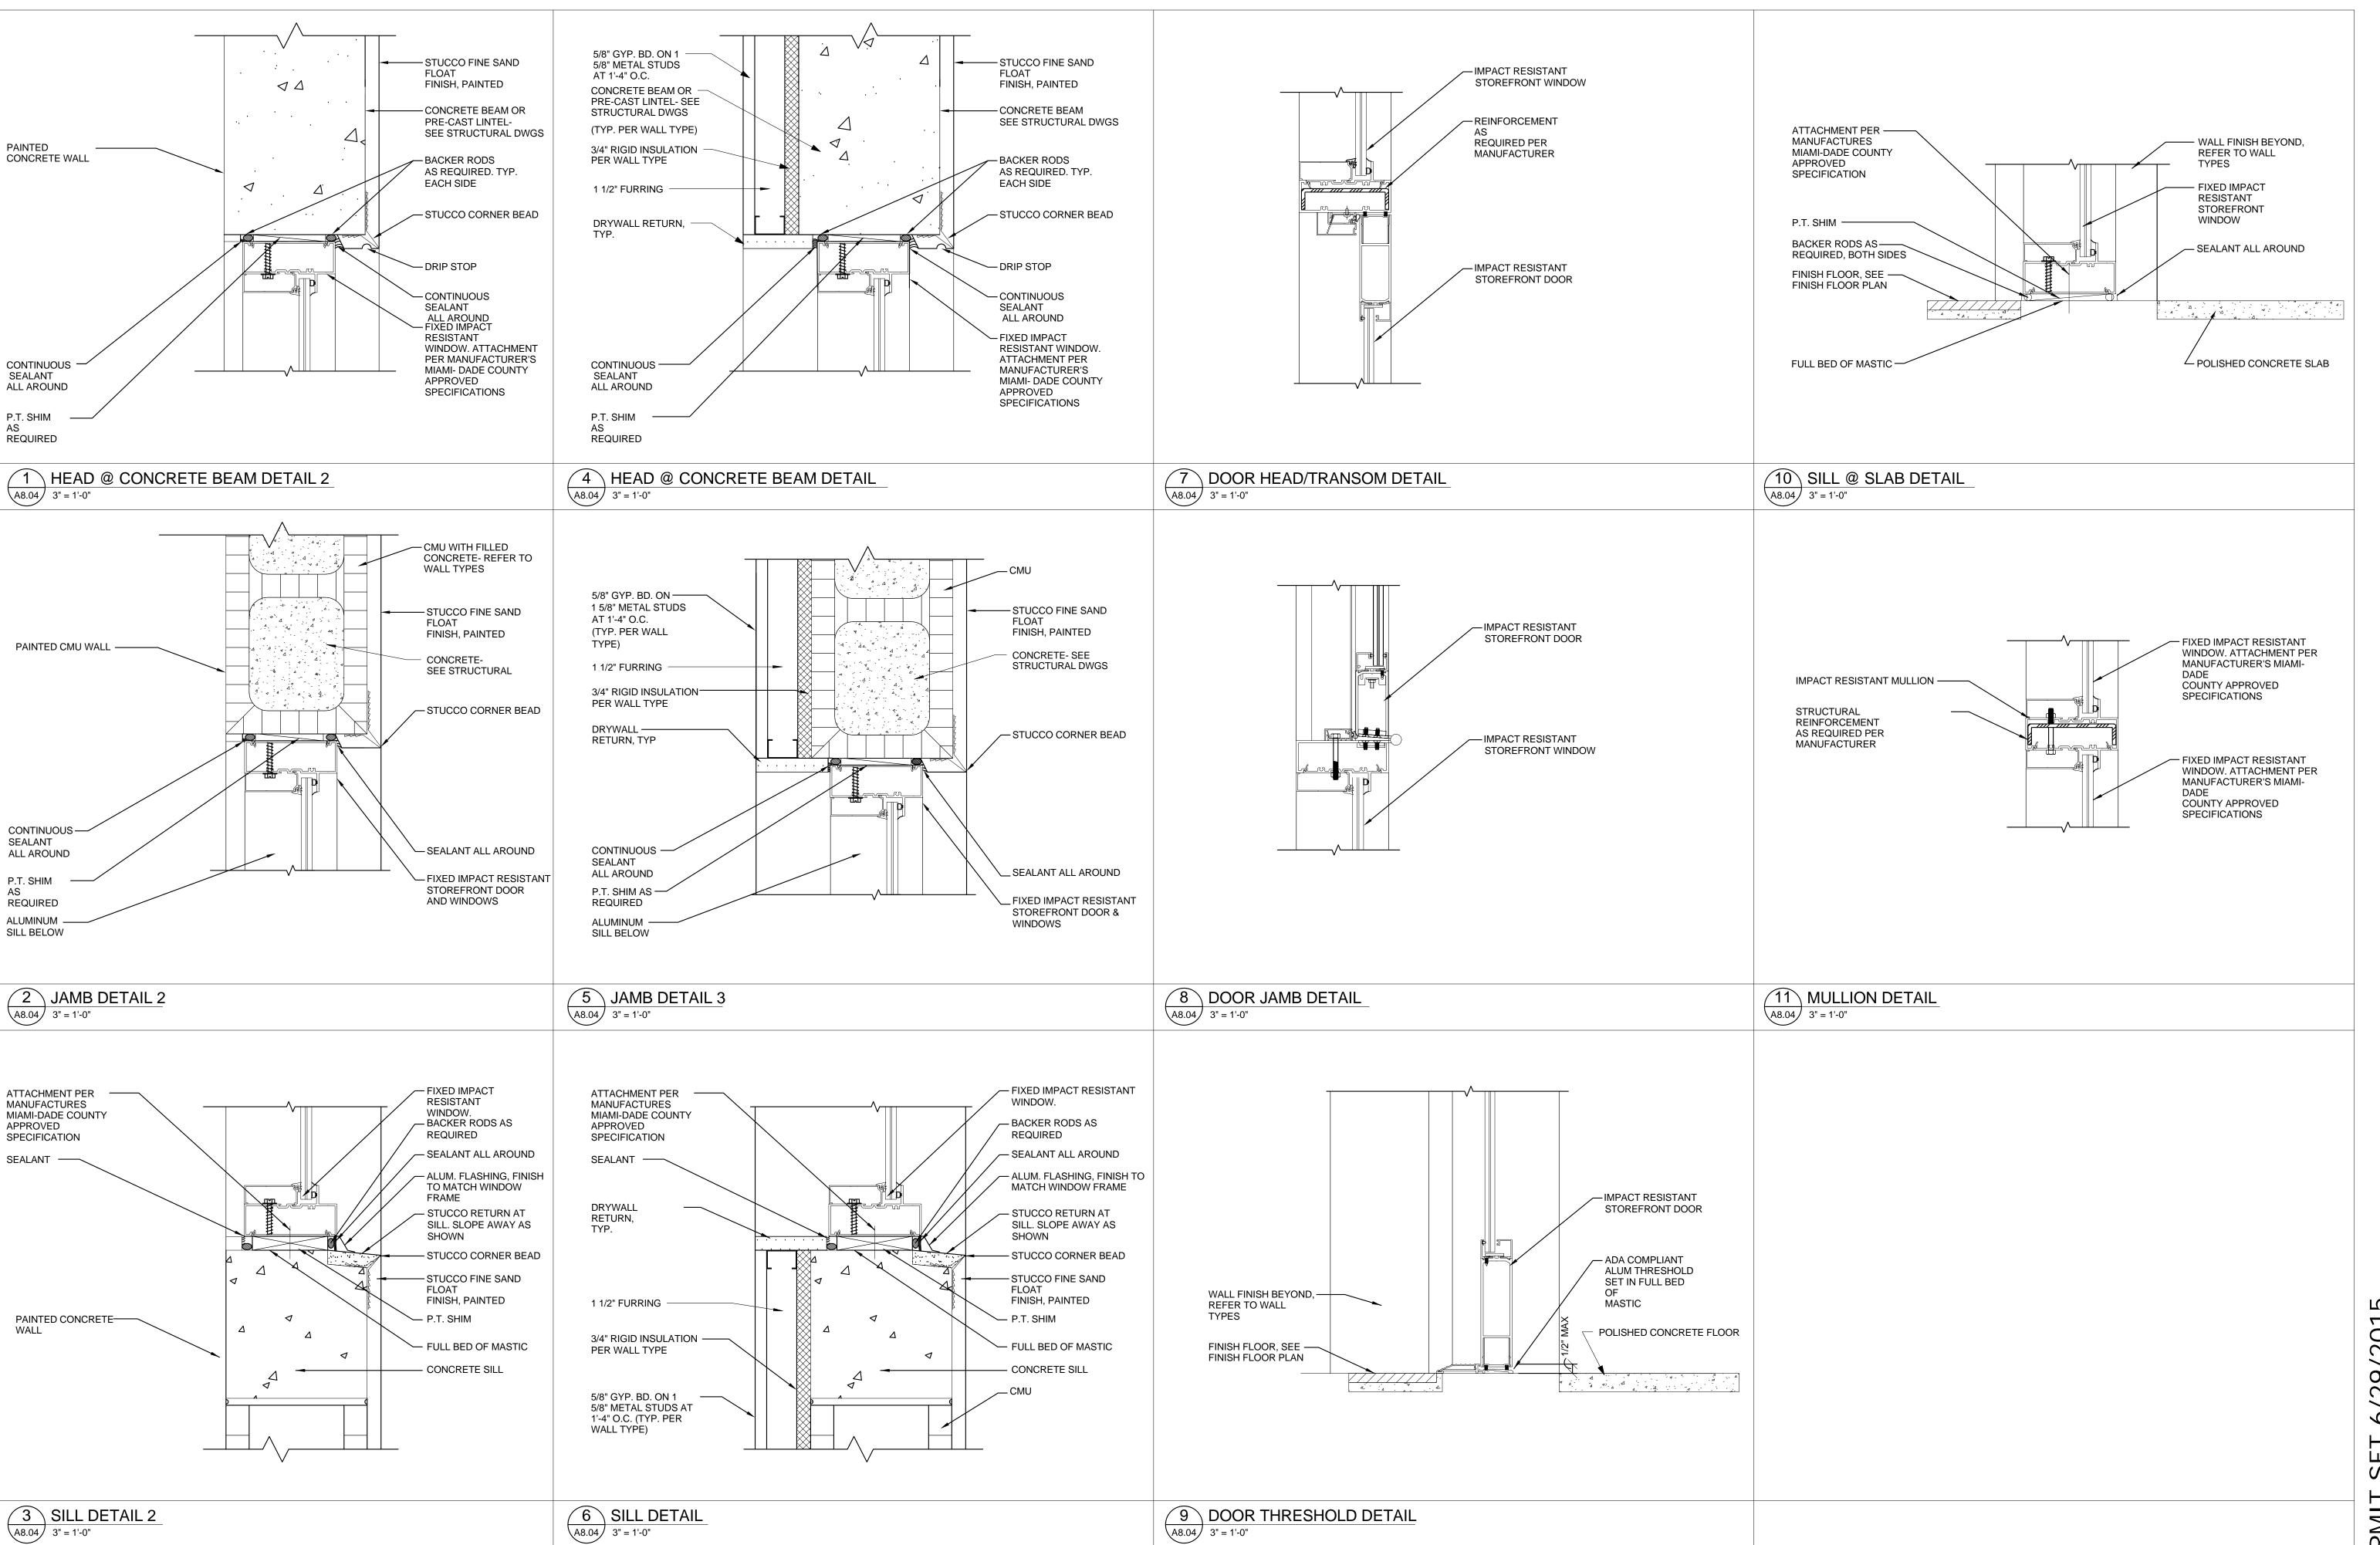
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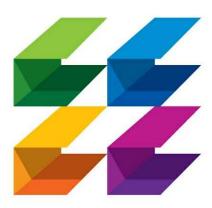
LOUVER DETAILS

9/20

DATE | DRAW | MM | DRAW | DRAW | MM | DRAW | MM | DRAW | DRAW | MM | DRAW | DRAW | MM | DRAW | MM | DRAW | DRAW | DRAW | MM | DRAW | DRAW | DRAW | MM | DRAW |

100701 A DRAWING NUMBER A 8.03





## CURRIE SOWARDS AGUILA

architects

Sustainable Design
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185 NE 4TH AVENUE SUITE 101

DELRAY BEACH, FL 33483

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Interiors, &

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Art Warehouse Renovation

313 NE 3rd Street, Delray Beach, Florida 33444

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WINDOW DETAILS

DATE 6/29/2015 - JOB NUMBER 100701

A8.04

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**CURRIE** 

## **SOWARDS AGUILA**

architects

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185 NE 4TH AVENUE SUITE 101 DELRAY BEACH, FL 33483

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ISSUED FOR :

3/05/2015 6/29/2015

CONSTRUCTION

PROJECT TITLE Art Warehouse

313 NE 3rd Street, Delray Beach, Florida 33444


DESCRIPTION DATE 1 Bldg. Dept. comments


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INCUBATOR\DRAWINGS\100701 -

**CASEWORK DETAILS** 

6/29/2015



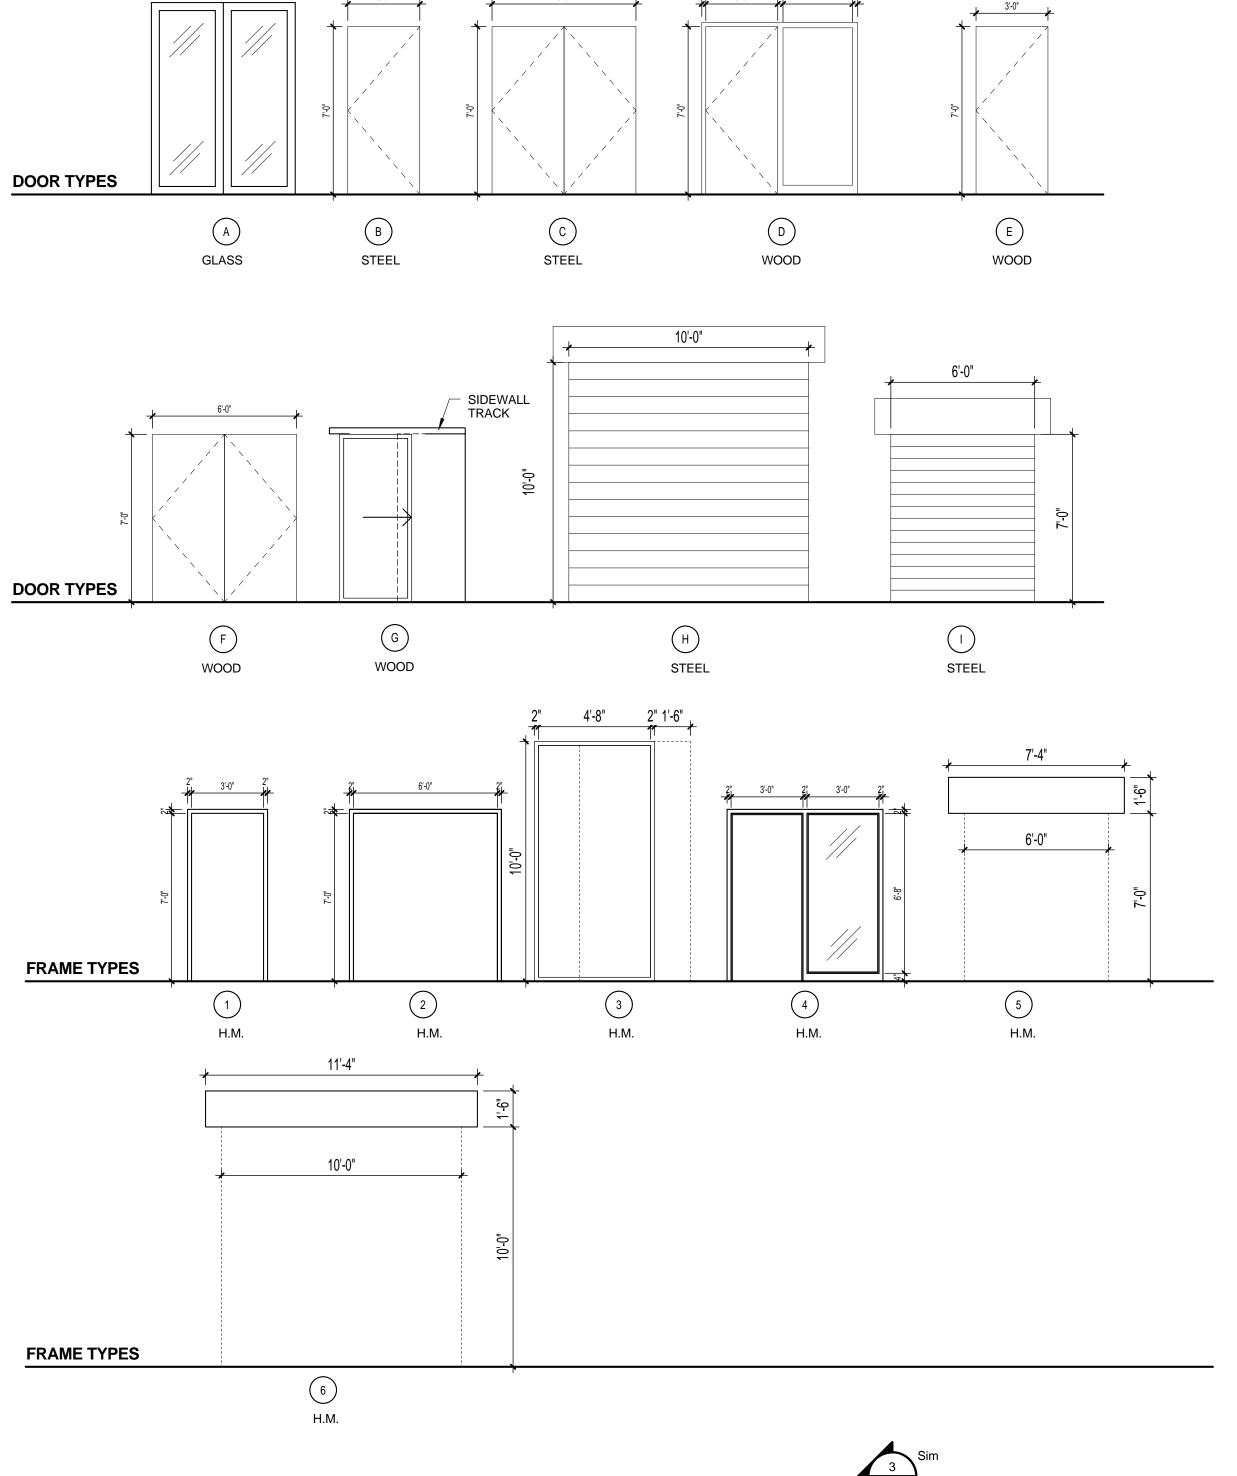


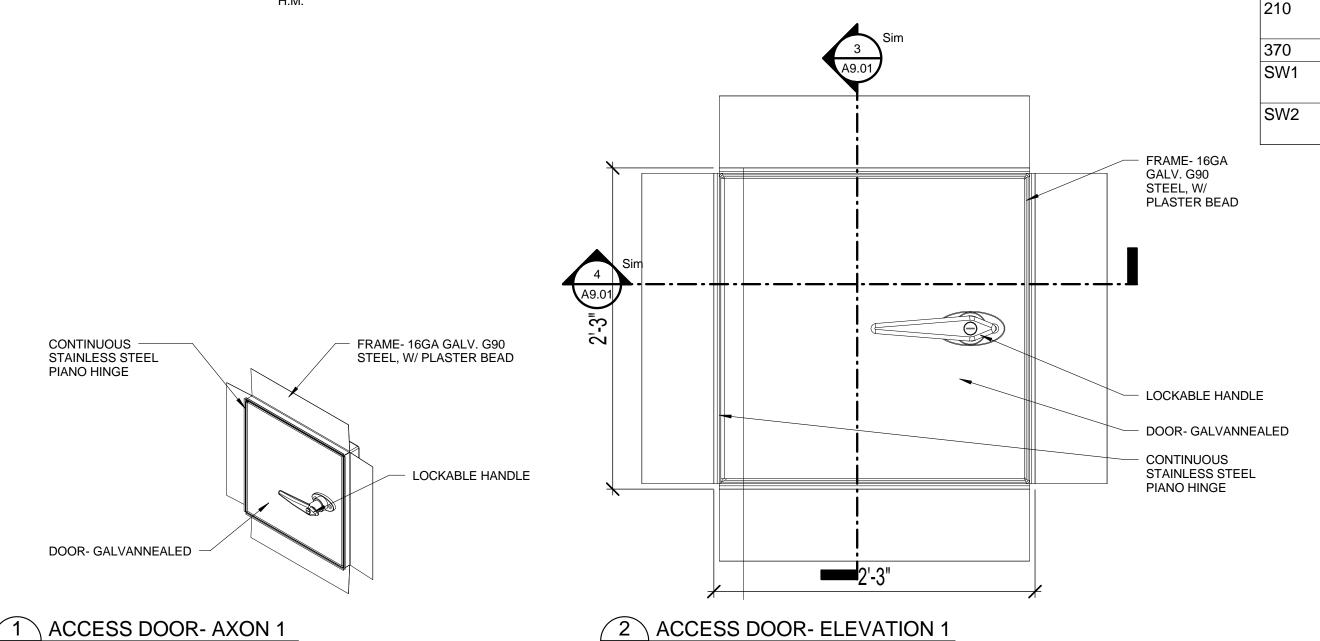A9.01 1 1/2" = 1'-0"

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A9.01 1 1/2" = 1'-0"

DOOR SCHEDULE													
	DOOR SIZE	E		DOOR		Frame	FR	AME		FIRE			
WIDTH	HEIGHT		TYPE	MATERIAL	FINISH	Туре			Assembly Description	1	REMARKS	SIGNAGE	HARDWARE
10' - 0"	10' - 0"	0' - 2"	Н	STEEL	PWD COAT	6	STEEL	POWDER COAT	Overhead Doors		5	OVERHEAD DOOR	ELECTRIC OPERATED
6' - 0"	7' - 0"	0' - 2"	С	STEEL	KYNAR GREEN	2	H.M.	KYNAR GREEN	Exterior Doors		1, 2, 3, 4, 8, 10, 14	EXIT	ENTRANCE
3' - 0"	7' - 0"	0' - 1 3/4"	D	WOOD	STAINED	4	H.M.	PAINT	Interior Doors	-		STUDIO	CLASSROOM
3' - 0"	7' - 0"	0' - 1 3/4"	D	WOOD	STAINED	4	H.M.	PAINT	Interior Doors	-		STUDIO	CLASSROOM
3' - 0"	7' - 0"	0' - 1 3/4"	D	WOOD	STAINED	4	H.M.	PAINT	Interior Doors	-		STUDIO	CLASSROOM
3' - 0"	7' - 0"	0' - 1 3/4"	D	WOOD	STAINED	4	H.M.	PAINT	Interior Doors	-		STUDIO	CLASSROOM
3' - 0"	7' - 0"	0' - 1 3/4"	D	WOOD	STAINED	4	H.M.	PAINT	Interior Doors	-		STUDIO	CLASSROOM
3' - 0"	7' - 0"	0' - 1 3/4"	D	WOOD	STAINED	4	H.M.		Interior Doors	-		STUDIO	CLASSROOM
	1					1			Interior Doors	-			PRIVACY
	7' - 0"		С					FIN	Interior Doors	45 MIN	4, 8		ENTRANCE
			С		FACTORY FIN	1		FIN	Exterior Doors		1, 2, 3, 4, 8, 10, 14	EXIT	ENTRANCE
6' - 0"	7' - 0"	0' - 2"	I	STEEL	PWD COAT	5	H.M.	POWDER COAT	Overhead Doors		5	OVERHEAD DOOR	ELECTRIC OPERATED
3' - 0"	7' - 0"	0' - 1 3/4"	Е	WOOD	STAINED	1	H.M.	PAINT	Interior Doors	-	8	OFFICE	OFFICE
3' - 0"	7' - 0"	0' - 1 3/4"	E	WOOD	STAINED	1	H.M.	PAINT	Interior Doors	-		OFFICE	OFFICE
3' - 0"	7' - 0"	0' - 1 3/4"	E	WOOD	STAINED	1	H.M.	PAINT	Glazed Doors & Entrances			CLASSROOM	CLASSROOM
3' - 0"	7' - 0 1/2"	0' - 1 3/4"	E	WOOD	STAINED	1	STEEL	PAINT	Glazed Doors & Entrances			INCUBATOR	CLASSROOM
6' - 0"	7' - 0"	0' - 2"	F	WOOD	STAINED	2	H.M.	PAINT	Interior Doors		6, 8	BREAK ROOM	CLASSROOM
3' - 0"	7' - 0"	0' - 1 3/4"	Е	WOOD	STAINED	1	H.M.	PAINT	Interior Doors	-	8	WOMEN	DUMMY
3' - 0"	7' - 0"	0' - 1 3/4"	В	WOOD	STAINED	1	H.M.	PAINT	Interior Doors	-	10	STORAGE	STORE ROOM
6' - 0"	7' - 0"	0' - 1 3/4"	R	WOOD	STAINED	2	H.M.	PAINT	Interior Doors	-	10	STORAGE	STORE ROOM
3' - 0"	7' - 0"	0' - 1 3/4"	E	WOOD	STAINED	1	H.M.	PAINT	Interior Doors	-	8	MEN	DUMMY
6' - 0"	7' - 0"	0' - 1 3/4"	Q	WOOD	STAINED	2	H.M.	PAINT	Interior Doors	-	8	LARGE WORK SPACE	ENTRANCE
6' - 0"	7' - 0"	0' - 2"	С	WOOD	STAINED	2	H.M.	PAINT	Interior Doors		8	CORRIDOR	ENTRANCE
3' - 0"	7' - 0"	0' - 1 3/4"	В	STEEL	FACTORY FIN	1	H.M.	FACTORY FIN	Interior Doors	-		JANITOR	STORE ROOM
3' - 0"	7' - 0"	0' - 1 3/4"	В	STEEL	FACTORY FIN	1	H.M.	FACTORY FIN	Interior Doors	-	6, 8	ELECTRICAL	STORE ROOM
3' - 0"	7' - 0"	0' - 1 3/4"	D	WOOD	STAINED	4	H.M.	PAINT	Interior Doors	-		STUDIO	CLASSROOM
3' - 0"	7' - 0"	0' - 1 3/4"	D	WOOD	STAINED	4	H.M.	PAINT	Interior Doors	-		STUDIO	CLASSROOM
3' - 0"	7' - 0"	0' - 1 3/4"	D	WOOD	STAINED	4	H.M.	PAINT	Interior Doors	-		STUDIO	CLASSROOM
			D			4			Interior Doors	-			CLASSROOM
			I			5		COAT			5		ELECTRIC OPERATED
6' - 0"	7' - 0"	0' - 2"	I	STEEL	PWD COAT	5	H.M.	POWDER COAT	Overhead Doors		5	MAKER SPACE	ELECTRIC OPERATED
3' - 0"	7' - 0"	0' - 1 3/4"	В	WOOD	STAINED	1	H.M.	PAINT	Interior Doors	-		MAKER SPACE	CLASSROOM
3' - 0"	7' - 0"	0' - 1 3/4"	D	WOOD	STAINED	4	H.M.	PAINT	Interior Doors	-		MAKER SPACE	CLASSROOM
6' - 0"	7' - 0"		Р	WOOD	STAINED	1			Interior Doors			CORRIDOR	ENTRANCE
			В		GREEN	1		GREEN		-	1		ENTRANCE
			A		WHITE	2	M	WHITE	Exterior Glazed Doors- Aluminum		1, 2, 3, 4, 8, 10, 13, 14		ENTRANCE
3' - 0"	7' - 0"	0' - 1 3/4"	D	WOOD	STAINED	4	H.M.	PAINT	Interior Doors	-		STUDIO	CLASSROOM
						4				-			CLASSROOM
						4				-			CLASSROOM
						4				-			CLASSROOM
						4				-			CLASSROOM
					_	4				-			CLASSROOM
			_			4				-			CLASSROOM
						4				_			CLASSROOM
						4				_			CLASSROOM
						4				_	A		CLASSROOM
			<u> </u>			4				_	14		CLASSROOM
3' - 0"	7' - 0"	0' - 1 3/4"	В	STEEL	KYNAR	1	H.M.	KYNAR	Exterior Doors		8, 14	NOT AN EXIT	ENTRANCE
6' - 0"	7' - 0"	0' - 2"	F	WOOD		2	H M		Interior Doors			STORAGE	STORE ROOM
3' - 0"	7' - 0"	0' - 2"	В	STEEL	FACTORY	1	H.M.	FACTORY	Interior Doors  Interior Doors	-	1, 4, 8	STAIR	ENTRANCE
	7' - 0"	0' - 1 3/4"	В	STEEL	FACTORY	4	H.M.	FACTORY	Interior Doors		1, 4, 8	STAIR	ENTRANCE
	10' - 0"  6' - 0"  3' - 0"  3' - 0"  3' - 0"  3' - 0"  3' - 0"  6' - 0"  6' - 0"  3' - 0"	WIDTH         HEIGHT           10' - 0"         10' - 0"           6' - 0"         7' - 0"           3' - 0"         7' - 0"           3' - 0"         7' - 0"           3' - 0"         7' - 0"           3' - 0"         7' - 0"           3' - 0"         7' - 0"           3' - 0"         7' - 0"           3' - 0"         7' - 0"           6' - 0"         7' - 0"           3' - 0"         7' - 0"           3' - 0"         7' - 0"           3' - 0"         7' - 0"           3' - 0"         7' - 0"           3' - 0"         7' - 0"           3' - 0"         7' - 0"           3' - 0"         7' - 0"           3' - 0"         7' - 0"           3' - 0"         7' - 0"           3' - 0"         7' - 0"           3' - 0"         7' - 0"           3' - 0"         7' - 0"           3' - 0"         7' - 0"           3' - 0"         7' - 0"           3' - 0"         7' - 0"           3' - 0"         7' - 0"           3' - 0"         7' - 0"           3' - 0"         7' - 0"           3' - 0" <t< td=""><td>10' - 0"         10' - 0"         0' - 2"           6' - 0"         7' - 0"         0' - 2"           3' - 0"         7' - 0"         0' - 1 3/4"           3' - 0"         7' - 0"         0' - 1 3/4"           3' - 0"         7' - 0"         0' - 1 3/4"           3' - 0"         7' - 0"         0' - 1 3/4"           3' - 0"         7' - 0"         0' - 1 3/4"           3' - 0"         7' - 0"         0' - 1 3/4"           3' - 0"         7' - 0"         0' - 1 3/4"           3' - 0"         7' - 0"         0' - 1 3/4"           6' - 0"         7' - 0"         0' - 2"           6' - 0"         7' - 0"         0' - 1 3/4"           6' - 0"         7' - 0"         0' - 1 3/4"           3' - 0"         7' - 0"         0' - 1 3/4"           3' - 0"         7' - 0"         0' - 1 3/4"           3' - 0"         7' - 0"         0' - 1 3/4"           3' - 0"         7' - 0"         0' - 1 3/4"           6' - 0"         7' - 0"         0' - 1 3/4"           3' - 0"         7' - 0"         0' - 1 3/4"           3' - 0"         7' - 0"         0' - 1 3/4"           3' - 0"         7' - 0"         0' - 1 3/4"     <!--</td--><td>WIDTH         HEIGHT         THICKNESS         TYPE           10' - 0"         10' - 2"         H           6' - 0"         7' - 0"         0' - 2"         C           3' - 0"         7' - 0"         0' - 1 3/4"         D           3' - 0"         7' - 0"         0' - 1 3/4"         D           3' - 0"         7' - 0"         0' - 1 3/4"         D           3' - 0"         7' - 0"         0' - 1 3/4"         D           3' - 0"         7' - 0"         0' - 1 3/4"         D           3' - 0"         7' - 0"         0' - 1 3/4"         D           3' - 0"         7' - 0"         0' - 1 3/4"         D           3' - 0"         7' - 0"         0' - 1 3/4"         E           6' - 0"         7' - 0"         0' - 2"         C           6' - 0"         7' - 0"         0' - 1 3/4"         E           3' - 0"         7' - 0"         0' - 1 3/4"         E           3' - 0"         7' - 0"         0' - 1 3/4"         E           3' - 0"         7' - 0"         0' - 1 3/4"         E           6' - 0"         7' - 0"         0' - 1 3/4"         B           6' - 0"         7' - 0"         0' - 1 3/4"</td><td>WIDTH         HEIGHT         THICKNESS         TYPE         MATERIAL           10 - 0"         10 - 0"         0 - 2"         H         STEEL           6' - 0"         7' - 0"         0' - 2"         C         STEEL           3' - 0"         7' - 0"         0' - 1 3/4"         D         WOOD           3' - 0"         7' - 0"         0' - 1 3/4"         D         WOOD           3' - 0"         7' - 0"         0' - 1 3/4"         D         WOOD           3' - 0"         7' - 0"         0' - 1 3/4"         D         WOOD           3' - 0"         7' - 0"         0' - 1 3/4"         D         WOOD           3' - 0"         7' - 0"         0' - 1 3/4"         D         WOOD           3' - 0"         7' - 0"         0' - 1 3/4"         E         WOOD           3' - 0"         7' - 0"         0' - 2"         L         STEEL           6' - 0"         7' - 0"         0' - 1 3/4"         E         WOOD           3' - 0"         7' - 0"         0' - 1 3/4"         E         WOOD           3' - 0"         7' - 0"         0' - 1 3/4"         E         WOOD           3' - 0"         7' - 0"         0' - 1 3/4"         E<td>  WIDTH</td><td>  WIDTH</td><td>  WIDTH   HEIGHT THICKNESS   TYPE   MATERIAL   FINISH   10'-0'   10'-0'   0'-2'   H   STEEL   PWD COAT   6   STEEL   STEEL   RYNAR   2   M.M.   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M.M.</td><td>  WODD</td><td>  WIDTO   FOR   Property   WALTENAL   FINSH   Assembly Description   Property   Property</td><td>  MOTION</td><td>  MOTION   10-04   10-05   10-</td><td>  March   Mische   Mi</td></td></td></t<>	10' - 0"         10' - 0"         0' - 2"           6' - 0"         7' - 0"         0' - 2"           3' - 0"         7' - 0"         0' - 1 3/4"           3' - 0"         7' - 0"         0' - 1 3/4"           3' - 0"         7' - 0"         0' - 1 3/4"           3' - 0"         7' - 0"         0' - 1 3/4"           3' - 0"         7' - 0"         0' - 1 3/4"           3' - 0"         7' - 0"         0' - 1 3/4"           3' - 0"         7' - 0"         0' - 1 3/4"           3' - 0"         7' - 0"         0' - 1 3/4"           6' - 0"         7' - 0"         0' - 2"           6' - 0"         7' - 0"         0' - 1 3/4"           6' - 0"         7' - 0"         0' - 1 3/4"           3' - 0"         7' - 0"         0' - 1 3/4"           3' - 0"         7' - 0"         0' - 1 3/4"           3' - 0"         7' - 0"         0' - 1 3/4"           3' - 0"         7' - 0"         0' - 1 3/4"           6' - 0"         7' - 0"         0' - 1 3/4"           3' - 0"         7' - 0"         0' - 1 3/4"           3' - 0"         7' - 0"         0' - 1 3/4"           3' - 0"         7' - 0"         0' - 1 3/4" </td <td>WIDTH         HEIGHT         THICKNESS         TYPE           10' - 0"         10' - 2"         H           6' - 0"         7' - 0"         0' - 2"         C           3' - 0"         7' - 0"         0' - 1 3/4"         D           3' - 0"         7' - 0"         0' - 1 3/4"         D           3' - 0"         7' - 0"         0' - 1 3/4"         D           3' - 0"         7' - 0"         0' - 1 3/4"         D           3' - 0"         7' - 0"         0' - 1 3/4"         D           3' - 0"         7' - 0"         0' - 1 3/4"         D           3' - 0"         7' - 0"         0' - 1 3/4"         D           3' - 0"         7' - 0"         0' - 1 3/4"         E           6' - 0"         7' - 0"         0' - 2"         C           6' - 0"         7' - 0"         0' - 1 3/4"         E           3' - 0"         7' - 0"         0' - 1 3/4"         E           3' - 0"         7' - 0"         0' - 1 3/4"         E           3' - 0"         7' - 0"         0' - 1 3/4"         E           6' - 0"         7' - 0"         0' - 1 3/4"         B           6' - 0"         7' - 0"         0' - 1 3/4"</td> <td>WIDTH         HEIGHT         THICKNESS         TYPE         MATERIAL           10 - 0"         10 - 0"         0 - 2"         H         STEEL           6' - 0"         7' - 0"         0' - 2"         C         STEEL           3' - 0"         7' - 0"         0' - 1 3/4"         D         WOOD           3' - 0"         7' - 0"         0' - 1 3/4"         D         WOOD           3' - 0"         7' - 0"         0' - 1 3/4"         D         WOOD           3' - 0"         7' - 0"         0' - 1 3/4"         D         WOOD           3' - 0"         7' - 0"         0' - 1 3/4"         D         WOOD           3' - 0"         7' - 0"         0' - 1 3/4"         D         WOOD           3' - 0"         7' - 0"         0' - 1 3/4"         E         WOOD           3' - 0"         7' - 0"         0' - 2"         L         STEEL           6' - 0"         7' - 0"         0' - 1 3/4"         E         WOOD           3' - 0"         7' - 0"         0' - 1 3/4"         E         WOOD           3' - 0"         7' - 0"         0' - 1 3/4"         E         WOOD           3' - 0"         7' - 0"         0' - 1 3/4"         E<td>  WIDTH</td><td>  WIDTH</td><td>  WIDTH   HEIGHT THICKNESS   TYPE   MATERIAL   FINISH   10'-0'   10'-0'   0'-2'   H   STEEL   PWD COAT   6   STEEL   STEEL   RYNAR   2   M.M.   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#### **GENERAL NOTES:**

- ALL NEW WOOD DOORS & FRAMES TO BE STAINED TO MATCH SAMPLE PROVIDED BY ARCHITECT.
- AT GYP. BD. / STUD LOCATE DOOR JAMB 4" FROM NEAREST
- ADJACENT CORNER TYPICAL UNLESS OTHERWISE NOTED. ALL DOORS TO BE PROVIDED WITH HINGES, DOOR SILENCERS,
- APPROPRIATE TO THE CONFIGURATION OF THE DOOR.
- ASTRAGALS & COORDINATORS AND WALL BUMPERS AS ALL HARDWARE TO BE HANDICAP ACCESSIBLE.
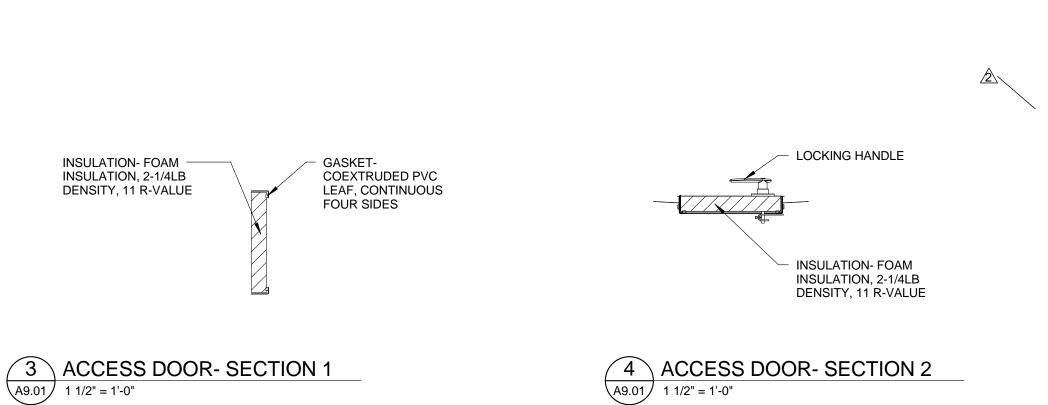
### **REMARKS:**

- PANIC HARDWARE
- TAMPER PROOF HINGES
- WEATHER STRIPPING
- . FIRE EXIT HARDWARE
- OVERHEAD COILING MOTOR OPERATED
- SOUND SEAL AROUND DOOR AND PROVIDE DOOR SWEEP INSWING FOLDING GLASS WALL SYSTEM (NOT USED)
- CLOSER . OVERHEAD COILING MANUAL OPERATED
- 0. PROVIDE LOCK 11. SURFACE APPLIED MOLDING PER ARCHITECT
  12. COUNTER HEIGHT INSWING FOLDING GLASS WALL SYSTEM
- 13. CONCEALED JAMB14. IMPACT RESISTANT
- 15. OCCUPIED DOOR SIGN 16. PROVIDE AIR TIGHT DOOR LEAK SEAL

100701

7

**CURRIE SOWARDS AGUILA** architects

Interiors, & Sustainable Design AA26001584 185 NE 4TH AVENUE SUITE 101

Architecture, Planning,

DELRAY BEACH, FL 33483 T: (561) 276-4951 F: (561) 243-8184 E-MAIL: office@csa-architects.com

ISSUED FOR : 3/05/2015

6/29/2015 PERMIT CONSTRUCTION

SEAL

PROJECT TITLE Art Warehouse Renovation

313 NE 3rd Street, Delray Beach, Florida 33444

REVISIONS						
NUM.	DESCRIPTION	DATE				
1	Bldg. Dept. comments	8/21/ 2015				
2	Bldg. Dept. comments	10/23/ 2015				

THESE DRAWINGS ARE PREPARED PER ESTABLISHED INDUSTRY STANDARDS AND REPRESENT THE ARCHITECT AND ENGINEERS DESIGN CONCEPT. THEY ARE NOT INTENDED TO PROVIDE EVERY DETAIL OR CONDITION REQUIRED TO CONSTRUCT THE BUILDING. THE CONTRACTOR THROUGH SUBMITTALS AND OTHER COORDINATION EFFORTS IS FULLY RESPONSIBLE FOR PROVIDING A COMPLETE AND OPERATIONAL BUILDING WHETHER INDICATED ON THE PLANS OR NOT.


FILE NUMBER
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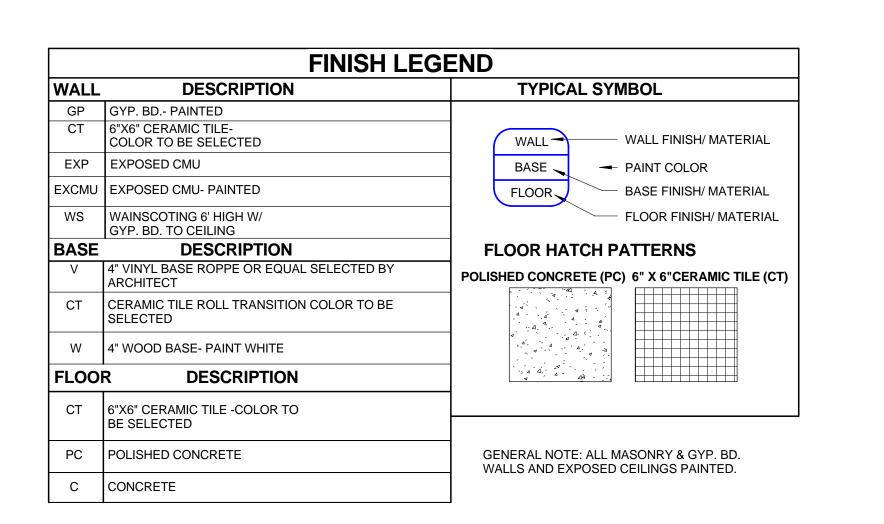
LO DRAWING TITLE DOOR SCHEDULE

 $\stackrel{\sim}{\sim}$  & DETAILS

6/29/2015





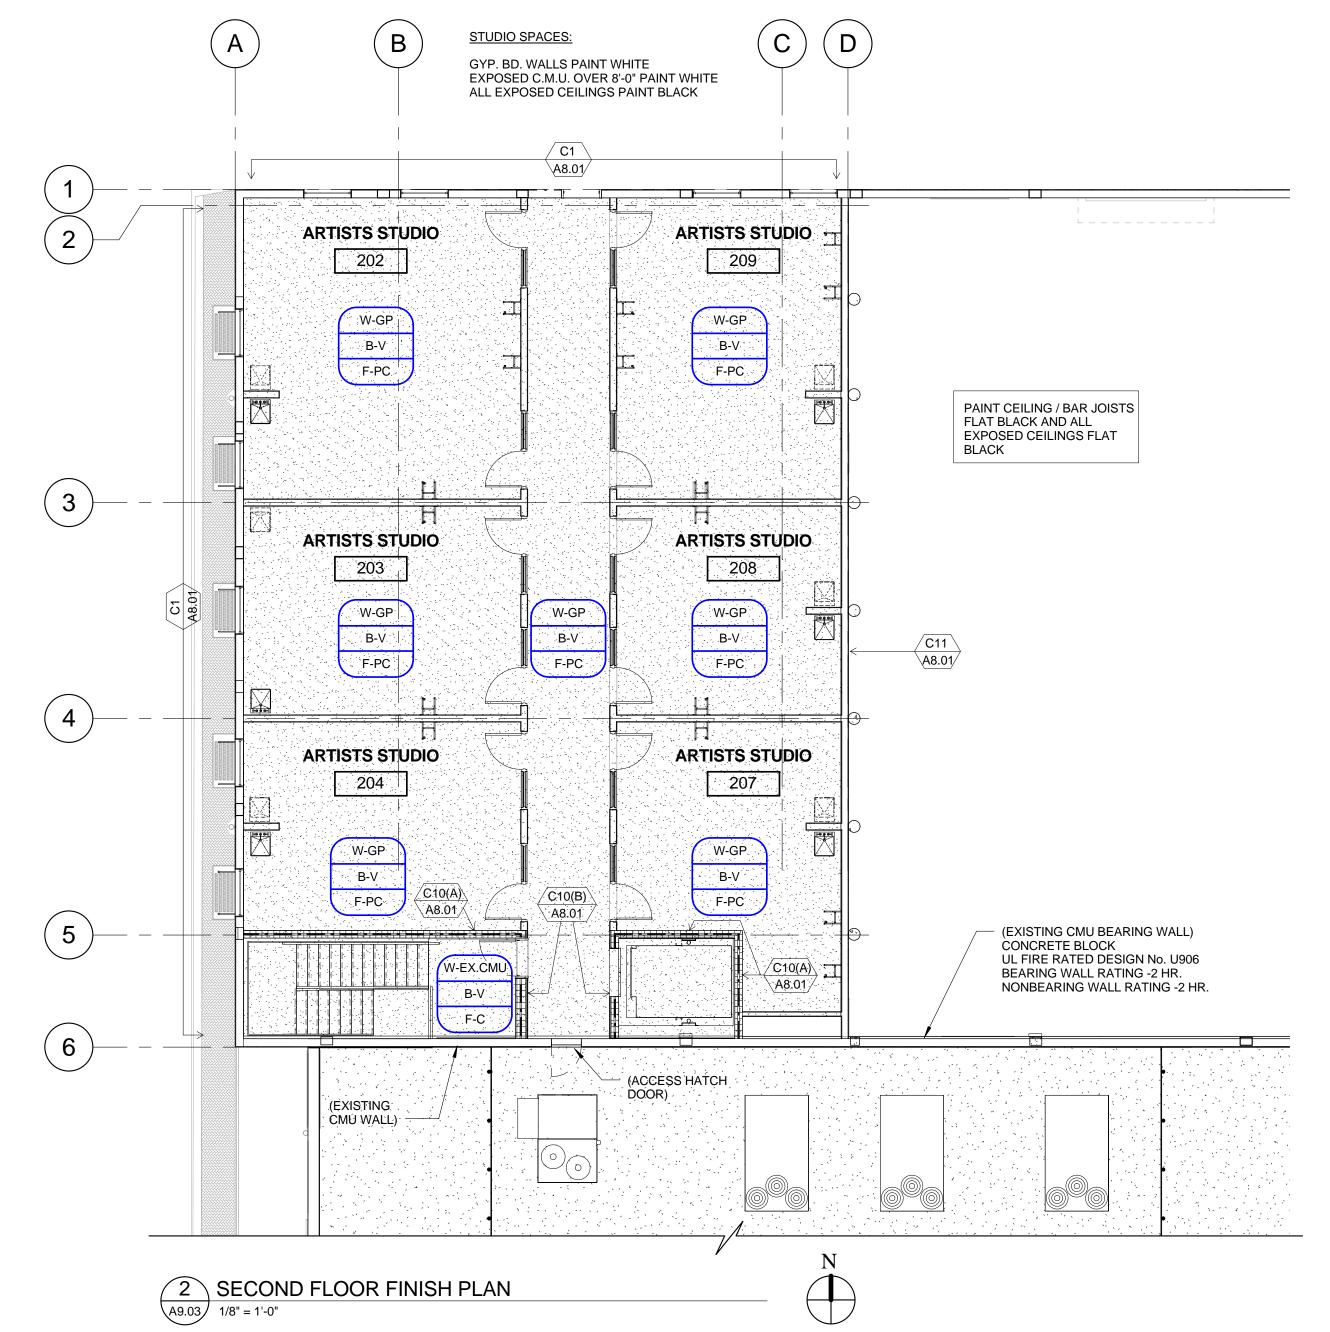



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DRAWING TITLE

FINISH PLAN

- 2. CONTRACTOR IS RESPONSIBLE FOR MEANS AND METHODS OF CONSTRUCTION TO ENSURE THE SAFETY OF THE BUILDING UNTIL STRUCTURAL SYSTEM IS COMPLETED. THIS INCLUDES, BUT IS NOT LIMITED TO, THE ADDITION OF WHATEVER TEMPORARY BRACING, SHORING, GUYS OR TIE\_DOWNS THAT MAY BE NECESSARY. SUCH MATERIAL SHALL BE REMOVED AND SHALL REMAIN THE PROPERTY OF THE CONTRACTOR AFTER COMPLETION OF THE PROJECT.
- CONTRACTOR TO SUPPORT, BRACE AND SECURE EXISTING STRUCTURE AS REQUIRED. CONTRACTOR IS SOLELY RESPONSIBLE FOR THE SAFETY OF THE BUILDING DURING CONSTRUCTION.
- 4. APPLICABLE BUILDING CODE: 2010 FLORIDA BUILDING CODE.
- 5. GRAVITY DESIGN LOADS:

	SUPERIMPOSED	TOTAL
<u>AREA</u>	LIVE LOAD	<u>DEAD LOAD</u>
ROOF	30 PSF	25 PSF
MEZZANINE	125 PSF	55 PSF

DESIGN SOIL BERING PRESSURE =1500 PSF. PROVIDE ONE COMPACTION TEST AT EACH FOOTING TO VERIFY COMPACTION. SUBMIT S&S GEOTECHNICAL COMPACTION REPORT TO ARCH. & BUILDING DEPARTMENT.

⟨WIND DESIGN CRITERIA:

ULTIMATE BASIC WIND SPEED: Vult = 170 MPH (3 SECOND GUST)

EQUIVALENT NOMINAL BASIC WIND SPEED VASD = 132 MPH (3 SECOND GUST)

/risk category = II EXPOSURE CATEGORY = C

ENCLOSED BUILDING INTERNAL PRESSURE COEFFICIENT, GCPI=  $\pm$ /-0.18

WIND BORNE DEBRIS REGION

8. \( ALL MATERIALS AND WORKMANSHIP SHALL BE IN ACCORDANCE WITH THE REFERENCED BUILDING \( / \)

9. \ COORDINATE ALL DIMENSIONS AND ELEVATIONS WITH THE ARCHITECTURAL DRAWINGS. DO NOT / ) SCALE DRAWINGS.

10. CONTACT ENGINEER WITH ANY QUESTIONS OR DISCREPANCIES FOUND ON DRAWINGS.

11. SECTIONS AND DETAILS ARE REFERENCED IN TYPICAL LOCATIONS BUT ALSO APPLY TO ALL OTHER SIMILAR CONDITIONS.

12.) CONTRACTOR TO VERIFY ALL EXISTING DIMENSIONS, ELEVATIONS, AND CONDITIONS PRIOR TO ( BEGINNING CONSTRUCTION.

13.) SUBMIT SHOP DRAWINGS AS REQUIRED HEREIN. ALLOW FOR TWO WEEKS REVIEW TIME AFTER RECEIPT OF SUBMITTALS BY THIS FIRM. ALL SUBMITTALS SHALL BE CHECKED AND SIGNED BY THE GENERAL CONTRACTOR AND SIGNED/SEALED BY THE DELEGATED ENGINEER, WHERE SPECIFIED HEREIN.

14. \CONTRACTOR SHALL NOT BE RELIEVED FROM RESPONSIBILITY FOR ERRORS OR OMISSIONS IN  $\S$  SHOP DRAWINGS OR MIX DESIGNS BY THE ENGINEER'S REVIEW THEREOF.

15. ANY CHANGES TO THE STRUCTURE SHALL HAVE BEEN REVIEWED AND APPROVED IN WRITING BY THE ENGINEER PRIOR TO COMMENCING WORK ON ITEMS AFFECTED.

16. CONTRACTOR SHALL NOTIFY THIS OFFICE WHEN THE STRUCTURAL SYSTEM IS SUBSTANTIALLY COMPLETED, AND BEFORE SHEATHING, CEILINGS, OR ROOFING IS INSTALLED.

#### **HAND RAILS**

- 1. AN ENGINEER REGISTERED IN THE STATE OF FLORIDA SHALL DESIGN RAILING SYSTEM AND CONNECTION OF IT TO THIS STRUCTURE.
- 2. SUBMIT SHOP DRAWINGS BEARING THE EMBOSSED SEAL AND THE SIGNATURE OF THE ENGINEER FOR REVIEW PRIOR TO FABRICATION.
- 3. THE CONFIGURATION OF THE RAILING SYSTEM SHALL BE AS SHOWN ON THE ARCHITECTURAL DRAWINGS.
- 4. RAILING SYSTEM AND CONNECTIONS SHALL BE DESIGNED FOR APPLICABLE LOADS AS INDICATED ON THE PLANS AND IN THE BUILDING CODE. THE LOADS SHALL BE CLEARLY INDICATED ON SHOP DRAWINGS.
- 5. SHOP DRAWINGS SHALL SHOW AND SPECIFY CONNECTIONS UTILIZED WITHIN THE RAILING SYSTEM AS WELL AS CONNECTIONS TO AND LOADS IMPOSED UPON THE STRUCTURAL SYSTEM SHOWN ON THESE PLANS.

#### **GLAZED CURTAIN WALL, STOREFRONT, WINDOW AND DOOR SYSTEMS**

- 1. EXTERIOR GLAZED OPENINGS SHALL BE DESIGNED IN ACCORDANCE WITH ACCEPTED ENGINEERING PRINCIPLES AND GOVERNING CODES.
- 2. THIS BUILDING HAS BEEN DESIGNED AS "ENCLOSED". REFER TO THE STRUCTURAL DRAWINGS FOR 7. CONCRETE MATERIALS COMPONENTS AND CLADDING MINIMUM DESIGN WIND PRESSURES.
- 3. IF THIS SITE IS LOCATED WITHIN A WIND BORNE DEBRIS REGION, AS SHOWN IN FIGURE 1609 OF THE FLORIDA BUILDING CODE, ALL EXTERIOR GLAZED OPENINGS SHALL BE DESIGNED AND TESTED FOR MISSILE IMPACT OR PROTECTED BY APPROVED SCREENS OR SHUTTERS.
- 4. A LICENSED PROFESSIONAL ENGINEER SHALL DESIGN THE EXTERIOR GLAZED SYSTEMS, SHOP DRAWINGS, AND OVERSEE ANY LOAD TESTING.
- 5. SIGNED AND SEALED SHOP DRAWINGS, NOTICE OF ACCEPTANCE (NOA), OR FLORIDA PRODUCT APPROVAL DOCUMENTATION SHALL BE SUBMITTED IN ACCORDANCE WITH THE ARCHITECT'S REQUIREMENTS.

#### **DELEGATED ENGINEER**

1. WHERE NOTED HEREIN, A LICENSED PROFESSIONAL (DELEGATED) ENGINEER SHALL BE RETAINED TO DESIGN THE PRODUCT OR ASSEMBLY.

2. THE DELEGATED ENGINEER SHALL BE EXPERIENCED IN THE DESIGN OF THE REFERENCED PRODUCT OR

3. THE DELEGATED ENGINEER MUST BE PROVIDED WITH A COPY OF THESE DRAWINGS AND SPECIFICATIONS.

4. IT IS THE DELEGATED ENGINEER'S RESPONSIBILITY TO REVIEW THE ENGINEER OF RECORD'S WRITTEN ENGINEERING REQUIREMENTS AND AUTHORIZATION FOR THE DELEGATED ENGINEERING DOCUMENT TO DETERMINE THE APPROPRIATE SCOPE OF ENGINEERING.

THE DELEGATED ENGINEERING DOCUMENT SHALL COMPLY WITH THE WRITTEN ENGINEERING REQUIREMENTS RECEIVED FROM THE ENGINEER OF RECORD. THEY SHALL INCLUDE THE PROJECT IDENTIFICATION AND THE CRITERIA USED AS A BASIS FOR ITS PREPARATION. IF A DELEGATED ENGINEER DETERMINES THERE ARE DETAILS, FEATURES OR UNANTICIPATED PROJECT LIMITS WHICH CONFLICT WITH THE WRITTEN ENGINEERING REQUIREMENTS PROVIDED BY THE ENGINEER OF RECORD, THE DELEGATED ENGINEER SHALL TIMELY CONTACT THE ENGINEER OF RECORD FOR RESOLUTION OF CONFLICTS.

- 6. THE DELEGATED ENGINEER SHALL FORWARD THE DELEGATED ENGINEERING DOCUMENT TO THE ENGINEER OF RECORD FOR REVIEW. ALL FINAL DELEGATED ENGINEERING DOCUMENTS REQUIRE THE IMPRESSED SEAL AND SIGNATURE OF THE DELEGATED ENGINEER AND INCLUDE:
- A) DRAWINGS INTRODUCING ENGINEERING INPUT SUCH AS DEFINING THE CONFIGURATION OR STRUCTURAL CAPACITY OF STRUCTURAL COMPONENTS AND/OR THEIR ASSEMBLY INTO STRUCTURAL SYSTEMS.
- B) CALCULATIONS.

#### EXISTING BUILDINGS

INFORMATION ON THE EXISTING BUILDING, SHOWN ON THESE PLANS, IS OBTAINED FROM EXISTING BUILDING PLANS BY CSA ARCHITECTS, DATED APRIL 6, 2015. EXISTING INFORMATION DOES NOT NECESSARILY REFLECT AS-BUILT CONDITIONS. THE CONTRACTOR SHALL VERIFY ALL INFORMATION SHOWN ON THESE PLANS AND NOTIFY THE ENGINEER OF ANY VARIATION.

#### SITE WORK

1. A QUALIFIED TESTING LABORATORY SHALL BE RETAINED TO PERFORM THE FOLLOWING MINIMUM TESTS. A) ONE DENSITY TEST FOR EACH 2,000 SQUARE FEET OF COMPACTED SUBGRADE AND COMPACTED FILL.

B) ONE DENSITY TEST AT EACH COLUMN FOOTING.

C) ONE DENSITY TEST PER 50 FEET OF WALL FOOTING.

2. THE GEOTECHNICAL ENGINEER SHALL DETERMINE THE METHOD OF TESTING. (BORINGS, PROBES, HAND AUGERS, ETC.)

. A SIGNED/SEALED SOILS COMPACTION REPORT SHALL BE SUBMITTED TO THE A/E, WHICH SHALL INCLUDE CONSTRUCTION TESTING REQUIREMENTS.

4. SINCE FOUNDATION DESIGN INFORMATION WAS NOT AVAILABLE AT THE TIME THESE DRAWINGS WERE PREPARED, THE FOLLOWING ASSUMPTIONS WERE MADE:

A) MAXIMUM BEARING PRESSURE = 1500 PSF

B) MAXIMUM SETTLEMENT = 3/4"

C) MAXIMUM DIFFERENTIAL SETTLEMENT = 1/2"

ONE COPY OF ALL TEST REPORTS SHALL BE SENT DIRECTLY TO OWNER, ARCHITECT, STRUCTURAL ENGINEER, AND GENERAL CONTRACTOR.

FOUNDATION WALLS THAT RETAIN EARTH SHALL BE BRACED AGAINST BACKFILLING PRESSURES UNTIL FLOOR SLABS AT TOP AND BOTTOM ARE IN PLACE.

7. THE SIDES OF FOOTINGS SHALL BE FORMED WITH PLYWOOD.

3. EXERCISE CARE WHEN COMPACTING NEAR ADJACENT STRUCTURES. FOLLOW THE RECOMMENDATIONS IN THE SOILS REPORT AND DOCUMENT EXISTING CONDITIONS WITH PHOTOGRAPHS PRIOR TO STARTING WORK.

PRIOR TO CONSTRUCTION, CONTRACTOR SHALL LOCATE ALL EXISTING UNDERGROUND UTILITY LINES, TANKS, ETC. WITHIN THE CONSTRUCTION AREA AND RELOCATE THEM AS DIRECTED BY THE CIVIL ENGINEER. 

### **CAST IN PLACE CONCRETE**

5. ALL CAST-IN-PLACE CONCRETE WORK INCLUDES REINFORCING STEEL AND RELATED WORK SHOWN INCLUDING FORMWORK, SETTING ANCHOR BOLTS, PLATES, FRAMES, DOWELS FOR MASONRY OR OTHER ITEMS EMBEDDED IN CONCRETE.

6. APPLICABLE STANDARDS

ACI NUMBER TITLE 117 STANDARD SPECIFICATIONS FOR TOLERANCES FOR

CONCRETE CONSTRUCTION 226 GROUND GRANULATED BLAST-FURNACE SLAG 301 STANDARD SPECIFICATIONS FOR STRUCTURAL CONCRETE FOR BUILDINGS

302 GUIDE FOR CONCRETE FLOOR AND SLAB CONSTRUCTION 304 GUIDE FOR MEASURING MIXING, TRANSPORTING AND PLACING CONCRETE 304.2R PLACING CONCRETE BY PUMPING METHODS.

305R HOT WEATHER CONCRETING 306R COLD WEATHER CONCRETING

308 STANDARD PRACTICE FOR CURING CONCRETE 309R GUIDE FOR CONSOLIDATION OF CONCRETE

315 MANUAL OF STANDARD PRACTICE FOR DETAILING CONCRETE STRUCTURES 318 BUILDING CODE REQUIREMENTS FOR REINFORCED CONCRETE 347 RECOMMENDED PRACTICE FOR CONCRETE FORMWORK

CRSI NUMBER TITLE RECOMMENDED PRACTICE FOR PLACING REINFORCING BARS

A) PORTLAND CEMENT — ASTM C 150, TYPE I

B) AGGREGATES - NORMAL WEIGHT CONCRETE, COARSE AND FINE, ASTM C33. STRUCTURAL LIGHT WEIGHT ASTM C330.

C) AIR-ENTRAINING - ASTM C260

D) WATER REDUCING - ASTM C494, TYPE A

E) WATER — FRESH, CLEAN AND POTABLE

F) NO ACCELERATORS, RETARDERS OR ADMIXTURES CONTAINING CHLORIDES WILL BE PERMITTED

G) FLY-ASH - ASTM C618, CLASS F, 20% MAXIMUM OF CEMENTITIOUS MATERIAL BY WEIGHT. DO NOT USE FOR EXPOSED SLABS OR ARCHITECTURAL CONCRETE.

H) SUPER PLASTICIZER - ASTM C494, TYPE F OR G, WHERE AUTHORIZED BY THE ENGINEER.

I) GROUND GRANULATED BLAST-FURNACE SLAG CEMENT - ASTM C989, 50% MAXIMUM BY WEIGHT.

J) MAXIMUM AGGREGATE SIZE - FOOTINGS = #57, OTHERS #67

4. REINFORCING MATERIALS

A) DEFORMED BARS - ASTM A615, GRADE 60

B) SMOOTH DOWELS — ASTM A615, PLAIN BARS, MINIMUM YIELD STRENGTH OF 60,000

C) CORROSION RESISTANT UNCOATED STEEL (MMFX-2) - ASTM A615, GRADE 75 AND ASTM A1035 LOW-CARBON (8% MINIMUM) CHROMIUM BY MMFX OR EQUAL.

D) WELDED WIRE FABRIC - ASTM A185, PLAIN WIRE FABRIC IN FLAT SHEETS ONLY.

E) ACCESSORIES TO CONFORM TO ACI 315.

F) WHERE CONCRETE SURFACES ARE EXPOSED, MAKE THOSE PORTIONS OF ALL ACCESSORIES IN CONTACT WITH THE CONCRETE SURFACE OR WITHIN 1/2 INCH THEREOF, OF PLASTIC OR STAINLESS STEEL.

5. PROVIDE THE FOLLOWING MINIMUM CONCRETE STRENGTHS AT 28 DAYS:

A) FOOTINGS, SLAB-ON-GRADE-----3000 PSI B) REGULAR/LIGHTWEIGHT FILL ON METAL DECK-----3000 PSI

C) MASONRY WALL BEAMS, TIE COLUMNS-----3000 PSI D) FORMED COLUMNS, WALLS, BEAMS & SLABS-----4000 PSI

6. CONCRETE MUST BE BATCHED, MIXED AND TRANSPORTED IN ACCORDANCE WITH THE SPECIFICATIONS FOR READY-MIXED CONCRETE ASTM C94.

7. REQUIRED SLUMP = 4 PLUS OR MINUS ONE INCH.

8. CONCRETE MUST BE PLACED WITHIN 90 MINUTES OF BATCH TIME. WHEN AIR TEMPERATURE IS BETWEEN 85 AND 90 DEGREES F, REDUCE MIXING AND DELIVERY TIME TO 75 MINUTES. WHEN AIR TEMPERATURE IS HIGHER THAN 90 DEGREES F, REDUCE MIXING AND DELIVERY TIME TO 60 MINUTES.

9. DO NOT ADD WATER AT THE JOB SITE WITHOUT APPROVAL OF THE PROJECT SUPERINTENDENT. DO NOT EXCEED THE SLUMP LIMITATION. USE ONLY COLD WATER FROM THE TRUCK TANK. ANY ADDED WATER MUST BE INDICATED ON THE DELIVERY TICKET PLUS THE NAME OF THE PERSON AUTHORIZING. TEST CYLINDERS SHALL BE TAKEN AFTER THE ADDITION OF WATER.

10. LAP SPLICE REINFORCING 48 BAR DIAMETERS MINIMUM UNLESS OTHERWISE SHOWN OR NOTED.

11. PROVIDE CORNER BARS AT ALL WALL FOOTING, WALL AND BEAM CORNERS. SIZE AND NUMBER TO MATCH HORIZONTAL BARS.

12. PROVIDE FOUNDATION DOWELS TO MATCH SIZE AND NUMBER OF VERTICAL BARS. EMBED DOWELS TO:

A) 3" ABOVE BOTTOM OF FOOTINGS

13. REINFORCEMENT SHALL BE FASTENED AND SECURED TOGETHER TO PREVENT DISPLACEMENT BY CONSTRUCTION LOADS OR THE PLACING OF CONCRETE.

14. REINFORCING BAR COVER

NOT INCLUDED.

A) FOOTINGS 2" (TOP), 3" (SIDES AND BOTTOM)

C) SLABS 3/4" (INTERIOR), 1-1/2" (EXTERIOR)

B) COLUMNS AND BEAMS 1-1/2"

15. WHERE BAR LENGTHS ARE GIVEN ON THE DRAWINGS, LENGTH OF HOOK, IF REQUIRED, IS

16. SELECT PROPORTIONS IN ACCORDANCE WITH ACI 301 TO PROVIDE CONCRETE CAPABLE OF BEING PLACED WITHOUT EXCESSIVE SEGREGATION AND WITH ACCEPTABLE FINISHING PROPERTIES, DURABILITY, SURFACE HARDENERS, APPEARANCE, AND STRENGTH REQUIREMENTS REQUIRED BY THESE SPECIFICATIONS.

17. CHAIR WELDED WIRE FABRIC REINFORCING AT 3'-0" ON CENTER MAXIMUM IN EACH DIRECTION.

18. MAXIMUM WATER TO CEMENT RATIO WHEN NO BACK-UP DATA IS AVAILABLE:

A) 4000 PSI, 28-DAY COMPRESSIVE STRENGTH; W/C RATIO, 0.44 MAXIMUM (NON-AIR-ENTRAINED), 0.36 MAXIMUM (AIR-ENTRAINED).

B) 3000 PSI, 28-DAY COMPRESSIVE STRENGTH; W/C RATIO, 0.58 MAXIMUM (NON-AIR-ENTRAINED). 0.47 MAXIMUM (AIR-ENTRAINED).

19. DATA TO BE SUBMITTED:

A) INTENDED USAGE AND LOCATION FOR EACH TYPE

MIX DESIGN FOR EACH TYPE

C) CEMENT CONTENT IN POUNDS-PER-CUBIC YARD

D) COARSE AND FINE AGGREGATE IN POUNDS/CUBIC YARD

E) WATER CEMENT RATIO BY WEIGHT CEMENT TYPE AND MANUFACTURER

SLUMP RANGE

AIR CONTENT

ADMIXTURE TYPE AND MANUFACTURER

PERCENT ADMIXTURE BY WEIGHT

STRENGTH TEST DATA REQUIRED TO ESTABLISH MIX DESIGN.

COMPLETE DETAIL AND PLACING SHOP DRAWINGS FOR ALL REINFORCING STEEL INCLUDING ACCESSORIES THAT HAVE BEEN REVIEWED AND STAMPED BY THE GENERAL CONTRACTOR. INCLUDE ALL REQUIRED DIMENSIONS AND ELEVATIONS (IE. TOP OF CONCRETE)

20. THE GENERAL CONTRACTOR IS RESPONSIBLE FOR PROVIDING THE CONSTRUCTION OF FORMWORK, SHORING AND RE-SHORING IN ACCORDANCE WITH ACI 347.

21. CONSTRUCTION JOINTS NOT SHOWN ON THE DRAWINGS MUST BE MADE AND LOCATED TO LEAST IMPAIR THE STRENGTH OF THE STRUCTURE. A) NO HORIZONTAL CONSTRUCTION JOINTS WILL BE PERMITTED IN BEAMS, GIRDERS AND

SLABS. B) LOCATION OF ANY CONSTRUCTION JOINT NOT SHOWN IS SUBJECT TO REVIEW AND ACCEPTANCE BY ENGINEER.

22. INTERNAL VIBRATION, PROPERLY APPLIED IS THE REQUIRED METHOD OF CONSOLIDATING PLASTIC CONCRETE.

23. PROVIDE 3/4" CHAMFER ON ALL EXPOSED CORNERS OF COLUMNS, BEAMS AND WALLS UNLESS OTHERWISE NOTED ON ARCHITECTURAL DRAWINGS.

24. CONTRACTOR SHALL VERIFY LOCATIONS OF ALL OPENINGS, SLEEVES, AND SLAB RECESSES AS REQUIRED BY OTHER TRADES BEFORE CONCRETE IS PLACED. NO SLEEVE, OPENINGS, OR INSERT MAY BE PLACED IN BEAMS, JOISTS, OR COLUMN UNLESS APPROVED BY THE ENGINEER.

25. CONTRACTOR SHALL VERIFY EMBEDDED ITEMS INCLUDING, BUT NOT LIMITED TO, ANCHOR BOLTS, BOLT CLUSTERS, WELD PLATES, ETC., BEFORE PLACING CONCRETE. NOTIFY ENGINEER OF ANY CONFLICTS WITH REBAR.

26. SEE ARCHITECTURAL DRAWINGS FOR REQUIRED CONCRETE FINISHES.

27. SLOPE WALKWAYS TO DRAIN AWAY FROM THE BUILDING.

28. BUILDING FLOOR AND SITE SLABS-ON-GRADE SHALL BE 4" MINIMUM THICKNESS, UNLESS NOTED OTHERWISE.

A) REINFORCED WITH 6X6 - W1.4 X W1.4 W.W.F. B) PLACED ON 10 MIL POLYETHYLENE VAPOR RETARDER. LAP 6" AND TAPE ALL JOINTS.

C) SAW-CUT CONTROL JOINTS @ LESS THAN OR EQUAL TO 15'-0" EACH WAY.

D) PROVIDE HOUSEKEEPING PADS AS REQUIRED. E) SEE DRAWINGS FOR ANY ADDITIONAL CONDITIONS.

29. TESTING

A) A QUALIFIED TESTING LAB SHALL BE RETAINED TO PERFORM QUALITY CONTROL WORK AND ON-SITE TESTING.

B) SLUMP TEST - ASTM 143 C) MOLD AND CURE TEST CYLINDERS (ASTM C-31) AND TEST CYLINDERS FOR STRENGTH (ASTM C39). TAKE ONE TEST - THREE CYLINDERS FOR EACH DAYS POUR OF 100 CUBIC YARDS, OR FRACTION THEREOF. TEST ONE CYLINDER AT 7 DAYS, ONE AT 28 DAYS AND ONE HOLD. TEST CYLINDER SAMPLES SHALL BE TAKEN AT THE POINT OF DISCHARGE WHEN USING A PUMP.

D) ONE COPY OF ALL TEST REPORTS SHALL BE SENT DIRECTLY TO THE OWNER, ENGINEER, ARCHITECT AND GENERAL CONTRACTOR.

30. CONTRACTOR SHALL PROVIDE FLATNESS AND LEVELNESS IN CONCRETE SLABS PER ACI 302.1R, FIG. 8.7 MINIMUM REQUIRED "F" NUMBERS FOR TYPE OF SLAB USE. REFER TO ACI 117 FOR FLOOR TOLERANCES.

31. REPAIR ANY CRACKS OR DEFECTIVE AREAS THAT WILL RESTORE THE AFFECTED SURFACE OR AREAS TO THEIR FULL DESIGN STRENGTH AND APPEARANCE. CONTACT THE STRUCTURAL ENGINEER FOR ADVICE AND EVALUATION.

32. ACCEPTANCE OF THE STRUCTURE WILL BE MADE IN CONFORMANCE WITH ACI 301.

33. ALL CAST-IN-PLACE CONCRETE MUST BE MAINTAINED WITH MINIMAL MOISTURE LOSS AT A RELATIVELY CONSTANT TEMPERATURE FOR A MINIMUM OF 7 DAYS FOLLOWING THE PLACING OF THE CONCRETE BY THE USE OF A WATER SPRAY, WATER SATURATED FABRIC, MOISTURE RETAINING MEMBRANE OR LIQUID CURING COMPOUND.

34. CURE SLABS-ON-GRADE FOR THE FIRST 72 HOURS BY THE USE OF:

A) FOG SPRAYING

B) PONDING

C) SPRINKLING

D) CONTINUOUSLY WET ABSORPTIVE MATS OR FABRIC E) CONTINUE CURING BY USE OF MOISTURE RETAINING COVER UNTIL CONCRETE HAS

OBTAINED ITS SPECIFIED 28 DAY COMPRESSIVE STRENGTH.

F) OR LIQUID CURING COMPOUND AFTER FINISHING PROCESS IS COMPLETED. G) CONCRETE WET CURE TIME TO BE 7 DAYS MINIMUM AT 50 DEGREES MINIMUM TEMPERATURE.

35. SUBMIT MATERIALS AND METHOD OF CURING FOR REVIEW.

36. DO NOT USE MOISTURE RETAINING CURING COMPOUNDS FOR CURING SURFACES TO RECEIVE CARPET, FLEXIBLE FLOORING, CERAMIC TILED FLOORS OR OTHER SPECIFIED FLOOR SYSTEMS, UNLESS IT HAS BEEN DEMONSTRATED THAT SUCH COMPOUNDS WILL NOT PREVENT BOND.

37. DO NOT PERMIT CONCRETE NOT FULLY CURED TO BE EXPOSED TO EXCESSIVE TEMPERATURE CHANGES OR HIGH WINDS.

38. POUR ALL GROUND SLABS ON 10 MIL MINIMUM VAPOR RETARDER IN COMPLIANCE WITH ASTM E1745, LAPPED 6" MINIMUM AND FULLY TAPED. 39. EQUIPMENT MADE OF ALUMINUM OR ALUMINUM ALLOYS, SHALL NOT BE USED FOR PUMP

LINES, TREMIES, OR CHUTES OTHER THAN SHORT CHUTES SUCH AS THOSE USED TO

CONVEY CONCRETE FROM A TRUCK MIXER. 40. THE CODE PROHIBITS THE USE OF ALUMINUM (CONDUIT, PIPES, ETC.) IN STRUCTURAL

CONCRETE UNLESS IT IS EFFECTIVELY COATED OR COVERED.

SHEET INDEX

SØ.1 STRUCTURAL SPECIFICATIONS

SØ.2 STRUCTURAL SPECIFICATIONS AND WIND CHARTS

SI.Ø FOUNDATION PLAN

63.0 UPPER ROOF FRAMING PLAN

S2.0 MEZZANINE AND LOW ROOF PLAN

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3/05/2015 SPRAB

6/29/2015

PERMIT

CONSTRUCTION

PROJECT TITLE

Art Warehouse Renovation

313 NE 3rd Street Delray Bch., Florida

/1\ REVISION Ø8-21-15

33444

REVISIONS

THESE DRAWINGS ARE PREPARED PER ESTABLISHED INDUSTRY STANDARDS AND REPRESENT THE ARCHITECT AND ENGINEERS DESIGN CONCEPT THEY ARE NOT INTENDED TO PROVIDE EVERY DETAIL OR CONDITION REQUIRED TO CONSTRUCT THE PROJECT

THE CONTRACTOR THROUGH SUBMITTALS

AND OTHER COORDINATION EFFORTS IS

FULLY RESPONSIBLE FOR PROVIDING A

COMPLETE AND OPERATIONAL PROJECT

WHETHER INDICATED ON THE PLANS OR NOT.

FILE NUMBER

DRAWING TITLE **STRUCTURAL SPECIFICATIONS** 

7 O DATE DRAWN BY

6/29/2015 JOB NUMBER 100701

DRAWING NUMBER

2. PLANT RECORDS OF PRODUCTION AND QUALITY CONTROL SHALL BE KEPT IN ACCORDANCE WITH PCI RECOMMENDATIONS AND MADE AVAILABLE UPON REQUEST FOR THE ARCHITECT/ENGINEER.

#### 3. CODES AND STANDARDS:

- A) AMERICAN SOCIETY FOR TESTING AND MATERIALS(ASTM)
  - 1) C33 SPECIFICATION FOR CONCRETE AGGREGATES
  - 2) C150 SPECIFICATION FOR PORTLAND CEMENT
- B) PRECAST/PRE-STRESSED CONCRETE INSTITUTE (PCI) STANDARDS: MANUAL FOR QUALITY CONTROL FOR PRECAST AND PRE-STRESSED CONCRETE MNL-116.
- C) AMERICAN CONCRETE INSTITUTE: BUILDING CODE REQUIREMENTS FOR STRUCTURAL CONCRETE (ACI 318)
- D) AMERICAN CONCRETE INSTITUTE: BUILDING CODE REQUIREMENTS FOR MASONRY STRUCTURES (ACI 530)

#### 4. CONCRETE MATERIALS:

- A) PORTLAND CEMENT: ASTM C150 TYPE I OR III, GRAY COLOR
- AGGREGATES: ASTM C33
- C) WATER: POTABLE
- D) ADMIXTURES: SHALL NOT CONTAIN CALCIUM CHLORIDE OR CHLORIDE IONS

#### 5. REINFORCING

- A) DEFORMED REINFORCEMENT: ASTM A615 GRADE 40 OR 60.
- B) PRE-STRESSING STRAND: ASTM A416 270 KSI LL.
- 6. U-LINTEL UNITS 14 FEET IN OVERALL LENGTH AND SHORTER SHALL BE MADE OF CONCRETE WITH A MINIMUM STRENGTH OF 3500 PSI AT 28 DAYS.
- 7. SILL UNITS SHALL BE MADE OF CONCRETE WITH A MINIMUM STRENGTH OF 3000 PSI AT 28 DAYS. SEE ARCHITECTURAL DETAILS.
- 8. UNITS SHALL BE SAND BLOCK FINISH EXCEPT PRE-STRESSED, 6" WIDE, AND 12" WIDE U-LINTELS SHALL BE SMOOTH FORM FINISHED.
- 9. PRECAST CONCRETE U-LINTELS SHALL BE DESIGNED BY A LICENSED DELEGATED ENGINEER.

#### **MASONRY**

- 1. HOLLOW LOAD BEARING UNITS SHALL CONFORM TO ASTM C90, NORMAL WEIGHT, TYPE II. MINIMUM NET COMPRESSIVE UNIT STRENGTH = 2000 PSI. (NET AREA COMPRESSIVE MASONRY STRENGTH F'M = 1500 PSI).
- 2. MORTAR SHALL BE TYPE S AND CONFORM TO ASTM C270 (PROPORTION OR PROPERTY SPECIFICATION) WITH A MINIMUM AVERAGE COMPRESSIVE STRENGTH AT 28 DAYS OF 1800
- 3. COARSE GROUT SHALL CONFORM TO ASTM C476:
- A) 2500 PSI AT 28 DAYS.
- B) 1/4" MAXIMUM AGGREGATE.
- C) 8" 11" SLUMP.

#### 4. CODES AND STANDARDS:

- A) SPECIFICATIONS FOR MASONRY STRUCTURES ACI 530.1/ASCE 6/ TMS 602 IS INCLUDED BY REFERENCE IN ITS ENTIRETY.
- B) BUILDING CODE REQUIREMENTS FOR MASONRY STRUCTURES ACI 530/ ASCE 5/TMS 402.
- 5. A REINFORCED CONCRETE TIE BEAM SHALL BE PROVIDED IN ALL WALLS SHOWN ON THE STRUCTURAL DRAWINGS AT EACH FLOOR, THE ROOF, AND AT TOP OF ANY PARAPET WALL. USE GALVANIZED MESH-TYPE CELL CAPS. PROVIDE CORNER BARS AT ALL BEAM CORNERS TO MATCH HORIZONTAL BARS.
- 6. UNLESS NOTED OTHERWISE, TIE BEAMS SHALL BE AS FOLLOWS:
- A) FLOOR LEVELS: 8 X 16 4000 PSI WITH (2) #5 TOP & BOTTOM, #3 STIRRUPS 24" ON CENTER.
- 7. VERTICAL BARS SHALL BE HELD IN POSITION AT THE TOP AND BOTTOM OF BAR AND AT 8'\_0" O.C. MAXIMUM WITH A MINIMUM CLEARANCE OF 1/2" FROM MASONRY. THE CLEAR DISTANCE BETWEEN BARS SHALL NOT EXCEED ONE BAR DIAMETER, OR MORE THAN 1". CENTER BARS IN WALLS U.N.O.
- 8. VERTICAL REINFORCING SHALL BE AS SHOWN ON THE DRAWINGS. FILLCELLS WITH COARSE GROUT AS SPECIFIED. PROVIDE ACI 90 DEGREE STANDARD HOOKS INTO FOOTING AND ROOF TIE BEAM. LAP SPLICE VERTICAL REINFORCEMENT ABOVE FOOTING AND ABOVE EACH FLOOR LEVEL UNLESS NOTED OTHERWISE. MAINTAIN VERTICAL REINFORCING SHOWN ON PLANS ABOVE AND BELOW MASONRY OPENINGS. CONTINUE FOUNDATION DOWELS BELOW ALL MASONRY OPENINGS.
- 9. REINFORCED FILL CELLS ARE TO BE CLEAN AND FREE OF ANY FOREIGN MATERIAL OR DEBRIS. REMOVE ANY INSULATING MATERIAL FROM CELLS, INCLUDING POLYSTYRENE INSULATING INSERTS, PRIOR TO GROUT POUR.
- 10. REINFORCING BARS SHALL BE STRAIGHT EXCEPT FOR BENDS AROUND CORNERS AND WHERE BENDS OR HOOKS ARE DETAILED ON THE PLANS.
- 11. REINFORCING BARS SHALL BE LAPPED PER MASONRY LAP SCHEDULE MINIMUM (UNLESS OTHERWISE NOTED) WHERE SPLICED AND SHALL BE WIRED TOGETHER.
- 12. WHEN A FOUNDATION DOWEL DOES NOT LINE UP WITH A VERTICAL CORE, IT SHALL NOT BE SLOPED MORE THAN ONE HORIZONTAL IN SIX VERTICALS. DOWELS SHALL BE GROUTED INTO A CORE IN VERTICAL ALIGNMENT, EVEN THOUGH IT IS IN AN ADJACENT CELL TO THE VERTICAL WALL REINFORCEMENT.
- 13. PROVIDE HORIZONTAL WALL REINFORCING (9 GA.) HOT DIPPED GALVANIZED LADDER TYPE DUR-O-WALL (OR EQUIVALENT) AT 16" O.C. JOINT REINFORCING SHALL CONFORM TO ASTM A-951.

- 14. PROVIDE HORIZONTAL JOINT REINFORCEMENT AT DOORS AND WINDOWS FOR FIRST AND 14. FASTENERS AND MATERIALS USED FOR WELDING OR OTHERWISE SECURING COMPONENTS ONE SECOND BLOCK COURSE ABOVE AND BELOW APERTURES. RUN REINFORCING CONTINUOUS OR EXTEND TWO FEET FROM APERTURE EDGE.
- 15. WIRE REINFORCEMENT SHALL BE LAPPED AT LEAST 6" AT SPLICES AND SHALL CONTAIN AT LEAST ONE CROSS WIRE OF EACH PIECE OF REINFORCEMENT IN THE LAPPED DISTANCE.
- 16. CLEANOUTS SHALL BE PROVIDED IN THE BOTTOM COURSE OF MASONRY IN EACH GROUT POUR WHEN THE POUR HEIGHT EXCEEDS 5'. CLEANOUTS TO BE SAW-CUT 4" X 4".
- 17. GROUT POUR HEIGHT SHALL NOT EXCEED 14'. PLACE GROUT IN 7' MAX. LIFTS HEIGHTS.
- 18. CONSOLIDATE GROUT POURS AT THE TIME OF PLACEMENT BY MECHANICAL MEANS AND RECONSOLIDATE AFTER INITIAL WATER LOSS AND SETTLEMENT.
- 19. ALL MASONRY FOUNDATION STEMWALLS AND RETAINING WALLS SHALL BE FULLY GROUTED.
- 20. STORE BLOCKS ON PALLETS AND COVER WITH PLASTIC SHEETING.
- 21. PLACE MASONRY IN RUNNING BOND WITH 3/8" MORTAR JOINTS. PROVIDE COMPLETE COVERAGE FACE SHELL MORTAR BEDDING, HORIZONTAL AND VERTICAL. FULLY MORTAR WEBS IN ALL COURSES OF PIERS, COLUMNS, AND PILASTERS AND ADJACENT TO GROUTED CELLS.
- 22. PROVIDE 8" DEEP PRECAST REINFORCED CONCRETE LINTELS OVER ALL MASONRY OPENINGS TO MATCH MASONRY WIDTH.
- 23. TOPS OF PARTIALLY CONSTRUCTED WALLS SHALL BE COVERED WITH VISQUEEN WHENEVER RAIN OCCURS AND AT THE END OF THE WORK DAY.

#### STRUCTURAL STEEL

- 1. STRUCTURAL STEEL SHALL CONFORM TO THE AISC "SPECIFICATION FOR BUILDINGS", LATEST EDITION.
- 2. WELDED CONNECTIONS SHALL CONFORM TO THE LATEST REVISED CODE OF THE AMERICAN WELDING SOCIETY, AWS D1.1. ALL WELDING SHALL BE PERFORMED USING E70XX, LOW HYDROGEN ELECTRODES. ELECTRODES ARE TO BE PROTECTED FROM MOISTURE.
- 3. CONNECTIONS TO BE DOUBLE ANGLE FRAMED BEAM CONNECTION PER AISC UNLESS NOTED OTHERWISE. ALL BOLTS TO BE 3/4" DIAMETER UNLESS NOTED OTHERWISE. SHOP CONNECTIONS MAY BE WELDED OR BOLTED. WELDS ARE TO BE EQUAL IN STRENGTH TO BOLTS. ALL FIELD CONNECTIONS ARE TO BE BOLTED WITH ASTM A325N OR A490 BOLTS (BEARING TYPE BOLTS WITH THREADS IN THE SHEAR PLANE) INCLUDING SUITABLE NUTS AND PLAIN HARDENED WASHERS. ALL BOLTS SHALL BE TIGHTENED SNUG TIGHT UNLESS OTHERWISE NOTED. DESIGN CONNECTIONS FOR THE LARGER OF EITHER THE SHEAR SHOWN ON THE DRAWINGS, (INDICATED AS "V = K" AT ENDS OF MEMBER) OR 55% OF THE MAXIMUM LOAD(IN KIPS) LISTED IN THE TABLES FOR "MINIMUM TOTAL FACTORED UNIFORM LOADS IN KIPS FOR BRACED, SIMPLE SPAN BEAMS BENT ABOUT THE STRONG AXIS" OF THE LATEST EDITION OF THE AISC "MANUAL OF STEEL CONSTRUCTION".
- 4. SIZE AND USE OF HOLES: SEE AISC TABLE J3.3.
  - A) LARGER HOLES ARE PERMITTED IN STANDARD COLUMN BASE PLATES. MAXIMUM HOLE DIAMETER = BOLT DIAMETER + 3/8". HARDENED WASHERS, TO COVER THE LARGER HOLE, SHALL BE PROVIDED.
- B) LARGER HOLES ARE NOT PERMITTED IN WIND FRAME COLUMN BASE PLATES. MAXIMUM HOLE DIAMETER = BOLT DIAMETER + 1/16".
- C) SLOTTED HOLES: A PLATE WASHERS OR A CONTINUOUS BAR WITHSTANDARD HOLES, HAVING A SIZE SUFFICIENT TO COMPLETELY COVER THE SLOT AFTER INSTALLATION, AND A MIN. OF 5/16" THICK SHALL BE PROVIDED. TACK WELD NUT TO BOLT AFTER
- 5. STEEL BEAMS SHALL BE FABRICATED WITH THE NATURAL CAMBER (WITHIN THE MILL TOLERANCE) LOCATED ABOVE THE HORIZONTAL CENTERLINE BETWEEN THE END CONNECTIONS.
- 6. VERIFY THE EXACT SIZE AND LOCATION OF ALL FLOOR AND ROOF OPENINGS FOR MECHANICAL EQUIPMENT WITH THE MECHANICAL CONTRACTOR PRIOR TO FABRICATION OF MATERIALS.
- 7. SHOP PRIME STEEL SURFACES EXCEPT THE FOLLOWING:
- A) SURFACES EMBEDDED IN CONCRETE OR MORTAR. EXTEND PRIMING OF PARTIALLY EMBEDDED MEMBERS TO A DEPTH OF 2 INCHES.
- B) SURFACES TO BE FIELD WELDED.
- C) SURFACES TO BE HIGH-STRENGTH BOLTED WITH SLIP-CRITICAL CONNECTIONS.
- D) SURFACES TO RECEIVE SPRAYED FIRE-RESISTIVE MATERIALS.
- E) GALVANIZED SURFACES.
- 8. SURFACE PREPARATION: CLEAN SURFACES TO BE PAINTED. REMOVE LOOSE RUST AND MILL SCALE AND SPATTER, SLAG, OR FLUX DEPOSITS. PREPARE SURFACES ACCORDING TO THE FOLLOWING SPECIFICATIONS AND STANDARDS.
- 9. PRIMING: IMMEDIATELY AFTER SURFACE PREPARATION, APPLY PRIMER ACCORDING TO MANUFACTURER'S WRITTEN INSTRUCTIONS AND AT RATE RECOMMENDED BY SSPC TO PROVIDE A DRY FILM THICKNESS OF NOT LESS THAN 1.5 MILS. USE PRIMING METHODS THAT RESULT IN FULL COVERAGE OF JOINTS, CORNERS, EDGES, AND EXPOSED SURFACES. A) STRIPE PAINT CORNERS, CREVICES, BOLTS, WELDS, AND SHARP EDGES.
- B) APPLY TWO COATS OF SHOP PAINT TO INACCESSIBLE SURFACES AFTER ASSEMBLY OR ERECTION. CHANGE COLOR OF SECOND COAT TO DISTINGUISH IT FROM FIRST.
- 10. PRIME AND PAINT ALL FIELD WELDS AFTER INSPECTION.
- 11. A QUALIFIED TESTING LABORATORY SHALL BE RETAINED TO PERFORM THE FOLLOWING TESTS. A) VISUALLY INSPECT ALL STEEL MEMBERS AND CONNECTIONS.
- 12. ONE COPY OF ALL TEST REPORTS SHALL BE SENT DIRECTLY TO OWNER, ARCHITECT, STRUCTURAL ENGINEER, AND GENERAL CONTRACTOR.
- 13. STEEL SHALL CONFORM TO: WIDE FLANGE (WF)(WT)-----ASTM A992 (50 KSI) SHAPES (L, C, MC)-----ASTM A36
- HOLLOW STRUCTURAL SECTIONS (HSS)--- ASTM A500 GRADE B (RECTANGULAR 46 KSI; ROUND 42 KSI)
- ANCHOR BOLTS----- ASTM A307 FRAMING BOLTS----- ASTM A325N OR A490N WELDING ELECTRODES----E70XX

- TO ANOTHER SHALL BE OF DOMESTIC (USA MADE) MANUFACTURE. SIMILARLY, ALL MATERIALS USED IN THE MANUFACTURING PROCESS SHALL BE FROM A DOMESTIC SOURCE.
- 15. OPENINGS THROUGH STEEL BEAMS SHALL BE PROVIDED AS DETAILED ON THE DRAWINGS. ALL SUCH OPENINGS SHALL BE MACHINE CUT IN THE SHOP. ALL RECTANGULAR OPENINGS SHALL HAVE A CORNER RADIUS OF 2 TIMES THE WEB THICKNESS, 1/2" MINIMUM.
- 16. SHOP AND FIELD WELDS SHALL BE DONE BY A.W.S. CERTIFIED WELDERS. PROVIDE CURRENT CERTIFICATES UPON REQUEST.
- 17. NO SPLICES SHALL BE PERMITTED IN ANY STRUCTURAL STEEL MEMBER UNLESS SHOWN ON APPROVED SHOP DRAWINGS.
- 18. STEEL STAIRS AND/OR LADDERS SHALL BE DESIGNED FOR 100 PSF LIVE LOAD BY A LICENSED DELEGATED ENGINEER, WHO SHALL SUBMIT SIGNED AND SEALED SHOP DRAWINGS SHOP DRAWINGS SHALL SPECIFY ALL DESIGN LOADS.
- 19. SUBMITTALS: CONTRACTOR SHALL SUBMIT DETAILED SHOP DRAWINGS SHOWING ALL STRUCTURAL STEEL LAYOUTS AND DETAILS, SIZES OF MEMBERS, TYPE OF STEEL CONNECTION DETAILS, WELDS, BOLTS, ETC., AS REQUIRED TO FABRICATE AND ERECT ALL STRUCTURAL STEEL FRAMING. ALL CONNECTIONS NOT SHOWN ON THE STRUCTURAL DRAWINGS SHALL BE DESIGNED BY THE DETAILER AND SUBMITTED ON SHOP DRAWINGS, SIGNED AND SEALED BY A REGISTERED FLORIDA DELEGATED ENGINEER.
- NOT SHOWN TO HAVE A STRUCTURAL BEAM. MINIMUM END BEARING = 8". LINTEL WIDTH 20. NON-SHRINK GROUT SHALL BE: NONMETALLIC SHRINKAGE-RESISTANT GROUT, PREMIXED, NON-CORROSIVE, NON-STAINING PRODUCT CONTAINING SELECTED SILICA SANDS, PORTLAND CEMENT, SHRINKAGE COMPENSATING AGENTS. PLASTICIZING AND WATER-REDUCING AGENTS. COMPLYING WITH CRD-C621, CORPS OF ENGINEERS.
  - 21. IF NOT SPECIFIED ON THE DRAWINGS, THE THROAT SIZE OF ANY FILLET WELD SHALL BE EQUAL TO 1/16" LESS THAN THE THINNEST CONNECTION COMPONENT.
  - 22. NO FIELD WELDING OF GALVANIZED MEMBERS IS PERMITTED.
  - 23. MINIMUM EMBEDMENT DEPTH OF ANCHOR BOLTS: A) BEAMS, COLUMNS, WALLS = 6"
  - B) FOOTINGS = 3" FROM BOTTOM

- A) BEFORE ERECTION, THE CONTRACTOR IS TO REMOVE ALL MUD, DIRT OR OTHER FOREIGN MATTER, WHICH ACCUMULATES DURING HANDLING AND STORAGE.
- B) DRIFTING TO ENLARGE UNFAIR HOLES WILL NOT BE PERMITTED. DRILL SUCH HOLES TO ACCOMMODATE THE NEXT LARGER SIZE FASTENER, WHERE POSSIBLE.
- C) AFTER ERECTION, CLEAN FIELD WELDS, BOLTED CONNECTIONS, AND ABRADED AREAS WHERE SHOP COAT HAS BEEN DAMAGED. SPOT AND PRIME AREAS USING SAME MATERIAL AS SHOP COAT.
- D) SET ALL MEMBERS SO THAT, IN THEIR FINAL LOCATION, LEVEL, PLUMBNESS AND ALIGNMENT ARE WITHIN THE TOLERANCES PRESCRIBED BY AISC CODE.
- E) DOUBLE CONNECTIONS THROUGH COLUMN WEBS OR AT BEAMS THAT FRAME OVER THE TOPS OF COLUMNS MUST BE DESIGNED TO HAVE AT LEAST ONE INSTALLED BOLT REMAIN IN PLACE TO SUPPORT THE FIRST BEAM WHILE THE SECOND BEAM IS BEING ERECTED. ALTERNATIVELY, THE FABRICATOR MUST SUPPLY A SEAT OR EQUIVALENT DEVICE WITH A MEANS OF POSITIVE ATTACHMENT TO SUPPORT THE FIRST BEAM WHILE THE SECOND BEAM IS BEING ERECTED.

#### OPEN WEB STEEL JOISTS AND JOIST GIRDERS (NOTED "JOISTS" HEREIN

- 1. STEEL JOIST MANUFACTURER SHALL BE A MEMBER OF THE STEEL JOIST INSTITUTE.
- 2. STEEL JOISTS SHALL CONFORM TO THE REQUIREMENTS OF THE LATEST EDITION OF THE AISC STANDARD SPECIFICATIONS FOR OPEN WEB STEEL JOISTS K, LH, OR DLH SERIES (SEE PLAN), AND OSHA STEEL ERECTION STANDARD.
- 3. JOISTS AND ALL ACCESSORIES SHALL BE DESIGNED BY A LICENSED DELEGATED ENGINEER WHO SHALL PREPARE DESIGN CALCULATIONS AND SUPERVISE THE PREPARATION OF SHOP
- 4. VERIFY THE EXACT LOCATION AND WEIGHT OF ALL MECHANICAL EQUIPMENT WITH THE MECHANICAL CONTRACTOR PRIOR TO FABRICATION OF JOISTS.
- 5. ALL HANGERS TO SUPPORT MECHANICAL EQUIPMENT, ETC., TO BE SUPPORTED BY THE TOP OR BOTTOM CHORD OF JOISTS SHALL BE LOCATED AT THE PANEL POINT OF THE JOIST. IF HANGERS MUST BE LOCATED IN BETWEEN PANEL POINTS, PROVIDE JOIST STIFFENER AS INDICATED IN DETAILS. ALL HANGERS TO BE LOCATED AT THE CENTERLINE OF THE BOTTOM CHORD MEMBER.
- 6. NO MODIFICATION THAT AFFECTS THE STRENGTH OF A STEEL JOIST SHALL BE MADE WITHOUT THE APPROVAL OF THE DELEGATED ENGINEER.
- DELEGATED ENGINEER SHALL DESIGN JOISTS AND BRIDGING FOR GRAVITY LOADS AND WIND LOAD UPLIFT PRESSURES INDICATED ON THE DRAWINGS.
- 8. JOIST BRIDGING SHALL BE FURNISHED AND INSTALLED TO MEET THE DESIGN AND SPACING REQUIREMENTS OF THE SJI STANDARD SPECIFICATIONS. ALL BRIDGING AND BRIDGING ANCHORS SHALL BE COMPLETELY INSTALLED BEFORE CONSTRUCTION LOADS ARE PLACED ON THE JOISTS.
- 9. WHERE COLUMNS ARE NOT FRAMED IN AT LEAST TWO DIRECTIONS WITH SOLID WEB BEAMS, A STEEL JOIST SHALL BE FIELD-BOLTED AT THE COLUMN TO PROVIDE LATERAL STABILITY DURING ERECTION.
- 10. A 6"X6" MINIMUM VERTICAL STABILIZER PLATE TO RECEIVE THE JOIST BOTTOM CHORD MUST BE PROVIDED AT COLUMNS. THE STABILIZER PLATE MUST HAVE A 13/16 INCH HOLE FOR THE ATTACHMENT OF GUYING OR PLUMBING CABLES.
- 11. JOISTS AND ACCESSORIES SHALL HAVE ONE SHOP COAT OF PAINT MEETING THE MINIMUM PERFORMANCE REQUIREMENTS OF THE LATEST SJI SPECIFICATIONS. SEE ARCHITECT FOR PREFERRED COLOR.
- 12. SEE PLAN FOR ANY CONCENTRATED LOADS OR UNUSUAL CONDITIONS. ALL JOISTS SUBJECT TO SPECIAL LOADS OR CONDITIONS SHALL BE CONSIDERED "SPECIAL JOISTS", (SP).
- 13. CONTRACTOR SHALL SUBMIT DETAILED SHOP DRAWINGS SHOWING JOISTS. BRIDGING. AND ALL CONNECTIONS. SHOP DRAWINGS SHALL BE SIGNED AND SEALED BY THE DELEGATED ENGINEER.
- 14. THE DELEGATED ENGINEER MUST BE PROVIDED WITH A COPY OF THESE DRAWINGS AND SPECIFICATIONS.

- 16. PROVIDE ONE ROW UPLIFT BRIDGING AT THE FIRST PANEL POINT FROM EACH SUPPORT.
- 17. DURING THE CONSTRUCTION PERIOD, THE CONTRACTOR SHALL PROVIDE MEANS FOR ADEQUATE DISTRIBUTION OF CONCENTRATED LOADS SO THAT THE CARRYING CAPACITY OF ANY JOIST IS NOT EXCEEDED.
- 18. ONE END OF ALL JOISTS SHALL BE ATTACHED TO ITS SUPPORT IN ACCORDANCE WITH SJI SPECIFICATIONS BEFORE ALLOWING THE WEIGHT OF AN ERECTOR ON THE JOISTS.
- 19. SEE STANDARD JOIST SPECIFICATIONS FOR CAMBER REQUIREMENTS.
- 20. SUBMIT COMPLETE SHOP DRAWINGS FOR ALL JOISTS AND ACCESSORIES, AND A LETTER, SIGNED AND SEALED BY THE DELEGATED ENGINEER, CONFIRMING COMPLIANCE WITH THE DESIGN CRITERIA AND ALL APPLICABLE CODES.

#### **METAL DECKING**

- 1. METAL DECK WORK SHALL CONFORM TO THE REQUIREMENTS OF THE STEEL DECK INSTITUTE.
- 2. METAL ROOF DECK SHALL BE 1 1/2" DEEP, 22 GA., WIDE RIB TYPE B AND GALVANIZED. (VULCRAFT 1.5B22 OR EQUIVALENT.)
- 3. FASTEN ROOF DECK WITH 5/8" DIAMETER PUDDLE WELDS AT EACH SUPPORT PER 36" WIDTH AND #10 TEK SCREWS AT MIDSPAN OF SIDELAPS AS INDICATED ON PLANS.
- 4. METAL FLOOR DECK SHALL BE 9/16" DEEP, 22 GA., GALVANIZED PERMANENT FORM DECK. (VULCRAFT 0.6C22 OR EQUIVALENT.)
- 5. FASTEN FLOOR DECK TO EACH INTERMEDIATE SUPPORT WITH (2) 5/8" DIAMETER PUDDLE WELDS AND (3) 5/8" DIAMETER PUDDLE WELDS TO EACH END LAP SUPPORT PER 36 INCH WIDTH. SIDELAPS SHALL BE FASTENED WITH #12TEK SCREWS AT 36" ON CENTER MAXIMUM.
- 6. MINIMUM FASTENING AT BUILDING PERIMETER OF DECK SHALL BE 5/8" DIAMETER PUDDLE WELDS AT 6" O.C.
- 7. METAL DECK AND SHEET METAL COATING DESIGNATION: A) WITH STRUCTURAL CONCRETE TOPPING — G90
- 8. INSTALL ALL DECKING 3 SPAN CONTINUOUS.

DRAINS, ETC.

PRESSURE (psf)

SUCTION (psf)

- 9. USE WELD WASHERS FOR ALL DECKING 24 GA. AND THINNER.
- 10. DO NOT HANG OR ATTACH DUCTWORK, CONDUIT, PIPING, EQUIPMENT, CEILINGS, ETC. FROM METAL DECKING.
- 11. ROOF DECK OPENINGS 12" DIAMETER OR LARGER ARE TO HAVE SUPPORT ANGLES PER TYPICAL DECK OPENING DETAIL, INCLUDING OPENINGS FOR ROOF SUMP PANS.

12. PRIME AND PAINT ALL FIELD WELDS AFTER INSPECTION WITH A GALVANIZED TOUCH-UP


- PAINT. (SEE NOTE BELOW) 13. SUBMITTALS: CONTRACTOR SHALL SUBMIT DETAILED SHOP DRAWINGS SHOWING LAYOUT OF DECK, TYPE OF DECK, ALL CONNECTIONS INCLUDING END WELDS, SEAM WELDS, INTERMEDIATE WELDS, AND ALL ACCESSORY MATERIAL SUCH AS CLOSURES, SUMPS FOR
- 14. A QUALIFIED TESTING LABORATORY SHALL BE RETAINED TO VISUALLY INSPECT ALL DECK WELDS AND FASTENERS.

18.0

43.7 | 73.4

## GROSS WIND LOADS MAIN ROOF NOMINAL - PSF **ROOFING MATERIALS** ROOF ZONE COMPONENTS AND CLADDING

18.0

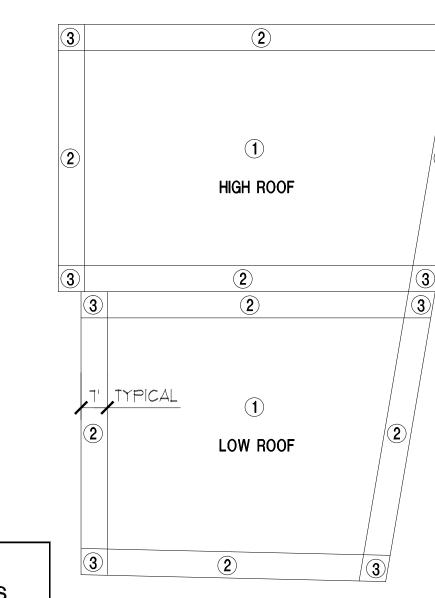

## WIND PRESSURES ( PSF ) EXTERIOR DOORS, WINDOWS, WALLS

18.0

110.5

EFFECTIVE AREA (ft )	ZON	NE 4	ZO	NE 5
AREA (ft)	PRESSURE	SUCTION	PRESSURE	SUCTION
1 TO 20	40.0	(-) 43.4	40.0	(-) 53.4
21 TO 5Ø	38.1	(-) 41.4	38.1	(-) 49.3
51 TO 100	35.9	(-)39.3	35.9	(-) 45.2
101 TO 150	34.2	(-)37.5	34.2	(-) 41.6
151 TO 25Ø	33.2	(-)36.4	33.2	(-) 39.5
70NE 5 16 1111TI	IIN 7 EEET C	E ANY CORN		

ZONE 5 IS WITHIN I FEET OF ANY CORNER. ALL OTHER AREAS ARE ZONE 4.

McCarthy and Associates, Inc. 601 N. Congress Ave. Unit 106 Delray Beach, FL. 33445 (561)265-6864Florida Coa 4187 Robert J. Selinsky, P.E. Florida P.E. 49952 McCarthy Project No. 14295

# **SOWARDS**

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ISSUED FOR: SPRAB 3/05/2015

BIDS

6/29/2015 CONSTRUCTION

PROJECT TITLE

Art Warehouse Renovation


313 NE 3rd Street Delray Bch., Florida 33444


REVISIONS

THESE DRAWINGS ARE PREPARED PER ESTABLISHED INDUSTRY STANDARDS AND REPRESENT THE ARCHITECT AND ENGINEERS DESIGN CONCEPT THEY ARE NOT INTENDED TO PROVIDE EVERY DETAIL OR CONDITION REQUIRED TO CONSTRUCT THE PROJECT. THE CONTRACTOR THROUGH SUBMITTALS AND OTHER COORDINATION EFFORTS IS FULLY RESPONSIBLE FOR PROVIDING A COMPLETE AND OPERATIONAL PROJECT WHETHER INDICATED ON THE PLANS OR NOT. FILE NUMBER

DRAWING TITLE STRUCTURAL SPECIFICATIONS O AND WIND CHARTS

DRAWN BY 6/29/201 JOB NUMBER

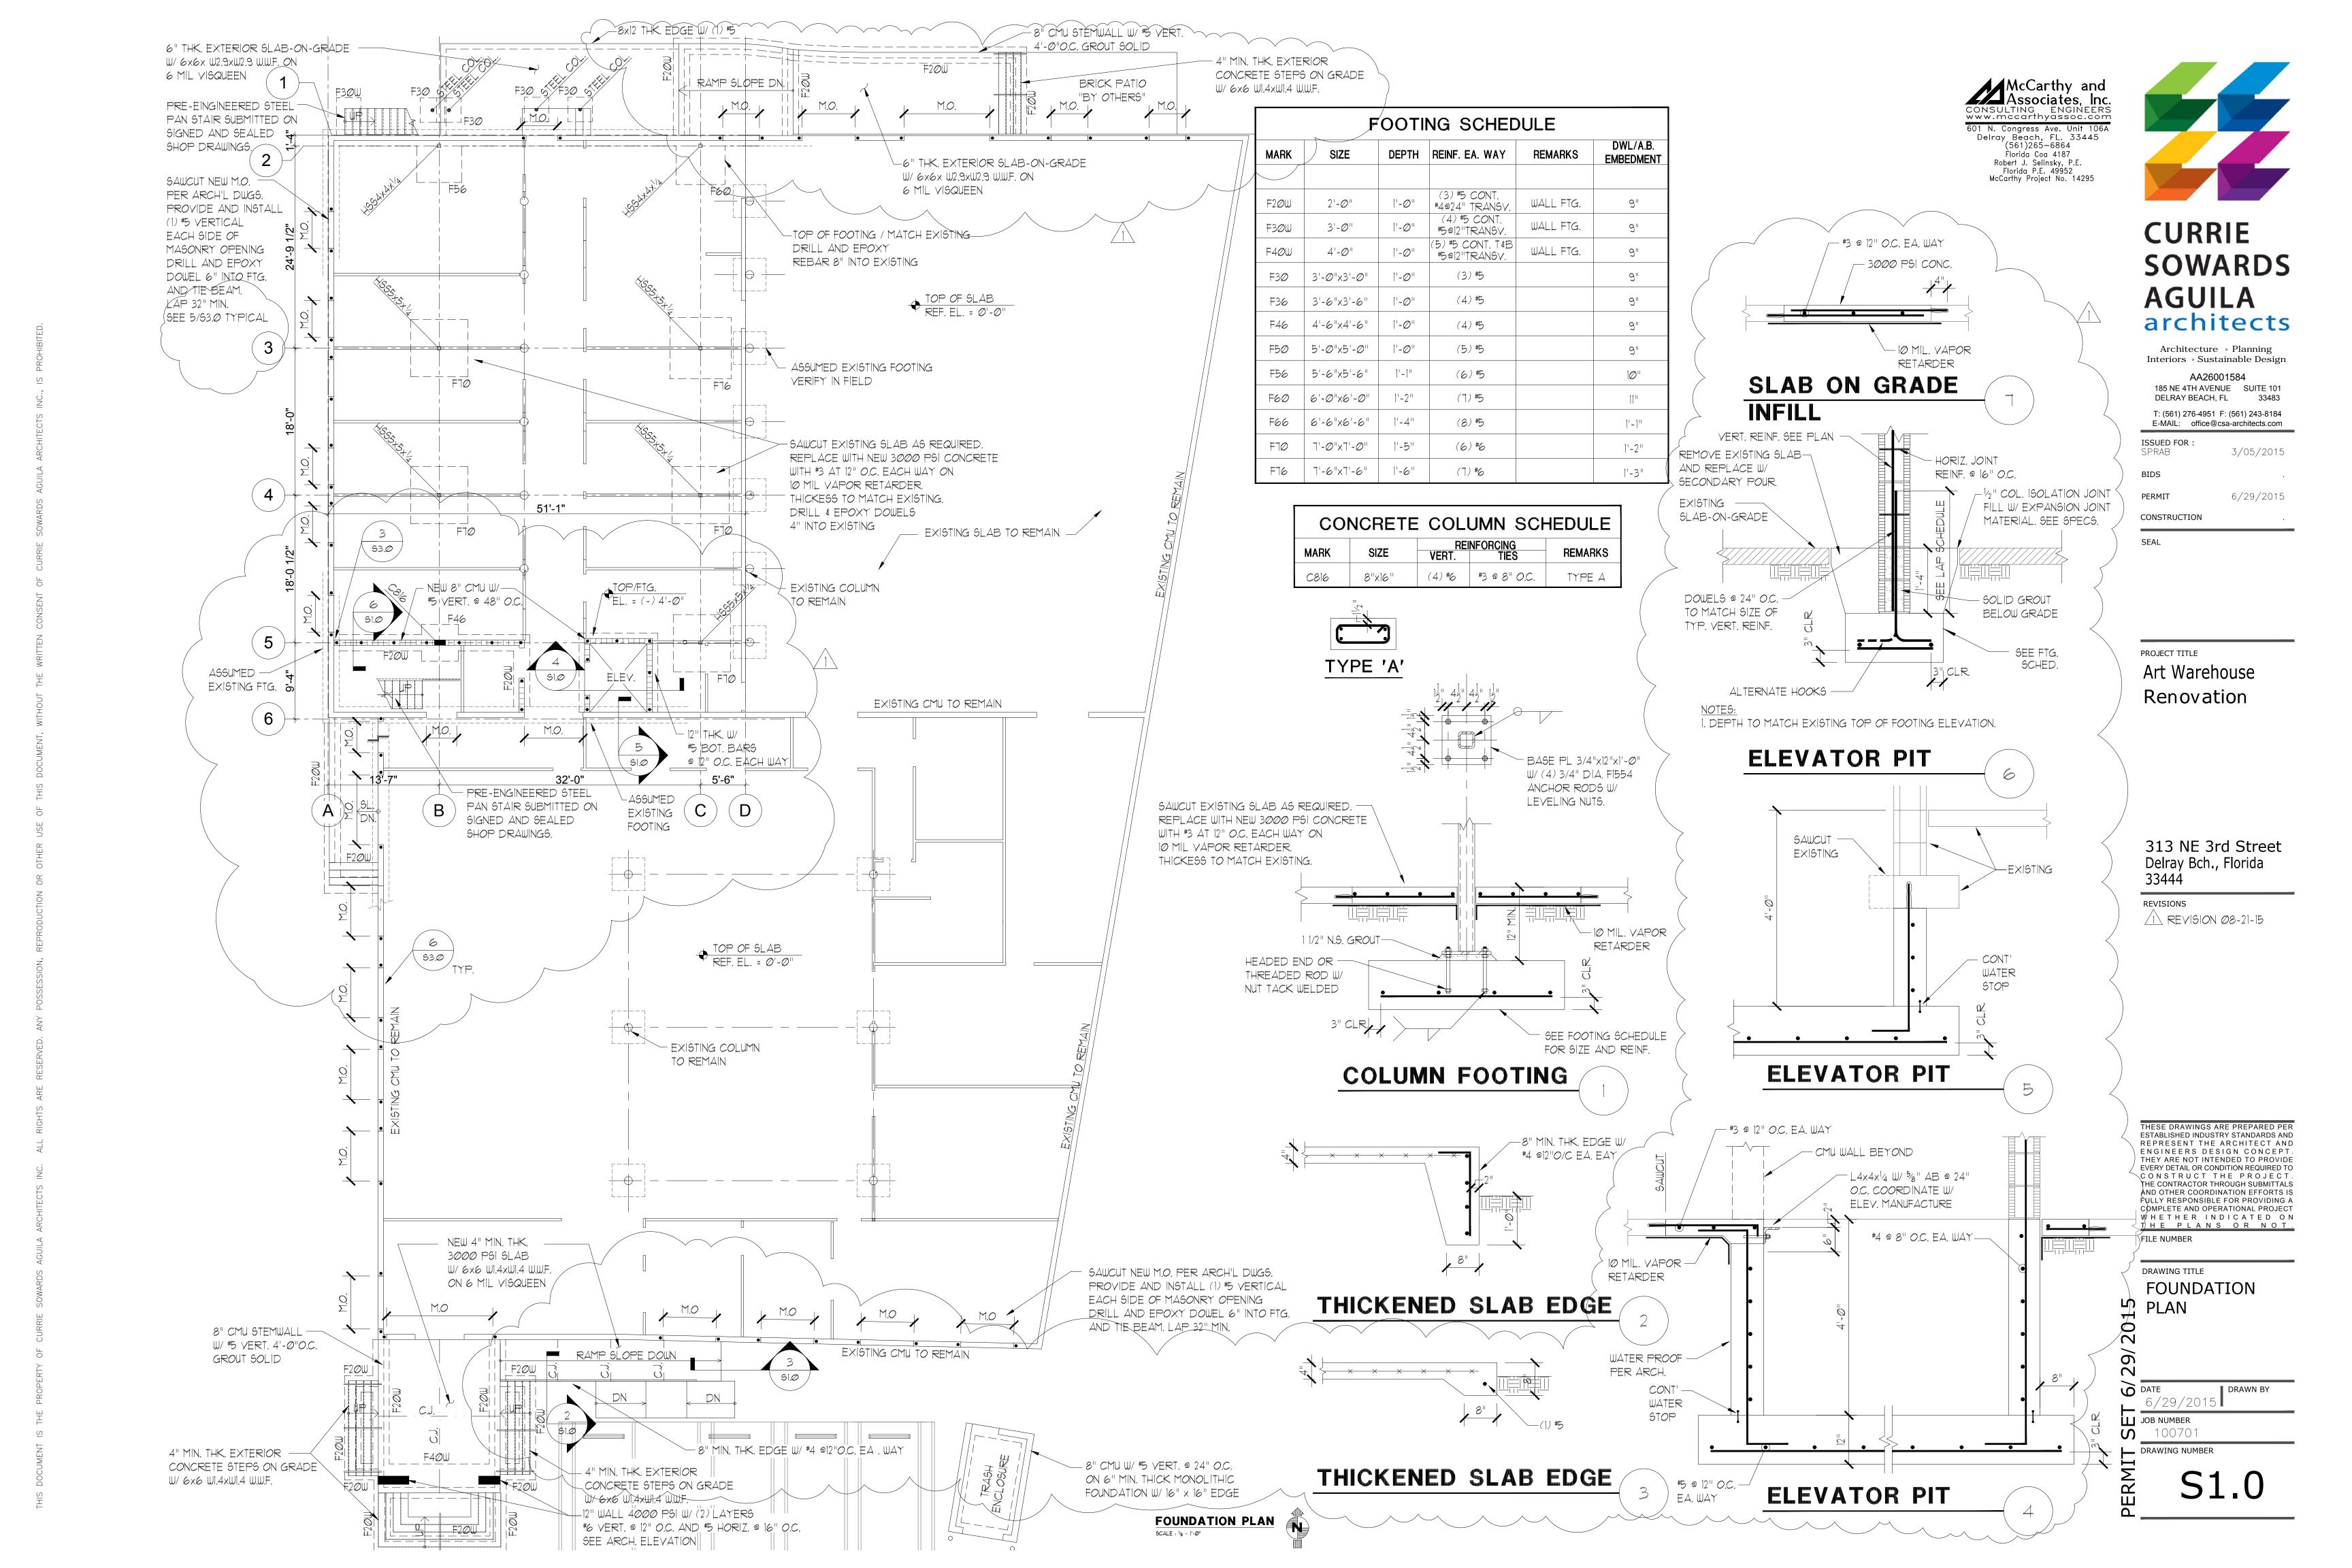

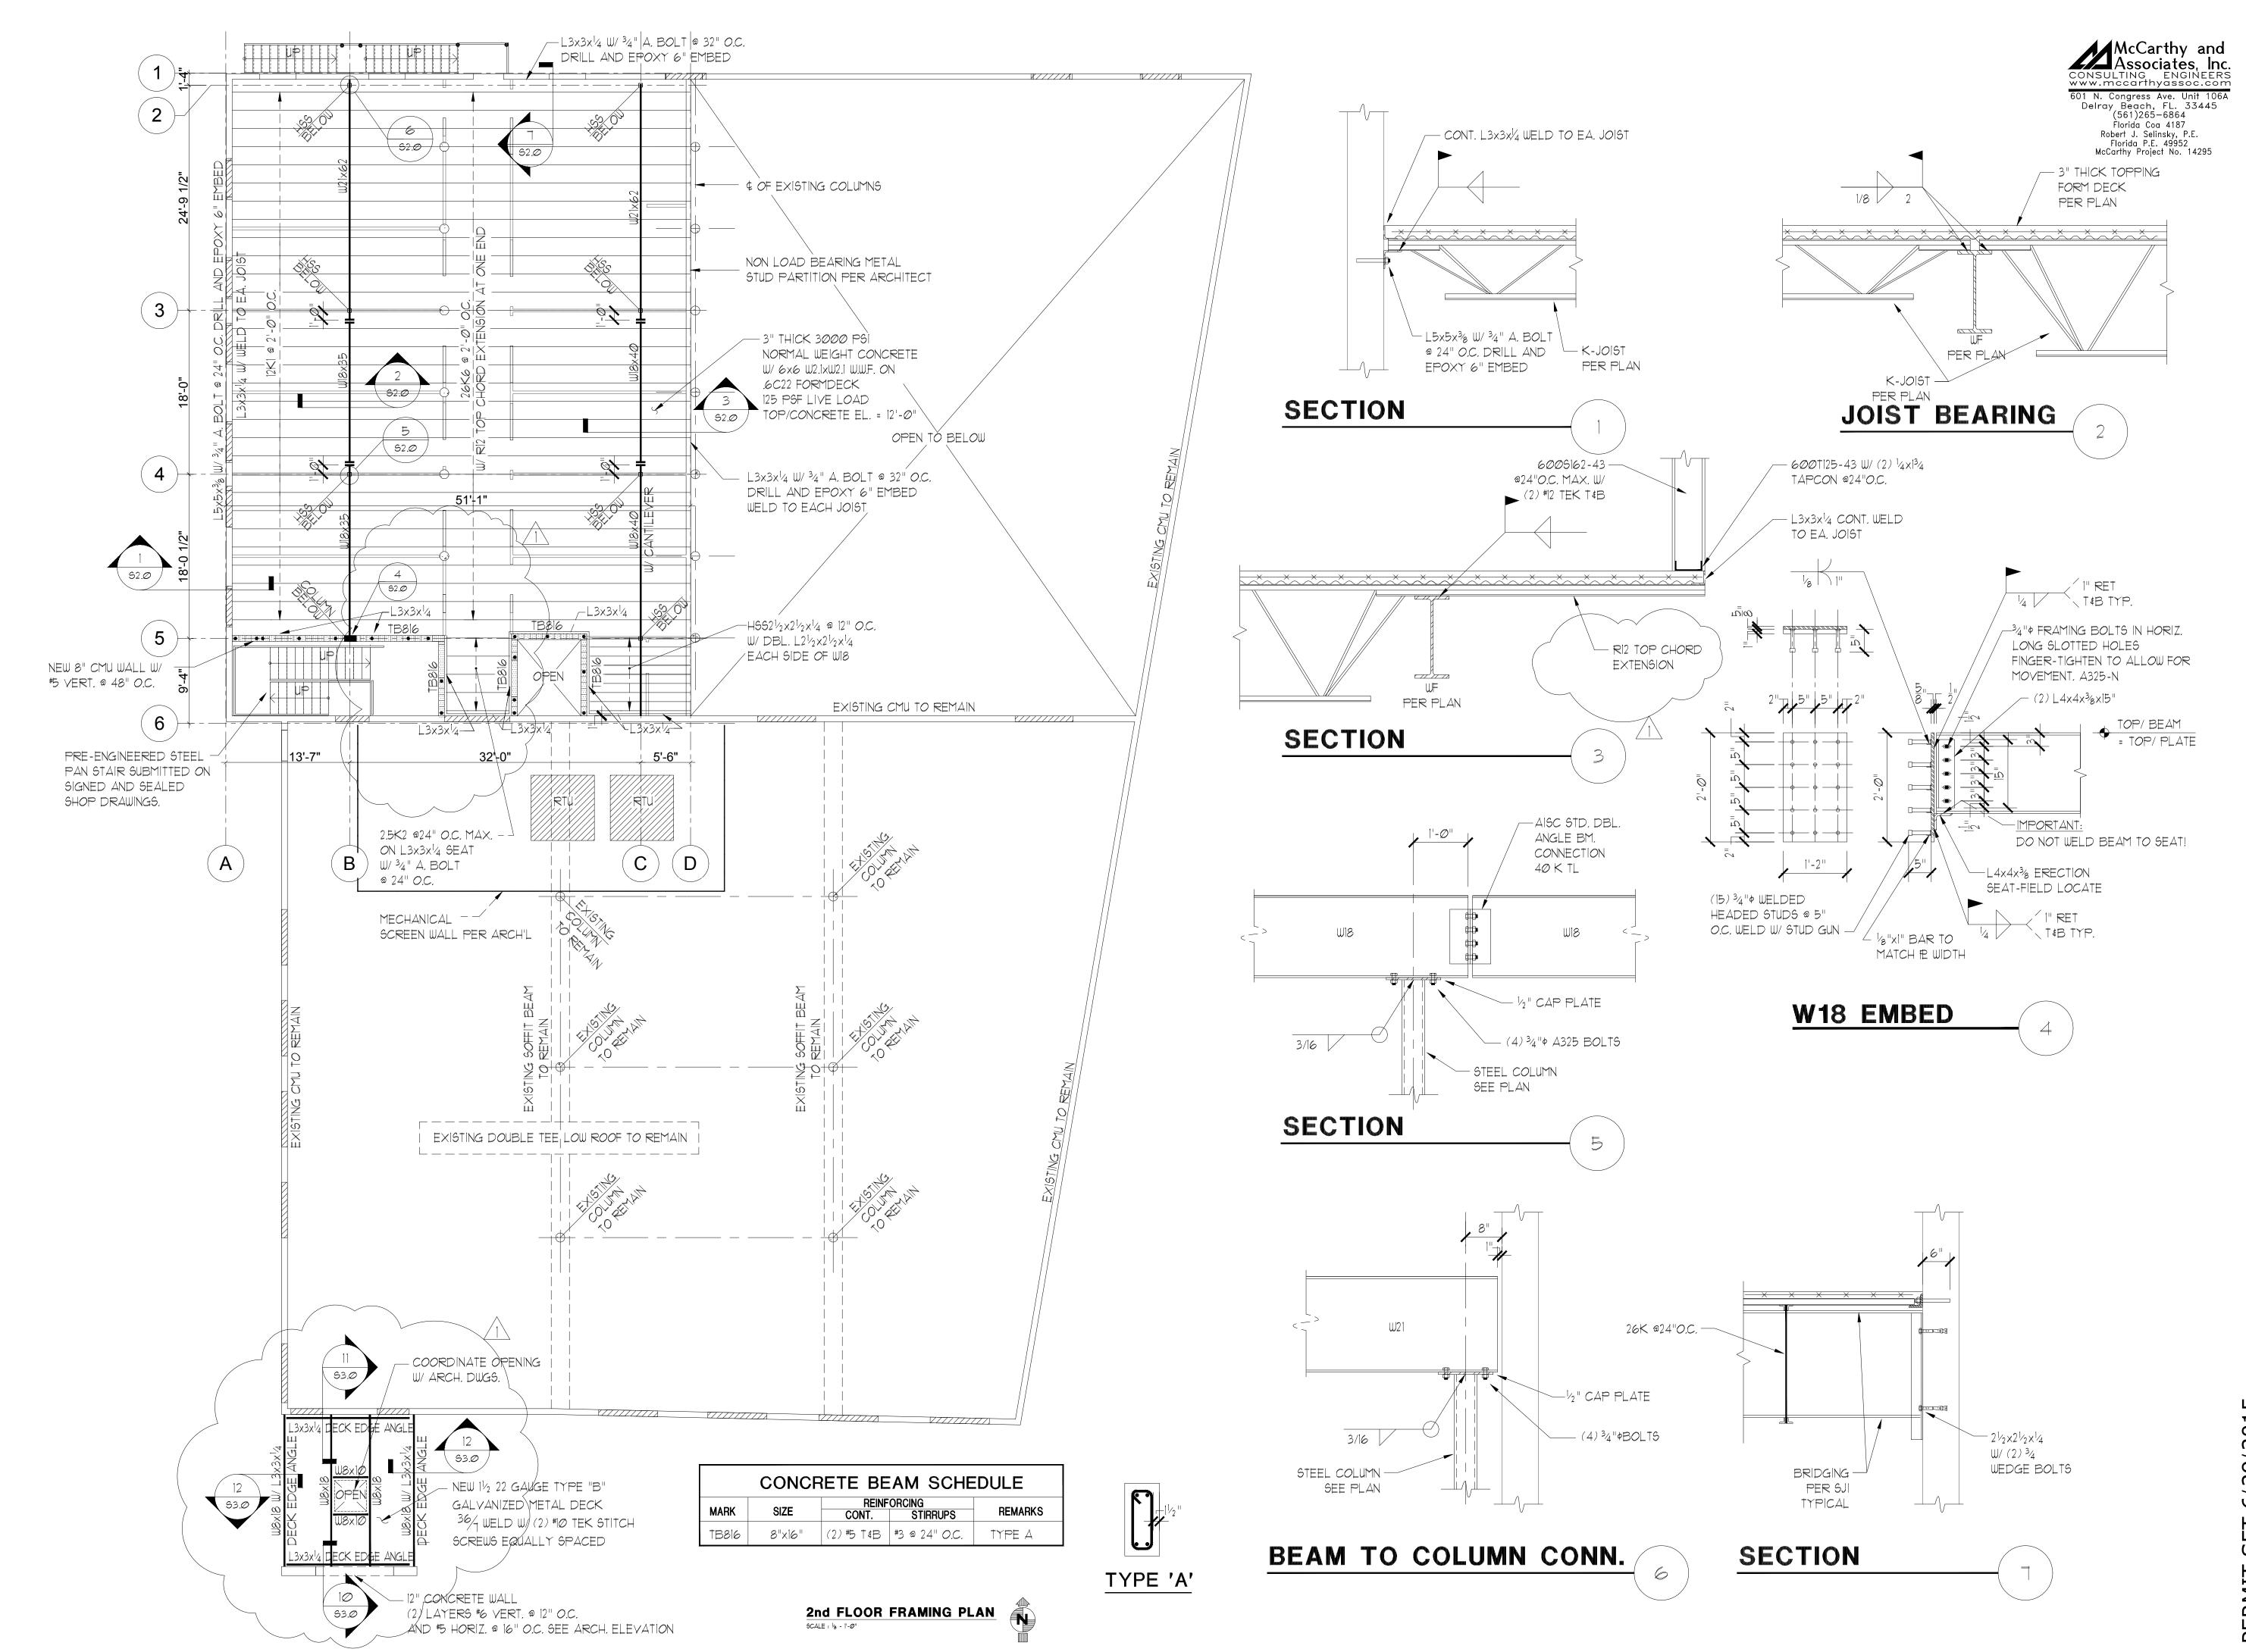



## CURRIE SOWARDS AGUILA architects

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ISSUED FOR: SPRAB 3/05/2015

PERMIT 6/29/2015

CONSTRUCTION .

SEAI

BIDS

PROJECT TITLE

## Art Warehouse Renovation

313 NE 3rd Street Delray Bch., Florida 33444

REVISIONS

1 REVISION 08-21-15

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DRAWING TITLE


2ND FLOOR FRAMING PLAN


DATE | DRAWN BY | 6/29/2015 | JOB NUMBER

100701

DRAWING NUMBER

S2.0

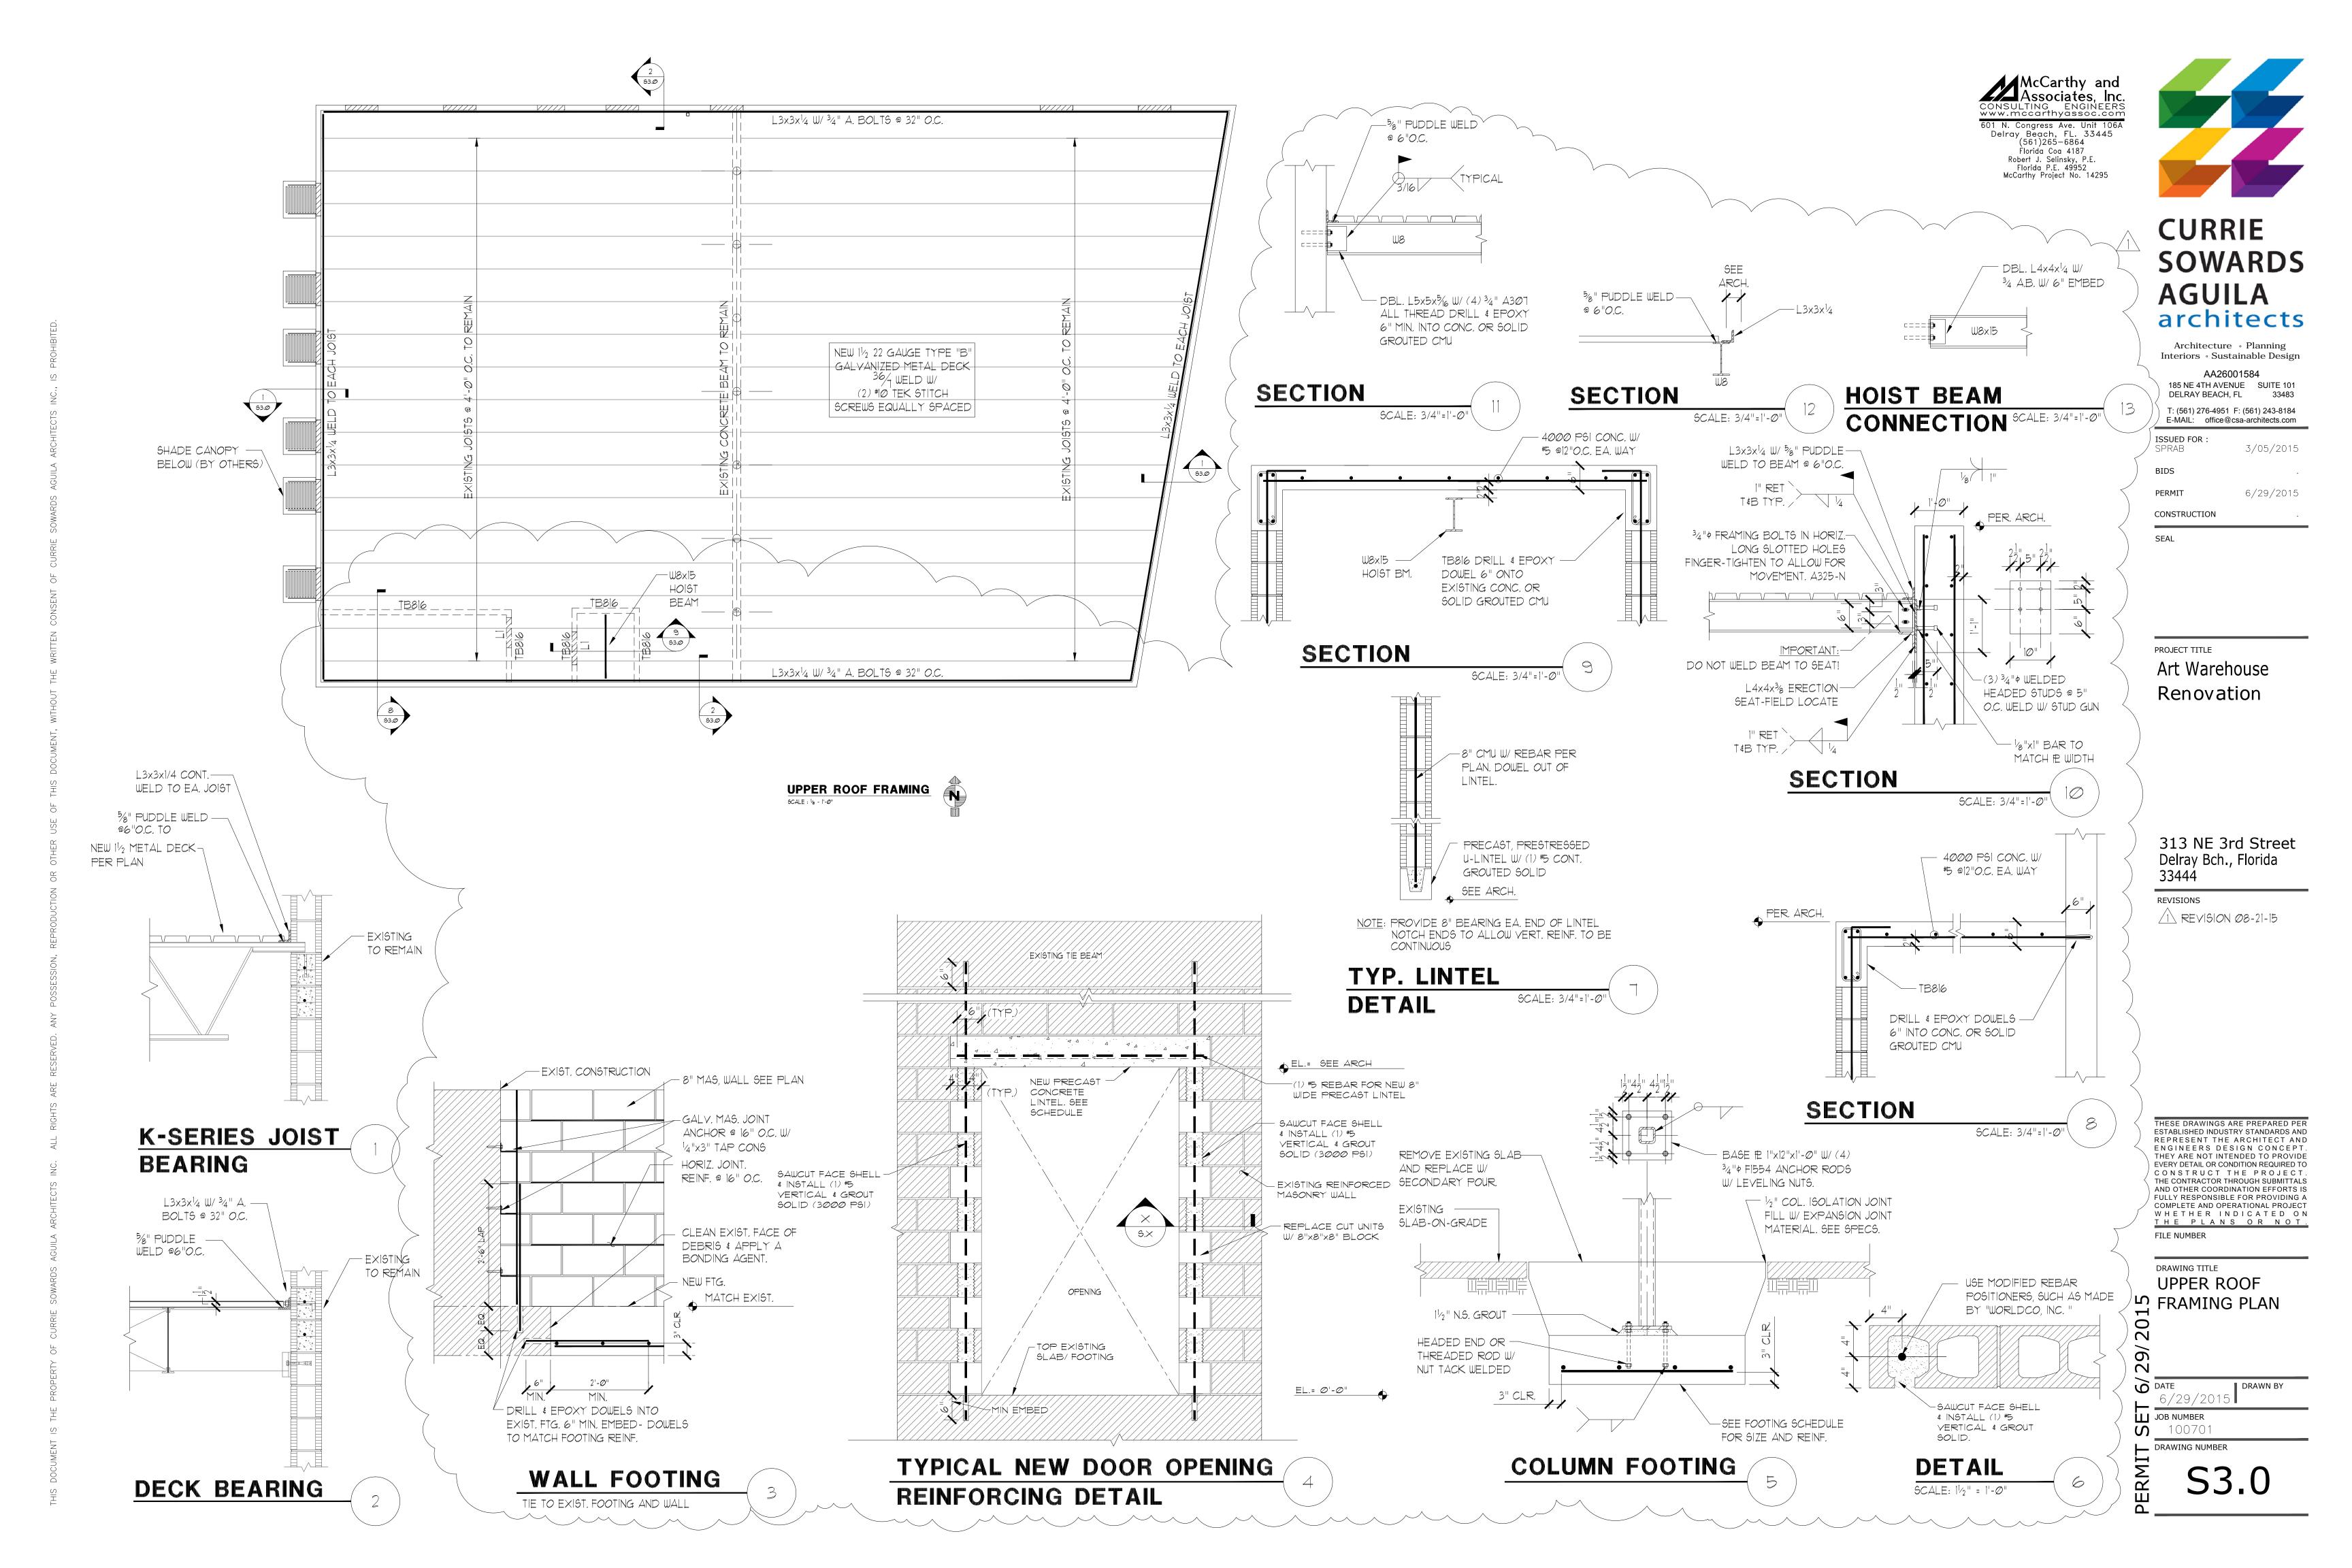

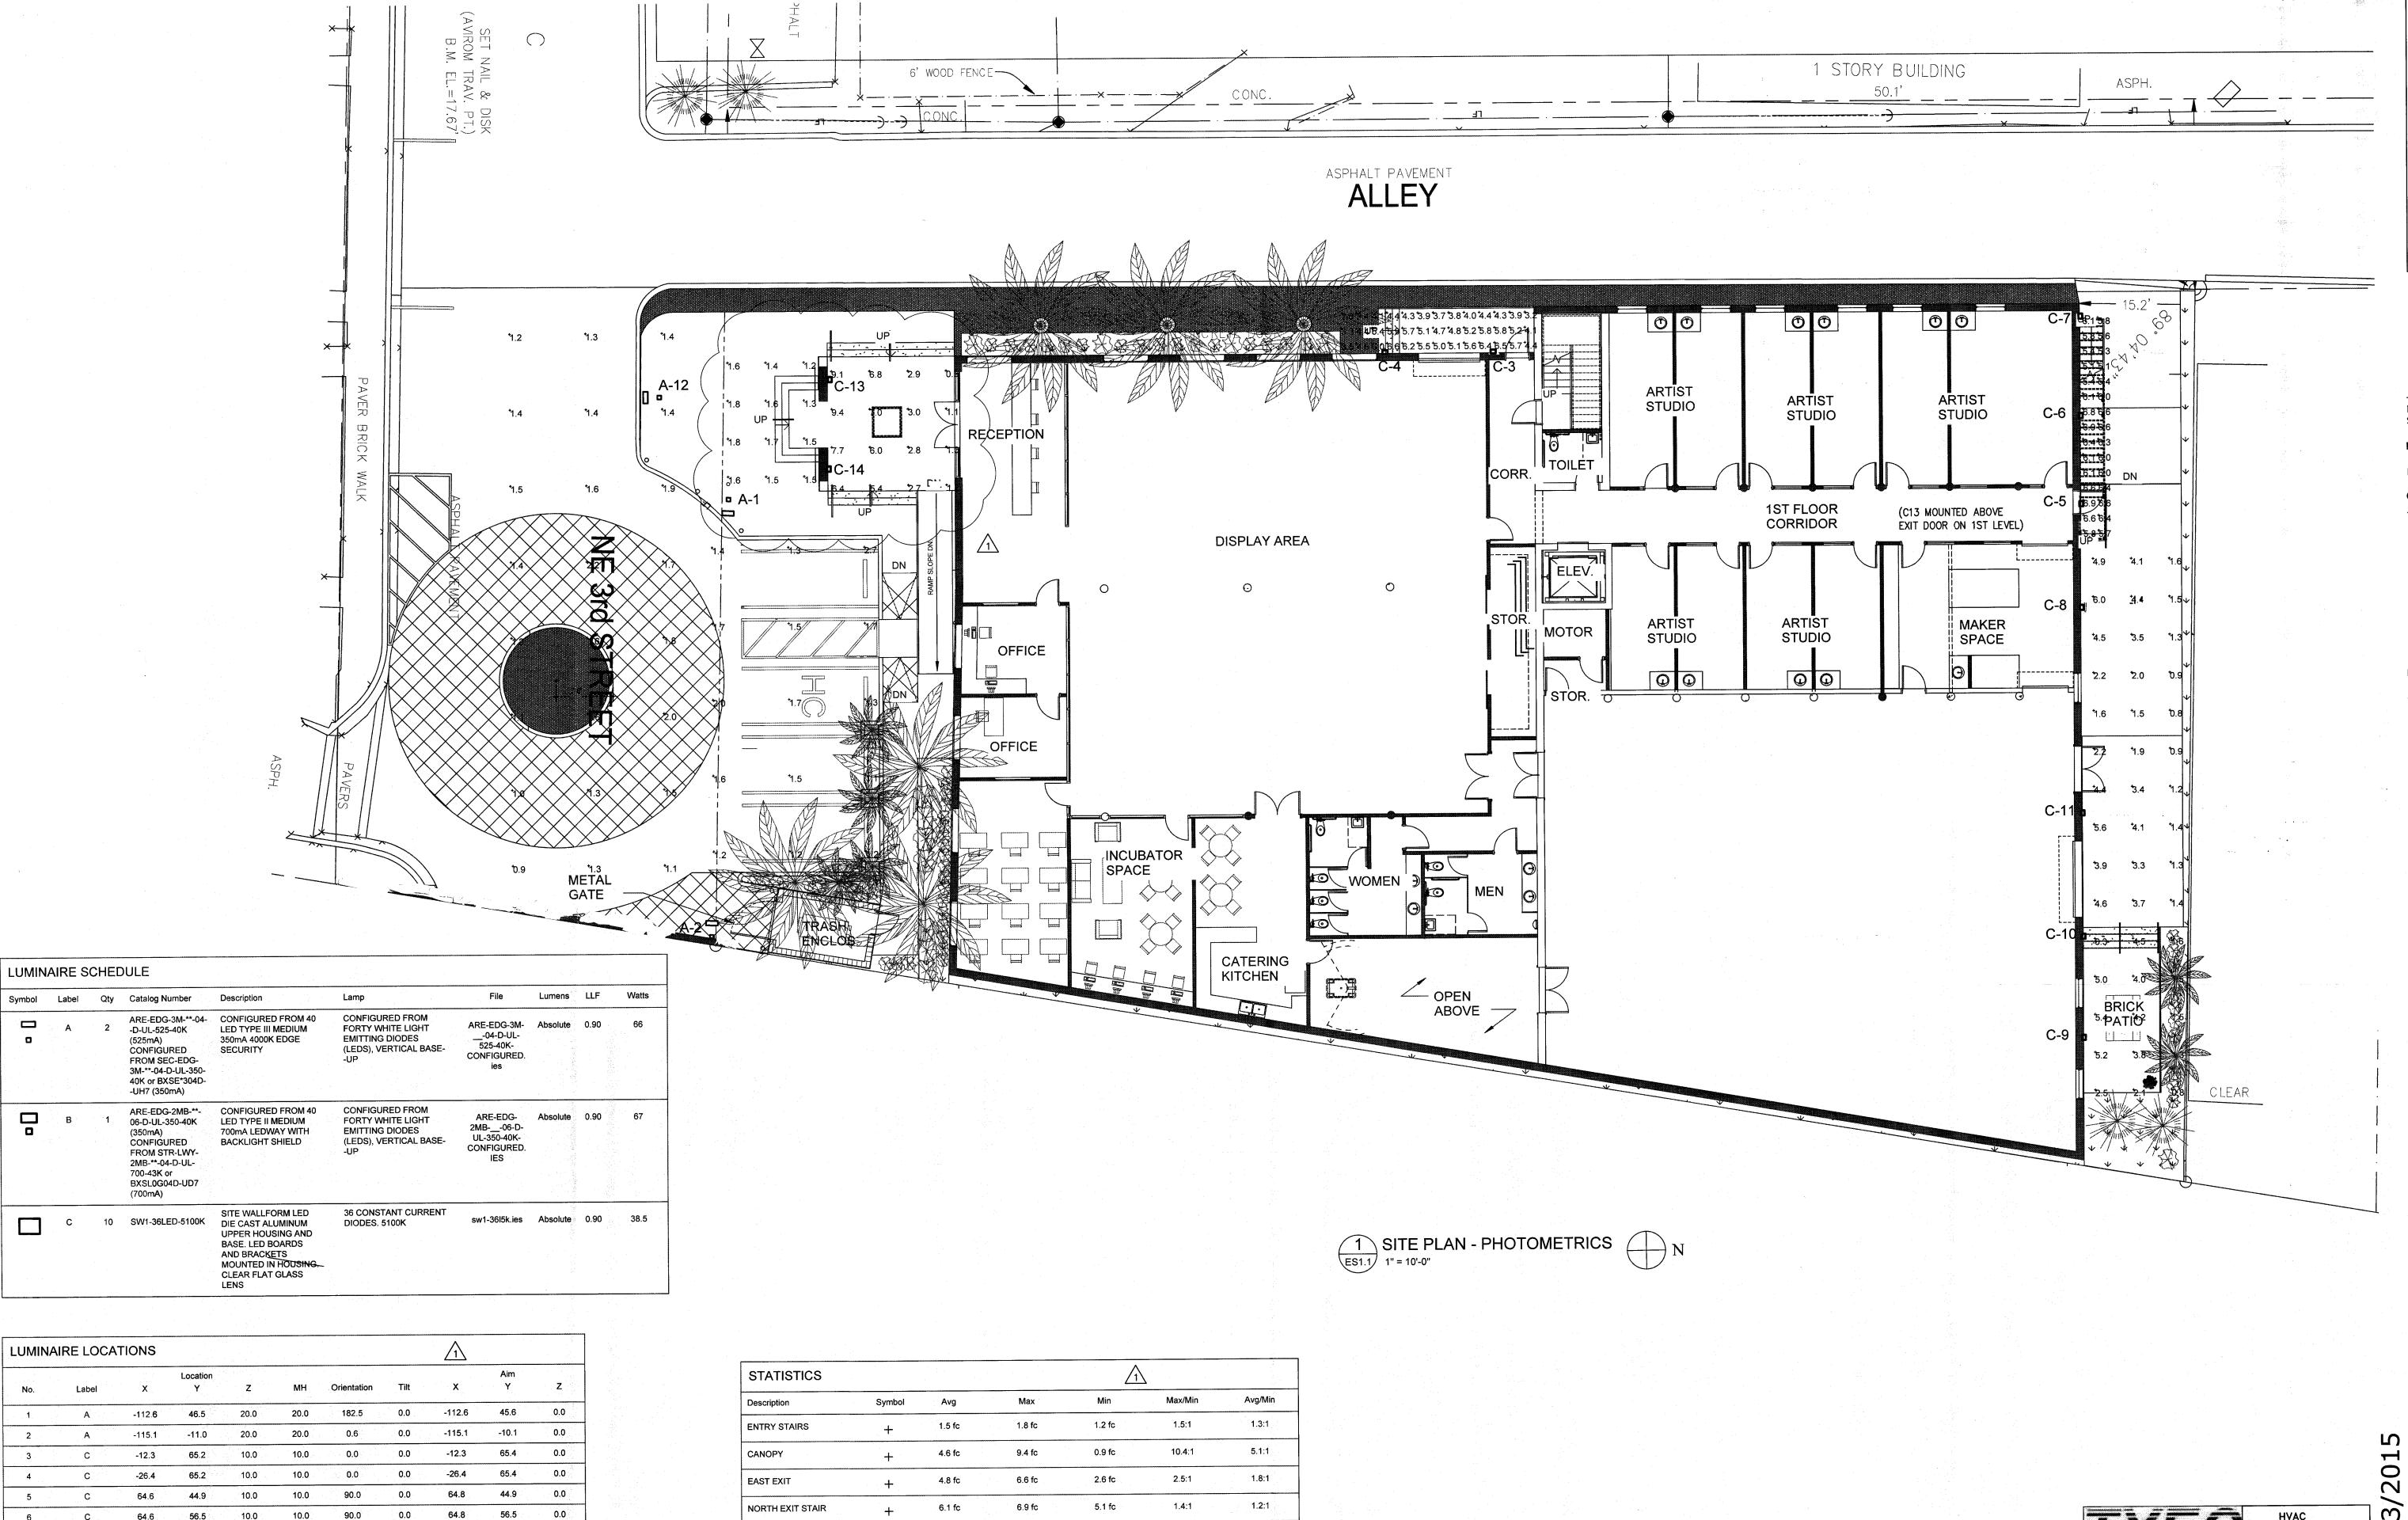

3.8:1

1.4:1

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0.8 fc

1.1 fc

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2.2 fc

3.0 fc

1.5 fc

1.4 fc

NORTH UTILITY AREA

PARKING

SOUTH DRIVE

10.0

10.0

10.0

10.0

10.0

10.0

10.0

10.0

9.9

31.3

-25.3

-12.0

62.2

-121.5

-99.4

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-99.2

-99.4

-25.3

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02/13/15

ISSUED FOR : SPRAB

PERMIT

CONSTRUCTION

PROJECT TITLE Art Warehouse

313 NE 3rd Street Delray Bch, Florida, 33444

REVISIONS
NUM. DESCRIPTION DATE SITE PLAN REVIEW 7/14/15 COMMENT

THESE DRAWINGS ARE PREPARED PER ESTABLISHED INDUSTRY STANDARDS AND REPRESENT THE ARCHITECT AND ENGINEERS DESIGN CONCEPT. THEY ARE NOT INTENDED TO PROVIDE EVERY DETAIL OR CONDITION REQUIRED TO CONSTRUCT THE BUILDING. THE CONTRACTOR THROUGH SUBMITTALS AND OTHER COORDINATION EFFORTS IS FULLY RESPONSIBLE FOR PROVIDING A COMPLETE AND OPERATIONAL BUILDING WHETHER INDICATED ON THE PLANS OR NOT. FILE NUMBER

15009E-1.1.DWG

DRAWING TITLE SITE PLAN -**PHOTOMETRICS** 

DRAWN BY DATE 01/13/15 AJY

JOB NUMBER
100701/15009

PLUMBING ELECTRICAL

THOMPSON & YOUNGROSS ENGINEERING CONSULTANTS, LLC CERTIFICATE of AUTHORIZATION NO. 25996

112 SOUTHEAST 10th STREET DELRAY BEACH, FL 33483 www.tecfla.com

TEL: 561-274-0200 FAX: 561-274-0222 E-MAIL: tec@tecfla.com

- ELECTRICAL CONTRACTOR SHALL BE FULLY COGNIZANT OF THE LATEST EDITION OF THE 2010 FBC. 2008 NEC. 2009 NFPA101, 2002 NFPA72, 2010 FLORIDA FIRE PREVENTION CODE AND ALL LOCAL CODES, ORDINANCES OF THE AUTHORITIES HAVING JURISDICTION AND PERFORM ALL WORK IN ACCORDANCE WITH THE INTENT AND REQUIREMENTS OF THESE CODES, ORDINANCES
- DO NOT SCALE DRAWINGS: VERIFY DIMENSIONS IN FIELD PRIOR TO COMMENCEMENT OF ALL WORK. THE DRAWINGS ARE DIAGRAMMATIC AND INDICATE GENERAL LAYOUT OF ELECTRICAL SYSTEMS.
- WHEREVER THE WORD "PROVIDE" IS USED, IT SHALL MEAN TO "FURNISH AND INSTALL". FINAL CONNECTIONS TO EQUIPMENT SHALL BE PER MANUFACTURERS APPROVED WIRING
- DIAGRAMS, DETAILS AND INSTRUCTIONS. IT SHALL BE THE CONTRACTORS RESPONSIBILITY TO PROVIDE MATERIALS AND EQUIPMENT COMPATIBLE WITH EQUIPMENT ACTUALLY SUPPLIED.
- PROVIDE WITH SHOP DRAWING SUBMITTAL, 1/4" SCALE LAYOUT DRAWINGS OF AREAS WITH ELECTRICAL SWITCHGEAR AND TRANSFORMERS. LAYOUT SHALL SHOW LOCATIONS OF AND SHALL BE COORDINATED WITH MECHANICAL EQUIPMENT AND MECHANICAL EQUIPMENT SHALL BE DRAWN TO SCALE.
- IT IS THE INTENT OF THESE DRAWINGS AND SPECIFICATIONS TO ESTABLISH A STANDARD OF QUALITY. THE ENGINEER RESERVES THE RIGHT TO APPROVE METHODS AND MATERIALS NOT
- THE CONTRACTOR SHALL REVIEW ARCHITECTURAL, STRUCTURAL AND MECHANICAL DRAWINGS AND SHALL PROVIDE LIGHTS, SWITCHES, RECEPTACLES, TELEPHONE OUTLETS, EQUIPMENT CONNECTIONS, ETC. AND ASSOCIATED CIRCUITING IN NEW AND REMODELED AREAS, EVEN IF SUCH AREAS ARE NOT SOWN ON THE ELECTRICAL DRAWINGS. LAYOUTS, FIXTURE TYPES, QUANTITIES AND SPACING SHALL BE IN ACCORDANCE WITH SIMILAR AREAS ON THIS PROJECT. THE CONTRACTOR SHALL INCLUDE COSTS FOR THE ABOVE IN HIS BID. IN ADDITION, THE CONTRACTOR SHALL PROVIDE LAYOUT DRAWINGS FOR WORK IN SUCH AREAS AND SUBMIT FOR APPROVAL PRIOR TO ROUGH-IN.
- THE CONTRACTOR SHALL REVIEW ARCHITECTURAL, STRUCTURAL, MECHANICAL AND OTHER DRAWINGS PRIOR TO BID AND SHALL COORDINATE ALL TRADES TO PROVIDE A COMPLETE PRODUCT TO AVOID CONFLICTS BETWEEN TRADES, AND TO DETERMINE WHICH TRADE IS TO PERFORM THE NECESSARY WORK. COORDINATION BETWEEN TRADES SHALL INCLUDE LOW
- PROVIDE SUBSTITUTIONS OF ELECTRICAL EQUIPMENT OR REQUEST FOR "OR EQUIVALENT" OR "APPROVED EQUIVALENT" LISTING SHALL BE SUBMITTED TO THE ARCHITECT NOT LESS THAN TEN (10) WORKING DAYS PRIOR TO BID. REFER TO SPECIFICATIONS FOR ADDITIONAL
- O. WORK SHALL BE PERFORMED IN A WORKMANLIKE MANNER TO THE SATISFACTION OF THE
- . ALL EQUIPMENT AND MATERIALS PROVIDED SHALL BE NEW AND IN CONFORMANCE WITH APPLICABLE PROVISIONS OF NEMA, ANSI, U.L., ETC AND SHALL BEAR AN APPROVED TESTING AGENCY LABEL WHERE APPLICABLE.
- 2. PROVIDE PERMITS AND INSPECTIONS AS REQUIRED.
- 13. GUARANTEE THE INSTALLATION AGAINST DEFECTS IN MATERIALS AND WORKMANSHIP WHICH MAY OCCUR UNDER NORMAL USAGE FOR A PERIOD OF ONE YEAR AFTER OWNER'S ACCEPTANCE. DEFECTS SHALL BE PROMPTLY REMEDIED WITHOUT COST TO THE OWNER.
- 4. PROVIDE RECORD DRAWINGS TO THE BUILDING OWNER AND ARCHITECT WITHIN 30 DAYS AFTER SYSTEM ACCEPTANCE, PER FLORIDA BUILDING CODE - ENERGY CONSERVATION, SECTION 505. 505.7.4.2. DRAWINGS SHALL INCLUDE ALL ADDENDUM ITEMS, CHANGE ORDERS, ALTERATIONS, RE-ROUTINGS, ETC.
- 15. VERIFY EXACT LOCATION OF EQUIPMENT TO BE FURNISHED BY OTHERS PRIOR TO ROUGH—IN MODIFICATIONS REQUIRED DUE TO LACK OF COORDINATION BY CONTRACTORS, WILL BE DONE AT NO ADDITIONAL COST TO THE OWNER.
- 16. SYSTEMS SHALL BE TESTED FOR PROPER OPERATION. IF TESTS SHOW THAT WORK IS DEFECTIVE, THE CONTRACTOR SHALL MAKE CORRECTIONS NECESSARY AT NO COST TO THE
- 7. THE CONTRACTOR SHALL PROVIDE OPERATING MANUALS TO THE OWNER, PER PER FLORIDA BUILDING CODE - ENERGY CONSERVATION, SECTION 505, 505.7.4.1.
- 18. THE CONTRACTOR SHALL COORDINATE WITH FPL ALL REQUIREMENTS FOR CONDUIT ENTRY AND CABLE TERMINATIONS IN THE UTILITY TRANSFORMER. ANY CONFLICTS SHALL BE BROUGHT TO THE ATTENTION OF THE ARCHITECT/ENGINEER PRIOR TO COMMENCEMENT OF WORK.

TYPE VOLTS

DESCRIPTION

- 19. THE CONTRACTOR SHALL COORDINATE WITH THE TELEPHONE UTILITY FOR PROVIDING THE REQUIRED CONDUIT SIZE AND NUMBER TO THE TENANT SPACE. THE CONTRACTOR SHALL PROVIDE ALL CONDUITS WITH PULL CORDS AND SHALL INSTALL FROM THE LOCAL TELEPHONE BOARD TO THE MAIN POINT OF SERVICE.
- FIRE ALARM SYSTEM. CONTRACTOR SHALL PROVIDE DEVICES, CONDUIT, WIRES AND CABLE AS DIRECTED BY EQUIPMENT AND WORKMANSHIP SHALL MEET PREVAILING CODES. THE SYSTEM SHALL BE COMPLETE AND OPERABLE IN EVERY RESPECT. SUBMIT SINGLE LINE OF SYSTEM WITH SHOP DRAWINGS. THIS SINGLE LINE DIAGRAM SHALL SHOW DEVICES, CONDUIT, WIRE AND CABLE SIZES, EQUIPMENT TO BE USED AND SHALL BE STAMPED AND SIGNED BY LOCAL FIRE | 34. DEVICES SHALL BE AS FOLLOWS: DEPARTMENT. SYSTEM CALIBRATION AND TESTING SHALL BE BY FACTORY CERTIFIED
- 21. NOT USED.
- 22. WRE SHALL BE COPPER, 75 DEGREES C RATED FOR GENERAL USE, FOR HID FIXTURES AND WIRING WITHIN 3 INCHES OF FLUORESCENT BALLAST WIRE SHALL BE COPPER. MINIMUM 90 DEGREES C RATED. SIZES INDICATED ARE FOR INSTALLATION IN A MAXIMUM 30 DEGREES C AMBIENT. CONDUCTOR AMPACITY SHALL BE DERATED FOR HIGHER AMBIENT INSTALLATIONS. THE CONTRACTOR SHALL INCREASE THE SIZE OF THE CONDUCTOR TO MEET VOLTAGE DROP REQUIREMENTS WHERE FIELD CONDITIONS INCREASE THE CONDUIT RUN LENGTH SUCH THAT THE VOLTAGE DROP IS EFFECTED.
- 23. SPLICES IN EXTERIOR PULL BOXES AN MANHOLES SHALL BE MADE WATER PROOF USING "SCOTCHCAST" SPLICE KIT OR APPROVED EQUIVALENT. SEAL ENDS OF CONDUITS AND DUCTS WITH "DUCT SEAL" OR APPROVED EQUIVALENT
- 24. ALL EMPTY RACEWAY SYSTEMS SHALL HAVE A #12 PULL WIRE OR EQUIVALENT AND SHALL BE IDENTIFIED AT ALL JUNCTION, PULL AND TERMINATION POINTS, USING PERMANENT METALLIC TAGS. TAG SHALL INDICATE INTENDED USE OF CONDUIT, ORIGINATION AND TERMINATION POINTS 38. RECESSED FIXTURES INSTALLED INDOORS SHALL BE THERMALLY PROTECTED. OF EACH INDIVIDUAL CONDUIT.
- 25. PROVIDE APPROVED FIRE STOPPING MATERIALS AT ALL PENETRATIONS THROUGH FIRE RATED FLOORS AND WALLS TO PREVENT THE PASSAGE OF SMOKE, FIRE TOXIC GAS OR WATER THROUGH THE PENETRATION EITHER BEFORE, DURING OR AFTER A FIRE, AS REQUIRED BY ARTICLE 300, OF THE NEC.
- 26. PRESENT SHOP DRAWING SUBMITTAL DATA AT ONE TIME, BOUND IN THREE-RING BINDERS, INDEXED IN A NEAT AND ORDERLY MANNER, PARTIAL SUBMITTALS WILL NOT BE ACCEPTED. SUBMITTALS SHALL INCLUDE. BUT NOT BE LIMITED TO: LIGHTING FIXTURES. SWITCHGEAR. PANELBOARDS, WIRING DEVICES, SAFETY SWITCHES, FUSES, MOTOR STARTERS, LAMPS, CONDUIT, CONDUIT FITTINGS AND TRANSFORMERS.
- 27. CONTRACTOR SHALL BE RESPONSIBLE FOR REPLACING EQUIPMENT WHICH IS DAMAGED DUE TO INCORRECT FIELD WIRING PROVIDED UNDER THIS SECTION OR FACTORY WIRING IN EQUIPMENT PROVIDED UNDER THIS SECTION.
- 28. CONTRACTOR'S FAILURE TO ORDER OR RELEASE ORDER FOR MATERIALS AND/OR EQUIPMENT WILL NOT BE ACCEPTED AS A REASON TO SUBSTITUTE ALTERNATE MATERIAL, EQUIPMENT OR
- 29. SYSTEMS SHALL BE COMPLETE, OPERABLE AND READY FOR CONTINUOUS OPERATION. LIGHTS, SWITCHES, RECEPTACLES, MOTORS, ETC., SHALL BE CONNECTED AND OPERABLE.
- 50. RECEPTACLES WHICH ARE SHOWN WALL MOUNTED ON THE ELECTRICAL DRAWINGS ON WALLS WHICH, ON THE ARCHITECTURAL DRAWINGS AND ELEVATIONS ARE SHOWN AS GLASS OR PARTITIONS, SHALL BE FLUSH FLOOR DUPLEX RECEPTACLES MOUNTED ADJACENT TO BASE OR WALLS.
- VERIFY EXACT LOCATIONS OF EXISTING AND NEW UNDERGROUND UTILITIES, PIPING AND RACEWAY SYSTEMS PRIOR TO TRENCHING. PROVIDE NECESSARY TRENCHING, BACKFILL, EXCAVATION, SUPPORTS, SERVICE FEEDERS (CONDUIT AND/OR WIRE), PULL BOXES, TRANSFORMER PAD. SAW CUTTING AND PATCHING, CONCRETE/PAVING, ETC., REQUIRED BACKFILL TRENCHED TO 90% COMPACTION AND PATCH TO MATCH EXISTING. CONTRACTOR SHALL OBTAIN AND VERIFY EXACT UTILITY COMPANY DRAWINGS AND REQUIREMENTS.

NO. DESIGNATION

- 32. PULL BOXES, CABINETS, ETC., MOUNTED ON THE EXTERIOR AT GRADE LEVEL, SHALL BE WEATHER PROOF TYPE WITH HINGED LOCKABLE COVERS SECURED WITH TAMPER-PROOF
- 3. FLUSH FLOOR RECEPTACLE OUTLETS SHALL BE HUBBELL #B-2529 WITH BRASS COVER #S-3725. PROVIDE CARPET OR TILE FLANGE TO MATCH FLOOR FINISH.
- 32. FLUSH FLOOR TELEPHONE OUTLETS SHALL BE HUBBELL #B-2529 WITH BRASS COVER #S-2725. PROVIDE CARPET OR TILE FLANGE TO MATCH FLOOR FINISH.
- RECEPTACLES HUBBELL #5362 SERIES
- SWITCHES HUBBELL #1221 SERIES DIMMERS - LUTRON "NOVA" SERIES.
- THE COLOR OF THE DEVICES AND COVER PLATES SHALL BE AS DIRECTED BY ARCHITECT. IN DAMP OR WET LOCATIONS COVER PLATES SHALL BE STAINLESS STEEL. IN DRY LOCATIONS COVER PLATES SHALL BE SMOOTH HIGH ABUSE NYLON OR EQUIVALENT. PROVIDE COVER PLATES FOR SWITCHES, RECEPTACLES, TELEPHONE, TELEVISION, COMPUTER, AND J-BOX OUTLETS AS REQUIRED.
- 35. BOXES FOR TELEPHONE, T.V., COMPUTER, WIRING DEVICES, ETC., SHALL BE MINIMUM 4" SQUARE.
- 6. STEEL TYPE "MC" CABLE #12 AWG AND #10 AWG WITH A FULL SIZED GROUNDING CONDUCTOR MAY BE USED WHERE PERMITTED BY BOTH THE N.E.C. AND LOCAL ORDINANCE. IN THE FOLLOWING APPLICATIONS:
  - 1. IN WALLS FOR HORIZONTAL DEVICE CONNECTION ONLY. HOMERUNS TO PANELBOARDS SHALL BE EMT OR PVC (BELOW GRADE).
- RECESSED LIGHT FIXTURES INSTALLED IN GYP. BOARD OR PLASTER CEILINGS SHALL HAVE PLASTER FRAMES INSTALLED PRIOR TO CEILING MATERIAL.
- 39. FIXTURES RECESSED IN "T-BAR" U.L. FIRE RATED CEILING ASSEMBLIES SHALL BE SUPPORTED INDEPENDENTLY OF THE CEILING SYSTEM. WITH TWO #12 HANGER WIRES UP TO STRUCTURE. SECURE HANGER WIRES TO CORNERS OF FIXTURE. CLIP FIXTURE TO GRID ON TWO SIDES WITH FACTORY-FURNISHED CLIPS. FINAL CONNECTION TO FIXTURE SHALL BE MADE WITH FLEXIBLE U.L. APPROVED ASSEMBLY.
- 40. NOT USED.

MANUFACTURER & CATALOG NUMBER

MOUNTING

- SEE DIVISION 15 DRAWINGS FOR LOCATION OF MECHANICAL EQUIPMENT. PROVIDE SERVICE TO AND CONNECT EQUIPMENT AS REQUIRED.
- 42. SWITCHBOARDS, (DISTRIBUTION BOARDS), PANELBOARDS, DISCONNECT SWITCHES, MOTOR CONTROL CENTERS, SHALL BE MANUFACTURED BY CUTLER HAMMER, GENERAL ELECTRIC, SIEMENS (ITE) OR SQUARE "D". BOLT FREE STANDING EQUIPMENT TO 4" HIGH CONCRETE HOUSEKEEPING PADS.
- 3. RECEPTACLE AND TELEPHONE OUTLETS AT COUNTER SHALL BE MOUNTED WITH THEIR LONG AXIS HORIZONTAL AT +42" UNLESS NOTED.
- 4. WIRING CIRCUITS TO OPEN OFFICE WORKSTATIONS SHALL HAVE A DEDICATED NEUTRAL FOR EACH CIRCUIT. SHARED NEUTRALS ARE NOT ALLOWED. COMPUTER CIRCUITS SHALL HAVE A DEDICATED NEUTRAL. A GREEN GROUND WIRE SHALL BE PROVIDED FOR EACH CIRCUIT.

THE GROUND CAN BE SHARED FOR MULTIPLE CIRCUITS (EXCEPT FOR IG CIRCUITS)

- 5. DRY TYPE TRANSFORMERS SHALL BE 150 DEGREES C RISE WITH 220 DEGREES C INSULATION. MOUNT ON RUBBER-IN-SHEAR ISOLATORS. MANUFACTURERS SHALL BE ASEA BROWN BOVERI, CUTLER HAMMER, GENERAL ELECTRIC, SIEMENS (ITE), OR SORREL (SQ. D).
- 6. PROVIDE ENGRAVED NAMEPLATES ON SWITCHBOARDS, PANELBOARDS DISCONNECT SWITCHES, MOTOR CONTROL CENTERS, TRANSFORMERS, ETC., INDICATING EQUIPMENT DESIGNATION (OR DESIGNATION OF EQUIPMENT SERVED) AND VOLTAGE.
- 7. PANEL DIRECTORIES SHALL BE REMOVABLE. SUBMIT PROPOSED SCHEDULE OF DIRECTORIES TO OWNER FOR APPROVAL. ROOM NAMES AND NUMBERS SHALL BE AS DIRECTED BY OWNER. DIRECTORIES SHALL BE TYPED AND INSTALLED UNDER CLEAR

- 48. DISCONNECT SWITCHES SHALL BE GENERAL DUTY TYPE. FUSIBLE SWITCHES SHALL ACCEPT CLASS "R" FUSES ONLY AND REJECT ALL OTHERS.
- 49 PROVIDE DYMO-TAPE TAG INSIDE COVER OF EACH FUSIBLE SWITCH, INDICATING SIZE AND TYPE OF FUSES PROVIDED.
- 50. PROVIDE TWO (2) SETS OF THREE (3) SPARE FUSES FOR EACH SIZE AND TYPE PROVIDED ON THIS PROJECT. INSTALL FUSES IN A HINGED DOOR, SHEET METAL STORAGE CABINET EQUIPPED WITH CLIPS OR CUBICLES, EACH MARKED WITH THE SIZE AND TYPE FUSE STORED THEREIN. PROVIDE NAMEPLATE "SPARE FUSES".

INSTALL IN LOCATIONS AS DIRECTED BY OWNER.

CONNECTORS SHALL BE INSULATED THROAT TYPE.

- 1. CIRCUIT BREAKERS SHALL BE BOLT-ON TYPE AND FUSES SHALL BE BUSSMANN OR
- 2. PROVIDE 4" HIGH CONCRETE EQUIPMENT PADS BENEATH SWITCHBOARDS, MOTOR CONTROL CENTERS, TRANSFORMERS, ETC., AND 8" HIGH CONCRETE EQUIPMENT AND BENEATH GENSET.
- 53. ALL WIRING SHALL BE INSTALLED IN LISTED METALLIC RACEWAYS. RACEWAYS IN SLAB-ON-GRADE OR BELOW GRADE SHALL BE SCHEDULE 40 PVC. TRANSITIONS FROM BELOW TO ABOVE GRADE SHALL BE WITH RIGID STEEL ELBOWS WITH P.V.C. JACKET OR APPROVED EQUIVALENT PROTECTION. MET FITTINGS SHALL BE MALLEABLE IRON OR STEEL.
- 54. NON-METALLIC AND FLEXIBLE CONDUITS SHALL HAVE A CODE SIZED COPPER
- GROUNDING CONDUCTOR. INCREASE CONDUIT SIZE AS REQUIRED. 55. FIRE ALARM, SOUND, TELEPHONE, COMPUTER, AND SIMILAR SYSTEMS CONDUITS
- LARGER THAN 1" SHALL HAVE LONG RADIUS SWEEPS (12 TIMES THE DIAMETER). 56. CONDUITS PENETRATING THRU ROOF SHALL HAVE FLASHING WITH CAULK TYPE
- COUNTER FLASHING SLEEVE. INSTALLATION SHALL BE WATERTIGHT. 57 FINAL CONNECTIONS TO MOTORS, TRANSFORMERS AND OTHER VIBRATING EQUIPMENT SHALL BE WITH SEAL TITE FLEX AND APPROVED FITTINGS. DO NOT SECURE CONDUITS, DISCONNECTS OR DEVICES TO DUCTWORK OR MECHANICAL
- R WHERE PANELS ARE INSTALLED FLUSH WITH WALLS, EMPTY CONDUITS SHALL BE EXTENDED FROM THE PANEL TO AN ACCESSIBLE SPACE ABOVE OR BELOW. A MINIMUM OF ONE 3/4"C. SHALL BE INSTALLED FOR EVERY THREE SINGLE POLE SPARE CIRCUIT BREAKERS OR SPACES, OR FRACTION THEREOF, BUT NOT LESS THAN TWO CONDUITS. FLUSH MOUNTED PANEL SHALL BE INSTALLED IN 6" WALLS. COORDINATE WITH GENERAL CONTRACTOR.
- 59. ALL ELECTRICAL SYSTEMS COMPONENTS SHALL BE LISTED OR LABELED BY U.L. OR OTHER RECOGNIZED TESTING FACILITIES
- O. WIRE TERMINATION PROVISIONS FOR PANELBOARDS, CIRCUIT BREAKERS, SAFETY SWITCHES, AND ALL OTHER ELECTRICAL APPARATUS SHALL BE LISTED AS SUITABLE FOR 75 DEGREE C.
- . ELECTRICAL CONTRACTOR SHALL PROVIDE CONTROLS, INTERLOCKS, ACCESSORIES, ETC., IN MOTOR CONTROL STARTERS AS REQUIRED BY THE TEMPERATURE CONTROL CONTRACTOR, STARTERS SHALL CONTAIN 120V CONTROL TRANSFORMER, PILOT LIGHT, AND PUSH BUTTONS OR SELECTOR SWITCH AS REQUIRED, IN ADDITION TO OTHER ITEMS (AUXILIARY CONTACTS, DOOR SWITCHES, RELAYS, ETC.) REQUIRED. SUBMIT ELEMENTARY CONTROL DIAGRAMS FOR APPROVAL. SUBMITTALS SHALL INCLUDE INDICATION OF PRIOR REVIEW AND ACCEPTANCE BY TEMPERATURE CONTROL CONTRACTOR. REFER TO DIV. 15 DRAWINGS AND TEMPERATURE CONTROL DIAGRAMS FOR ADDITIONAL CONDUIT, WIRE, RELAYS, TRANSFORMERS, CONNECTIONS, ETC. REQUIRED FOR A COMPLETE AND OPERABLE SYSTEM.
- 62. PROVIDE A GREEN GROUND CONDUCTOR IN ALL BRANCH CIRCUITS FEEDING OUTLETS IN MEDICAL EXAM ROOMS. 63. PROVIDE EXPANSION FITTINGS IN CONDUIT RUNS CROSSING STRUCTURAL EXPANSION
- 64. THE LIGHTING HAS BEEN DESIGNED IN ACCORDANCE OF THE STATE OF FLORIDA BUILDING CODE — ENERGY CONSERVATION, SECTION 505 AND 506.

JUNCTION BOX RECESS OR MOUNTED IN WALL.

J-BOX AND CONDUIT WITH CABLING CONTRACTOR.

J-BOX AND CONDUIT WITH CABLING CONTRACTOR.

TELEVISION OUTLET MOUNT 15" A.F.F. OR AS NOTED, PROVIDE CONDUIT IN WALL STUBBED UP 6" INTO CEILING CAVITY. COORDINATE EXACT SIZE OF

TELE/DATA OUTLET, MOUNT 15" A.F.F. OR AS NOTED, PROVIDE CONDUIT IN WALL STUBBED UP 6" INTO CEILING CAVITY. COORDINATE EXACT SIZE OF

THERMOSTAT LOCATION, MOUNT 54" A.F.F.

65. VOLTAGE DROP CALCULATIONS ON ALL FEEDERS AND BRANCH CIRCUITS HAVE BEEN PERFORMED IN ACCORDANCE WITH THE FLORIDA BUILDING CODE — ENERGY CONSERVATION, SECTION 505, 505.7.3. THE CONTRACTOR IS RESPONSIBLE TO BE FAMILIAR WITH SECTION 505 AND SHALL UPSIZE THE CONDUCTORS FOR FEEDER AND BRANCH CIRCUITS BASED ON THE ACTUAL ROUTING IN THE FIELD.

#### 66. ADDITIONAL NOTES FOR NEW PANELBOARDS:

INSIDE OF DOOR.

- A. PROVIDE LIGHTING AND RECEPTACLE PANELS AS INDICATED ON THE PLANS AND AS SPECIFIED HEREIN. ALL PANELS SHALL BE DEAD FRONT. CIRCUIT BREAKER TYPE, AND SHALL BEAR THE U.L. LABEL AS WELL AS MEET ALL APPLICABLE NEMA REQUIREMENTS.
- B. UNLESS OTHERWISE NOTED, TOP OF PANELS SHALL BE MOUNTED 6'-0"
- C. ALL PANELS SHALL HAVE TYPEWRITTEN CIRCUIT DIRECTORIES MOUNTED
- PANELS SHALL BE SUITABLE FOR THE SERVICE RATING AND THE A.I.C. RATING INDICATED ON THE PANEL SCHEDULES.
- E. ALL BREAKERS SHALL BE FULL SPACE, INDIVIDUAL FRAME TYPE, BOLT-ON E. TYPE. NO "PIGGY-BACK" OR TANDEM BREAKERS WILL BE PERMITTED CONTRACTOR SHALL PROVIDE ON ALL FLUSH (RECESSED) MOUNTED PANELS
- TWO (2), SPARE 2" CONDUITS STUBBED INTO THE CEILING SPACE. G. ALL CURRENT CARRYING BUS BARS SHALL BE COPPER.

#### 67. ADDITIONAL NOTES FOR NEW LOAD CENTERS:

- A. PROVIDE LOAD CENTERS AS INDICATED ON THE PLANS AND AS SPECIFIED HEREIN. ALL LOAD CENTERS SHALL BE DEAD FRONT, CIRCUIT BREAKER TYPE AND SHALL BEAR THE U.L. LABEL AS WELL AS MEET ALL APPLICABLE NEMA REQUIREMENTS.
- B. UNLESS OTHERWISE NOTED, TOP OF LOAD CENTERS SHALL BE MOUNTED 6'-0" A.F.F.
- C. ALL LOAD CENTERS SHALL HAVE TYPEWRITTEN CIRCUIT
- DIRECTORIES MOUNTED INSIDE OF DOOR. D. LOAD CENTERS SHALL BE SUITABLE FOR THE SERVICE RATING
- AND THE A.I.C. RATING INDICATED ON THE PANEL SCHEDULES. E. ALL BREAKERS SHALL BE FULL SPACE, INDIVIDUAL FRAME TYPE. PLUG-IN TYPE. NO "PIGGY-BACK" OR TANDEM BREAKERS WILL
- BE PERMITTED. F. CONTRACTOR SHALL PROVIDE ON ALL FLUSH (RECESSED) MOUNTED PANELS TWO (2), SPARE 2" CONDUITS STUBBED INTO
- THE CEILING SPACE. G. ALL CURRENT CARRYING BUS BARS SHALL BE COPPER.

Architecture, Planning, Interiors, & Sustainable Design

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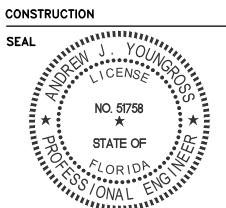
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ISSUED FOR: SPRAB

02/13/2015 06/25/2015

06/25/2015

PERMIT



PROJECT TITLE

Art Warehouse

313 NE 3rd Street

Delray Bch, Florida, 33444 REVISIONS

NUM. DESCRIPTION DATE 1 Bldg. Dept. comments 08.21.1

THESE DRAWINGS ARE PREPARED PER ESTABLISHED INDUSTRY STANDARDS AND REPRESENT THE ARCHITECT AND ENGINEERS DESIGN CONCEPT. THEY ARE NOT INTENDED TO PROVIDE EVERY DETAIL OR CONDITION REQUIRED TO CONSTRUCT THE BUILDING. THE CONTRACTOR THROUGH SUBMITTALS AND OTHER COORDINATION EFFORTS IS FULLY RESPONSIBLE FOR PROVIDING A COMPLETE AND OPERATIONAL BUILDING WHETHER INDICATED ON THE PLANS OR NOT.

15009 E DRAWING TITLE

FILE NUMBER

**L** ELECTRICAL O & LUMINAIRE LIST

0 06/25/2015 AA/MT/HI

JOB NUMBER 100701/15009 DRAWING NUMBER

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				I NO.	DESIGNATION			
	A	120	6"Ø DOWN LIGHT — DAMP LISTED	1	LED - 30 WATT 2545 LUMEN	RECESSED	CREE KR6-30L-35k/SSGC-WF	
	В	120	ELEVATOR PIT LIGHT	1	LED — CIVILIGHT DA19—10w	SURFACE	ANP VTW100GL-GUP100WG	
	С	120	24"x48" DIRECT/INDIRECT TROFFER	1	LED - 44 WATT 4000 LUMEN	RECESSED	CREE ZR24-40L-35k-10v	
	D	120	24"x24" DIRECT/INDIRECT TROFFER	1	LED - 32 WATT 3500 LUMEN	RECESSED	CREE ZR22-32L-35k-10v	
	FA	120	SINGLE CIRCUIT TRACK		N/A	SURFACE	JESCO HTR-4/8-WH / HXJ / CABLE MTD.	
	FB	120	SINGLE CIRCUIT TRACK HEAD	1	LED — CIVILIGHT WH150L23	SURFACE	JESCO H-HV238-BK	
	G	120	16"Ø HIGH BAY	1	LED - 44 WATT 4000 LUMEN	PENDANT	CREE CXBW16-CXBA-HC-M-40K-UL-10v	
	Н	120	48" LINEAR STRIP	1	LED — 44 WATT 4000 LUMEN 90LPW	SURFACE	CREE LS4-40L-35K-10v-ACS-18-5-4B-Q148-JB	
	κ	120	48" UTILITY WRAPAROUND	1	LED - 57 WATT 5400 LUMEN	SURFACE	TEXAS FLUORESCENT ECW-A-48L-S57W5400L-DMV-35K	
	L	120	DECORATIVE WALL SCONCE	1	LED - CIVILIGHT DA19-10w	SURFACE	ANP BRU-14E33UT14	
	М	120	48" STAIRWELL FIXTURE	1	LED - 40 WATT 4000 LUMEN	SURFACE	TERRALUX TLF-SL48A-A4040-OC-BB	OCCUPANCY SENSOR 1400 LUMEN OUTPUT EMERGENCY BATTERY
	SA	120	AREA LUMINAIRE — TYPE 3 MEDIUM	1	LED — 66 WATT	POLE	CREE ARE-EDG-3M-**-04-D-UL-525-40K	
	SB	120	AREA LUMINAIRE — TYPE 2 MEDIUM	1	LED — 67 WATT	POLE	CREE ARE-EDG-2MB-**-06-D-UL-350-40K	
$\sim$	SC	120	AREA LUMINAIRE - TYPE 4 MEDIUM	1	LED - 42 WATT	SURFACE	CREE XSPW-A-3M-C-U-XX	
$\left\{ \bigwedge_{1}^{1}\right\}$	SD	120	48" LED WALL WASH ACCENT	1	LED — 70 WATT	SURFACE		PROVIDE JUMPER AND LEADER CABLES AS REQUIRED FOR INTERCONNECTS.
	$\otimes$	120	THERMOPLASTIC (L.E.D. EXIT SIGN WITH GREEN LETTERS		INCLUDED	UNIVERSAL		GREEN LETIERS  90 MIN BATTERY INTEGRAL TEST SWITCH ISELF-DIAGNOSTIC
	488	120	COMBO THERMOPLASTIC L.E.D. EXIT SIGN AND EMERGENCY LIGHT WITH GREEN LETTERS		INCLUDED	UNIVERSAL	EELP XC-LED-2G-W-HO	GREEN LETTERS 90 MIN BATTERY INTEGRAL TEST SWITCH ISELF-DIAGNOSTIC
	<b>4-4</b>	120	EMERGENCY LIGHT		INCLUDED	UNIVERSAL	EELP EM16-E-E-LP-12v-50WH	90 MIN BATTERY INTEGRAL TEST SWITCH SELF-DIAGNOSTIC
				LU	MINAIRE L	IST NO	TES	

THE ABOVE FIXTURE SCHEDULE IS PREDICATED ON PERFORMANCE AND IS ALSO DESIGNED TO MEET CERTAIN AESTHETIC CRITERIA. ALL ALTRNATIVE SELECTIONS MUST BE SUBMITTED FOR PRIOR APPROVAL TO THE ARCHITECT AND ENGINEER TEN (10) PRIOR TO BID DATE. MANUFACTURERS NOT LISTED ON THE PLANS OR IN AN ADDENDUM WILL NOT BE ACCEPTED. SAMPLES WILL BE PROVIDED AT THE ARCHITECTS AND ENGINEER REQUEST FOR REVIEW OF EQUALITY. OCCUPANCY SENSORS SHALL HAVE PASSIVE INFRARED AND MICRPHONIC DUAL TECHNOLOGY.

	ELECTRICAL	SYMBOL	LIST
\$3	WALL SWITCH - 3 WAY - 125V - 20 AMP, MOUNT 46" A.F.F. OR AS NOTED		PANELBOARD
\$4	WALL SWITCH - 4 WAY - 125V - 20 AMP, MOUNT 46" A.F.F. OR AS NOTED		DISTRIBUTION PANEL
\$ <sub>D</sub>	DIMMER SWITCH - 125V - 1000W - 20 AMP, MOUNT 46" A.F.F. OR AS NOTED	3P NF 1	NON-FUSED DISCONNECT SWITCH.
\$м	MOTOR RATED "SNAP" SWITCH - 125V - 20 AMP, MOUNT AS NOTED	3P <del>20</del> ₩	FLICED DISCONNECT CHATCH OR CIDOLIT DREAKED ENGLOCUES
\$ <sub>TD</sub>	TIME DELAY WALL SWITCH — 1 POLE — 125V — 20 AMP. MOUNT 46" A.F.F. GREENHECK MODEL "GTD" OR EQUAL.		FUSED DISCONNECT SWITCH OR CIRCUIT BREAKER ENCLOSURE.
	LINE VOLTAGE OCCUPANCY SENSOR SWITCH - 120V-800W-6.7 AMP,	W.P.	WEATHERPROOF
OS	WALL MOUNTED, 46" A.F.F. OR AS NOTED. DUAL TECHNOLOGY	Ем.	EMERGENCY
<b>(S)</b>	LINE VOLTAGE OCCUPANCY SENSOR SWITCH - 125V-800W-6 AMP, CEILING MOUNTED OR AS NOTED. DUAL TECHNOLOGY	ЕОН ——	ELECTRICAL OVERHEAD SERVICE LINE
<b>(0S)</b>	LINE VOLTAGE OCCUPANCY SENSOR SWITCH — 125V—800W—6 AMP, LUMINAIRE MOUNTED OR AS NOTED. DUAL TECHNOLOGY	EUG	ELECTRICAL UNDERGROUND SERVICE LINE
_		TELE	TELEPHONE SERVICE CONDUIT
0-	SINGLE RECEPTACLE - 125V - 20 AMP - NEMA 5-20R, MOUNT 15" A.F.F. (STANDARD), 42" A.F.F. © COUNTERTOPS OR AS NOTED	<b>│                                    </b>	TELE-DATA SERVICE CONDUIT
<b>=</b>	DUPLEX RECEPTACLE - 125V - 20 AMP - NEMA 5-20R, MOUNT 15" A.F.F. (STANDARD), 42" A.F.F. © COUNTERTOPS OR AS NOTED	ELEC	ELECTRICAL CONDUIT
GFCI	DUPLEX RECEPTACLE ON GROUND FAULT INTERRUPTER CIRCUIT. 125V — 20 AMP — NEMA 5—20R		ELECTRICAL CONDUIT CONCEALED IN WALLS OR IN CONCRETE
0-			ELECTRICAL CONDUIT UNDERGROUND
<b>=</b>	DUPLEX RECEPTACLE WITH SPLIT BUS — TOP HALF ON SWITCH CONTROL 125V — 20 AMP — NEMA 5—20R	\\\-\-\\\\\\\\\\\\\\\\\\\\\\\\\\\\\\\\	ELECTRICAL CONTROL WIRING
<b>#</b>	DUPLEX RECEPTACLE WITH SPLIT BUS — TWO CIRCUIT WIRING. 125V — 20 AMP — NEMA 5—20R	The state of the s	ELECTRICAL WIRE HOME—RUN, 1ST HASH MARK REPRESENTS THE HOT, SECOND HASH MARK WITH A DOT REPRESENTS THE NEUTRAL, ARC WIRE MARK REPRESENTS THE GROUND
<b>⊕</b> -	QUAD RECEPTACLE — 125V — 20 AMP — NEMA 5—20R, MOUNT 15" A.F.F. (STANDARD), 42" A.F.F. @ COUNTERTOPS OR AS NOTED	unc d	ELECTRICAL WIRE HOME—RUN, HASH MARK'S WITHOUT A DOT REPRESENTS THE NUMBER OF HOT'S, HASH MARK WITH A DOT REPRESENTS THE NEUTRAL, ARC WIRE MARK REPRESENTS
<b>O</b> -	SINGLE RECEPTACLE - 125/250V - 30 AMP - NEMA 10-30R, MOUNT 15" A.F.F. (STANDARD) OR AS NOTED	THIC THE	THE GROUND
<b>O</b> -	SINGLE RECEPTACLE — 125/250V — 50 AMP — NEMA 10—50R, MOUNT 15" A.F.F. (STANDARD) OR AS NOTED		
•	JUNCTION BOX RECESSED IN FLOOR.		
0	JUNCTION BOX MOUNTED ABOVE CEILING.		

**ELECTRICAL DRAWING LIST** 

E-0.1 | ELECTRICAL NOTES, LEGEND, AND LUMINAIRE LIST E-1.1 FIRST FLOOR ELECTRICAL PLAN E-1.2 | SECOND FLOOR ELECTRICAL PLAN E-2.1 FIRST FLOOR LIGHTING PLAN E-2.2 SECOND FLOOR LIGHTING PLAN E-3.1 RISER DIAGRAMS AND PANEL SCHEDULES


E-4.1 ELECTRICAL DETAILS

ELECTRICAL THOMPSON & YOUNGROSS ENGINEERING CONSULTANTS, LLC

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## PLAN KEY NOTES

- 2 SETS OF 3" E.C. WITH (4)-500KCM (CU) TO FPL TRANSFORMER. CONFIRM LOCATION AND CONNECTION WITH FPL REP., SEE RISER DIAGRAM.
- FPL APPROVED METER CAN AND FPL METER, SEE RISER
- FPL APPROVED C/T CABINET, SEE RISER DIAGRAM.
- GROUND LUGS, SEE RISER DIAGRAM.
- PROVIDE (2)-3" E.C. WITH 200 LB TEST PULL STRING TO UTILITY POLE FOR TELE / DATA / TV SERVICE.
- CONTINUE (2)-3" E.C. TO MAIN ELECTRICAL ROOM. TERMINATE A TELE / DATA / TV BACKBOARD. SEE RISER DIAGRAM AND BACKBOARD DETAIL.
- PROVIDE (6) 2" CONDUITS FROM BACKBOARD AND STUBBED INTO ADJACENT AREAS FOR TELE / DATA / TV CABLING ACCESS. SEE DETAILS.
- PROVIDE A 2P-60AMP-240V-N/F DISCONNECT, MOUNTED ADJACENT TO THE INSTANTANEOUS WATER HEATER. SEE PANEL SCHEDULE FOR CIRCUITING INFORMATION.
- CIRCUIT BREAKERS IN PANEL TO SERVE AS HVAC EQUIPMENT MEANS OF DISCONNECT.
- COORDINATE ELEVATOR POWER REQUIREMENTS WITH ELEVATOR SHOP DRAWINGS. PROVIDE A 3P-240V-200A FUSED DISCONNECT AND PROVIDE FUSES AS PER EQUIPMENT NAMEPLATE RATING.
- COORDINATE HAND DRYER REQUIREMENTS WITH ARCHITECT'S SPECIFICATION AND SHOP DRAWINGS. PROVIDE A JUNCTION
  BOX AT THE HEIGHT REQUIRED BY SAID SPECIFICATION AND
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  CONSTRUCTION
  SEAL

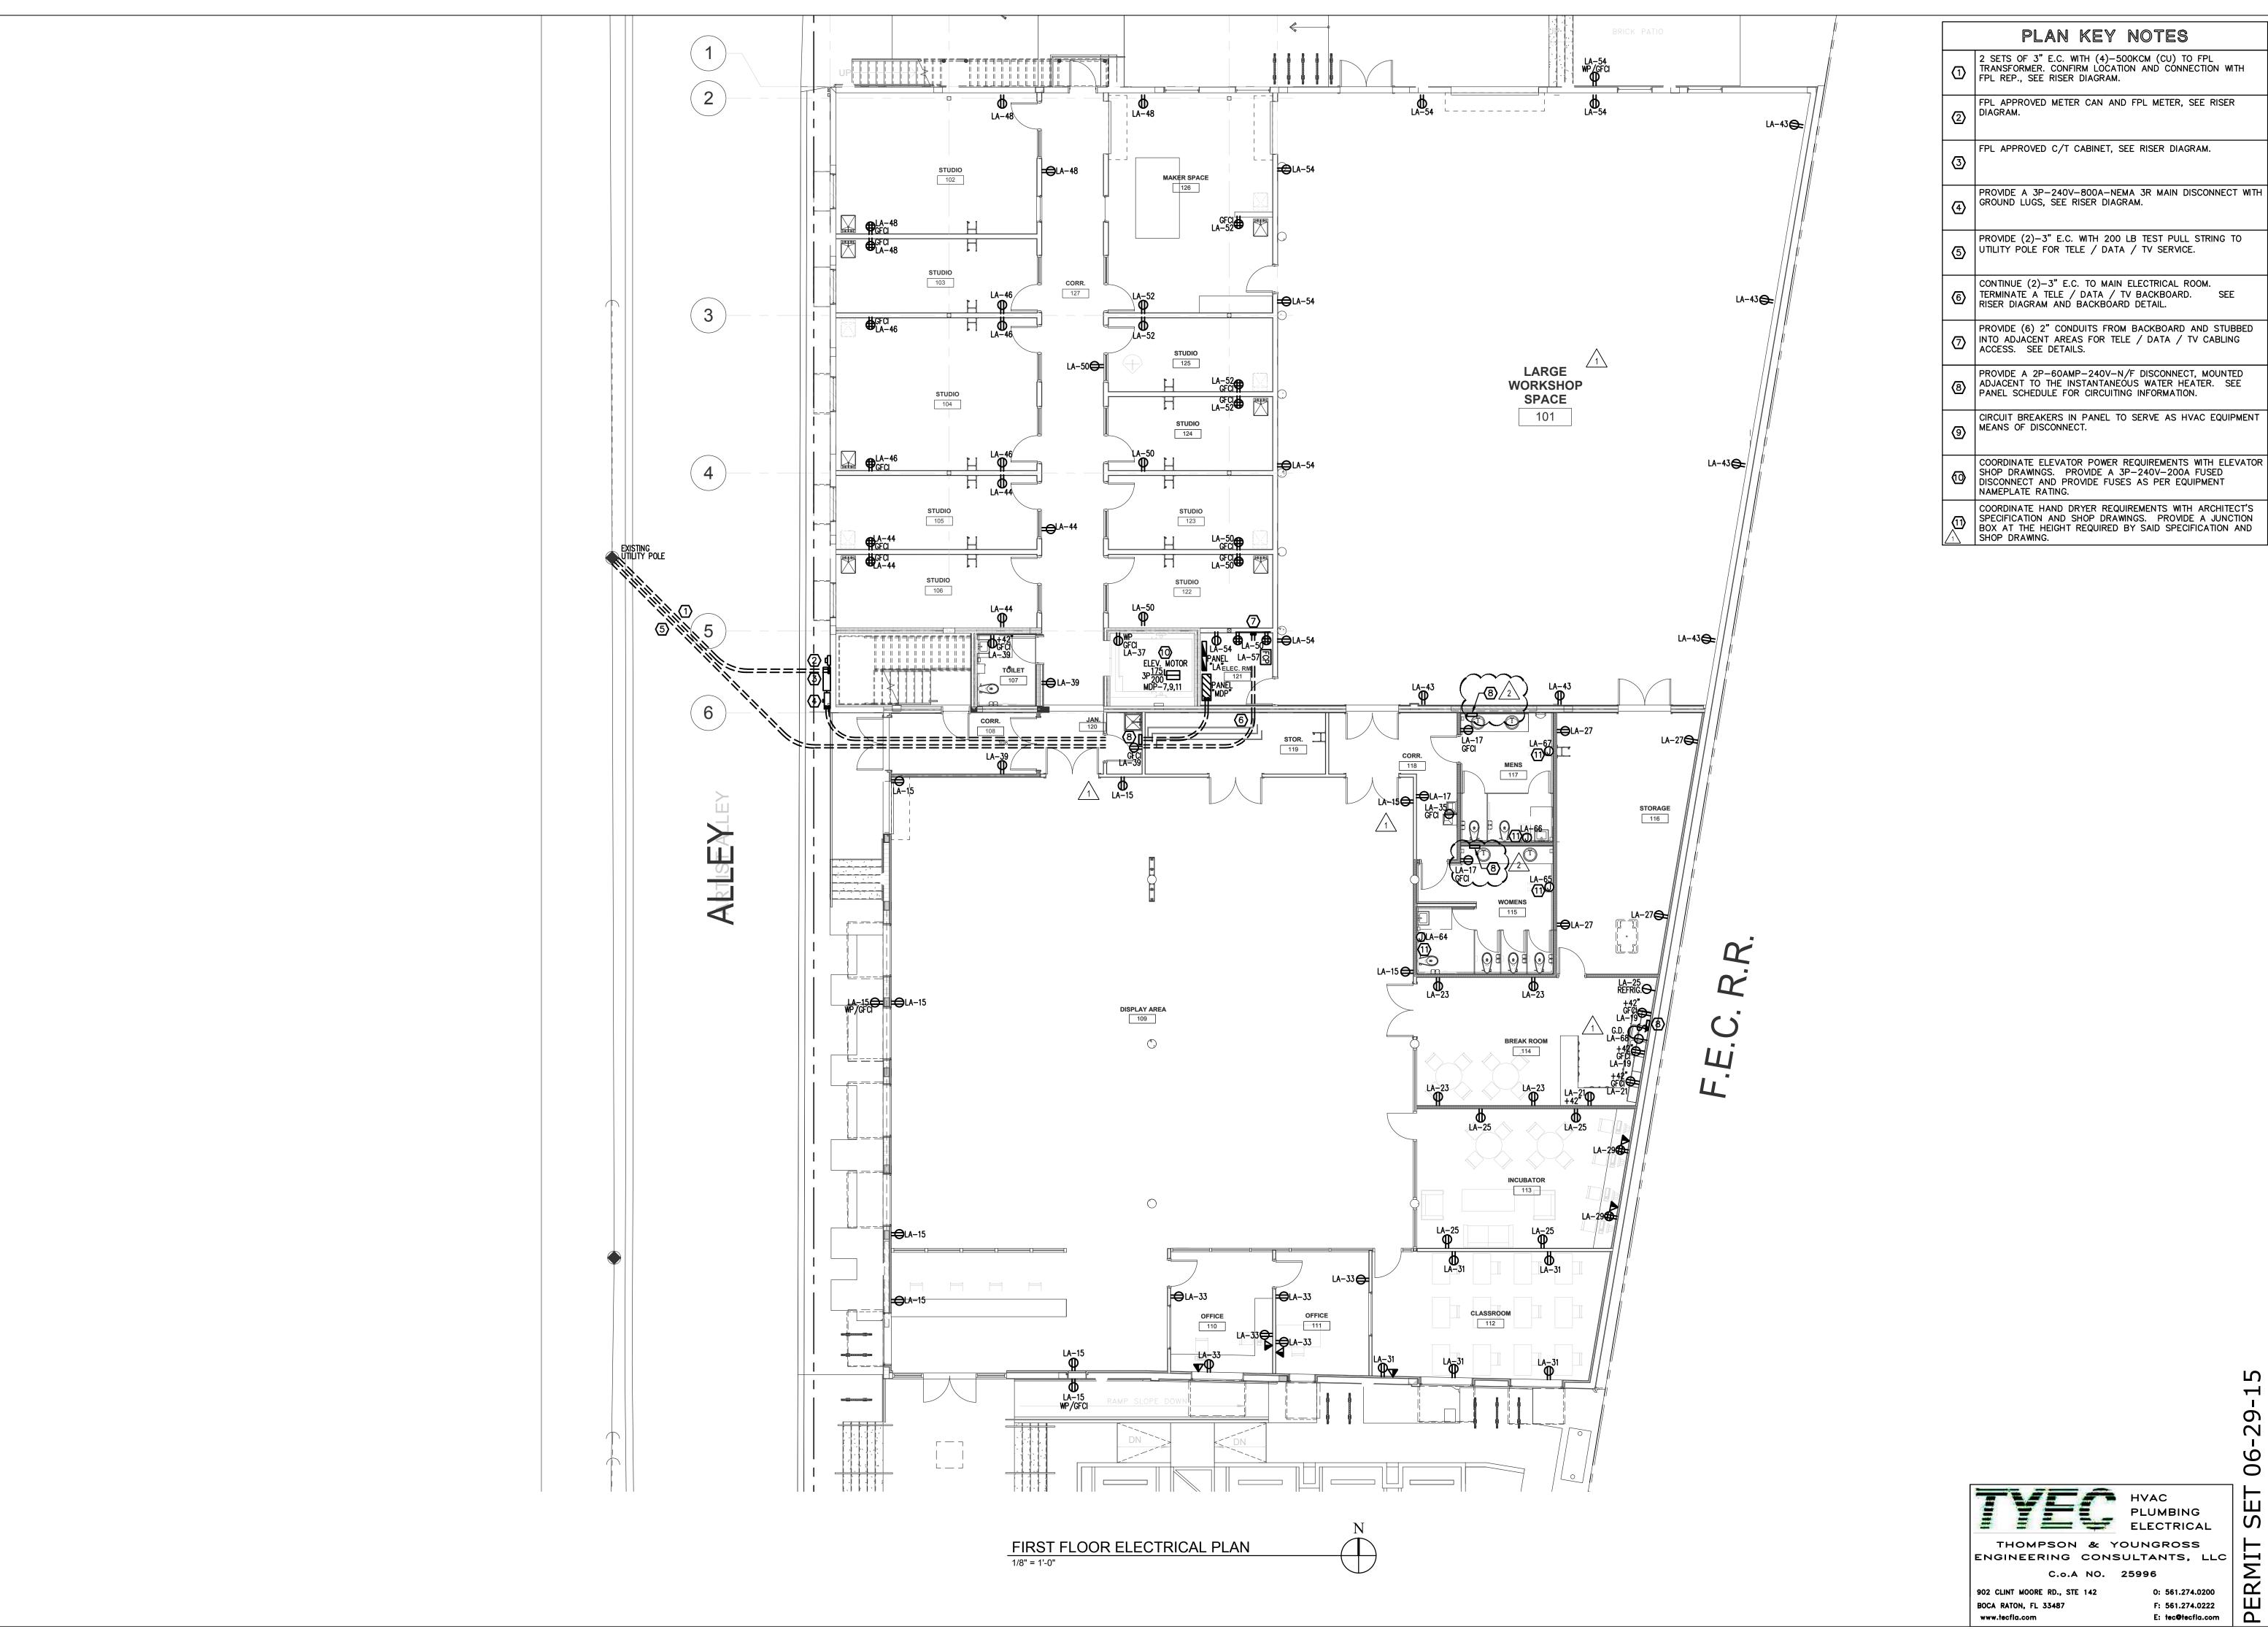


## **CURRIE SOWARDS AGUILA** architects

Architecture, Planning, Interiors, & Sustainable Design AA26001584

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06/25/2015 06/25/2015



PROJECT TITLE

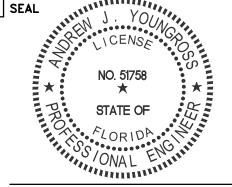Art Warehouse

313 NE 3rd Street Delray Bch, Florida, 33444

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REVIS	IONS	
NUM.	DESCRIPTION	DATE
1	Bldg. Dept. comments	08.21.15
2	Bldg. Dept. comments	10.26.15

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15009\_E DRAWING TITLE FIRST FLOOR


ტ PLAN

0 DATE 06/25/2015 AA/MT/HL

JOB NUMBER

DRAWING NUMBER

0: 561.274.0200 F: 561.274.0222 E: tec@tecfla.com

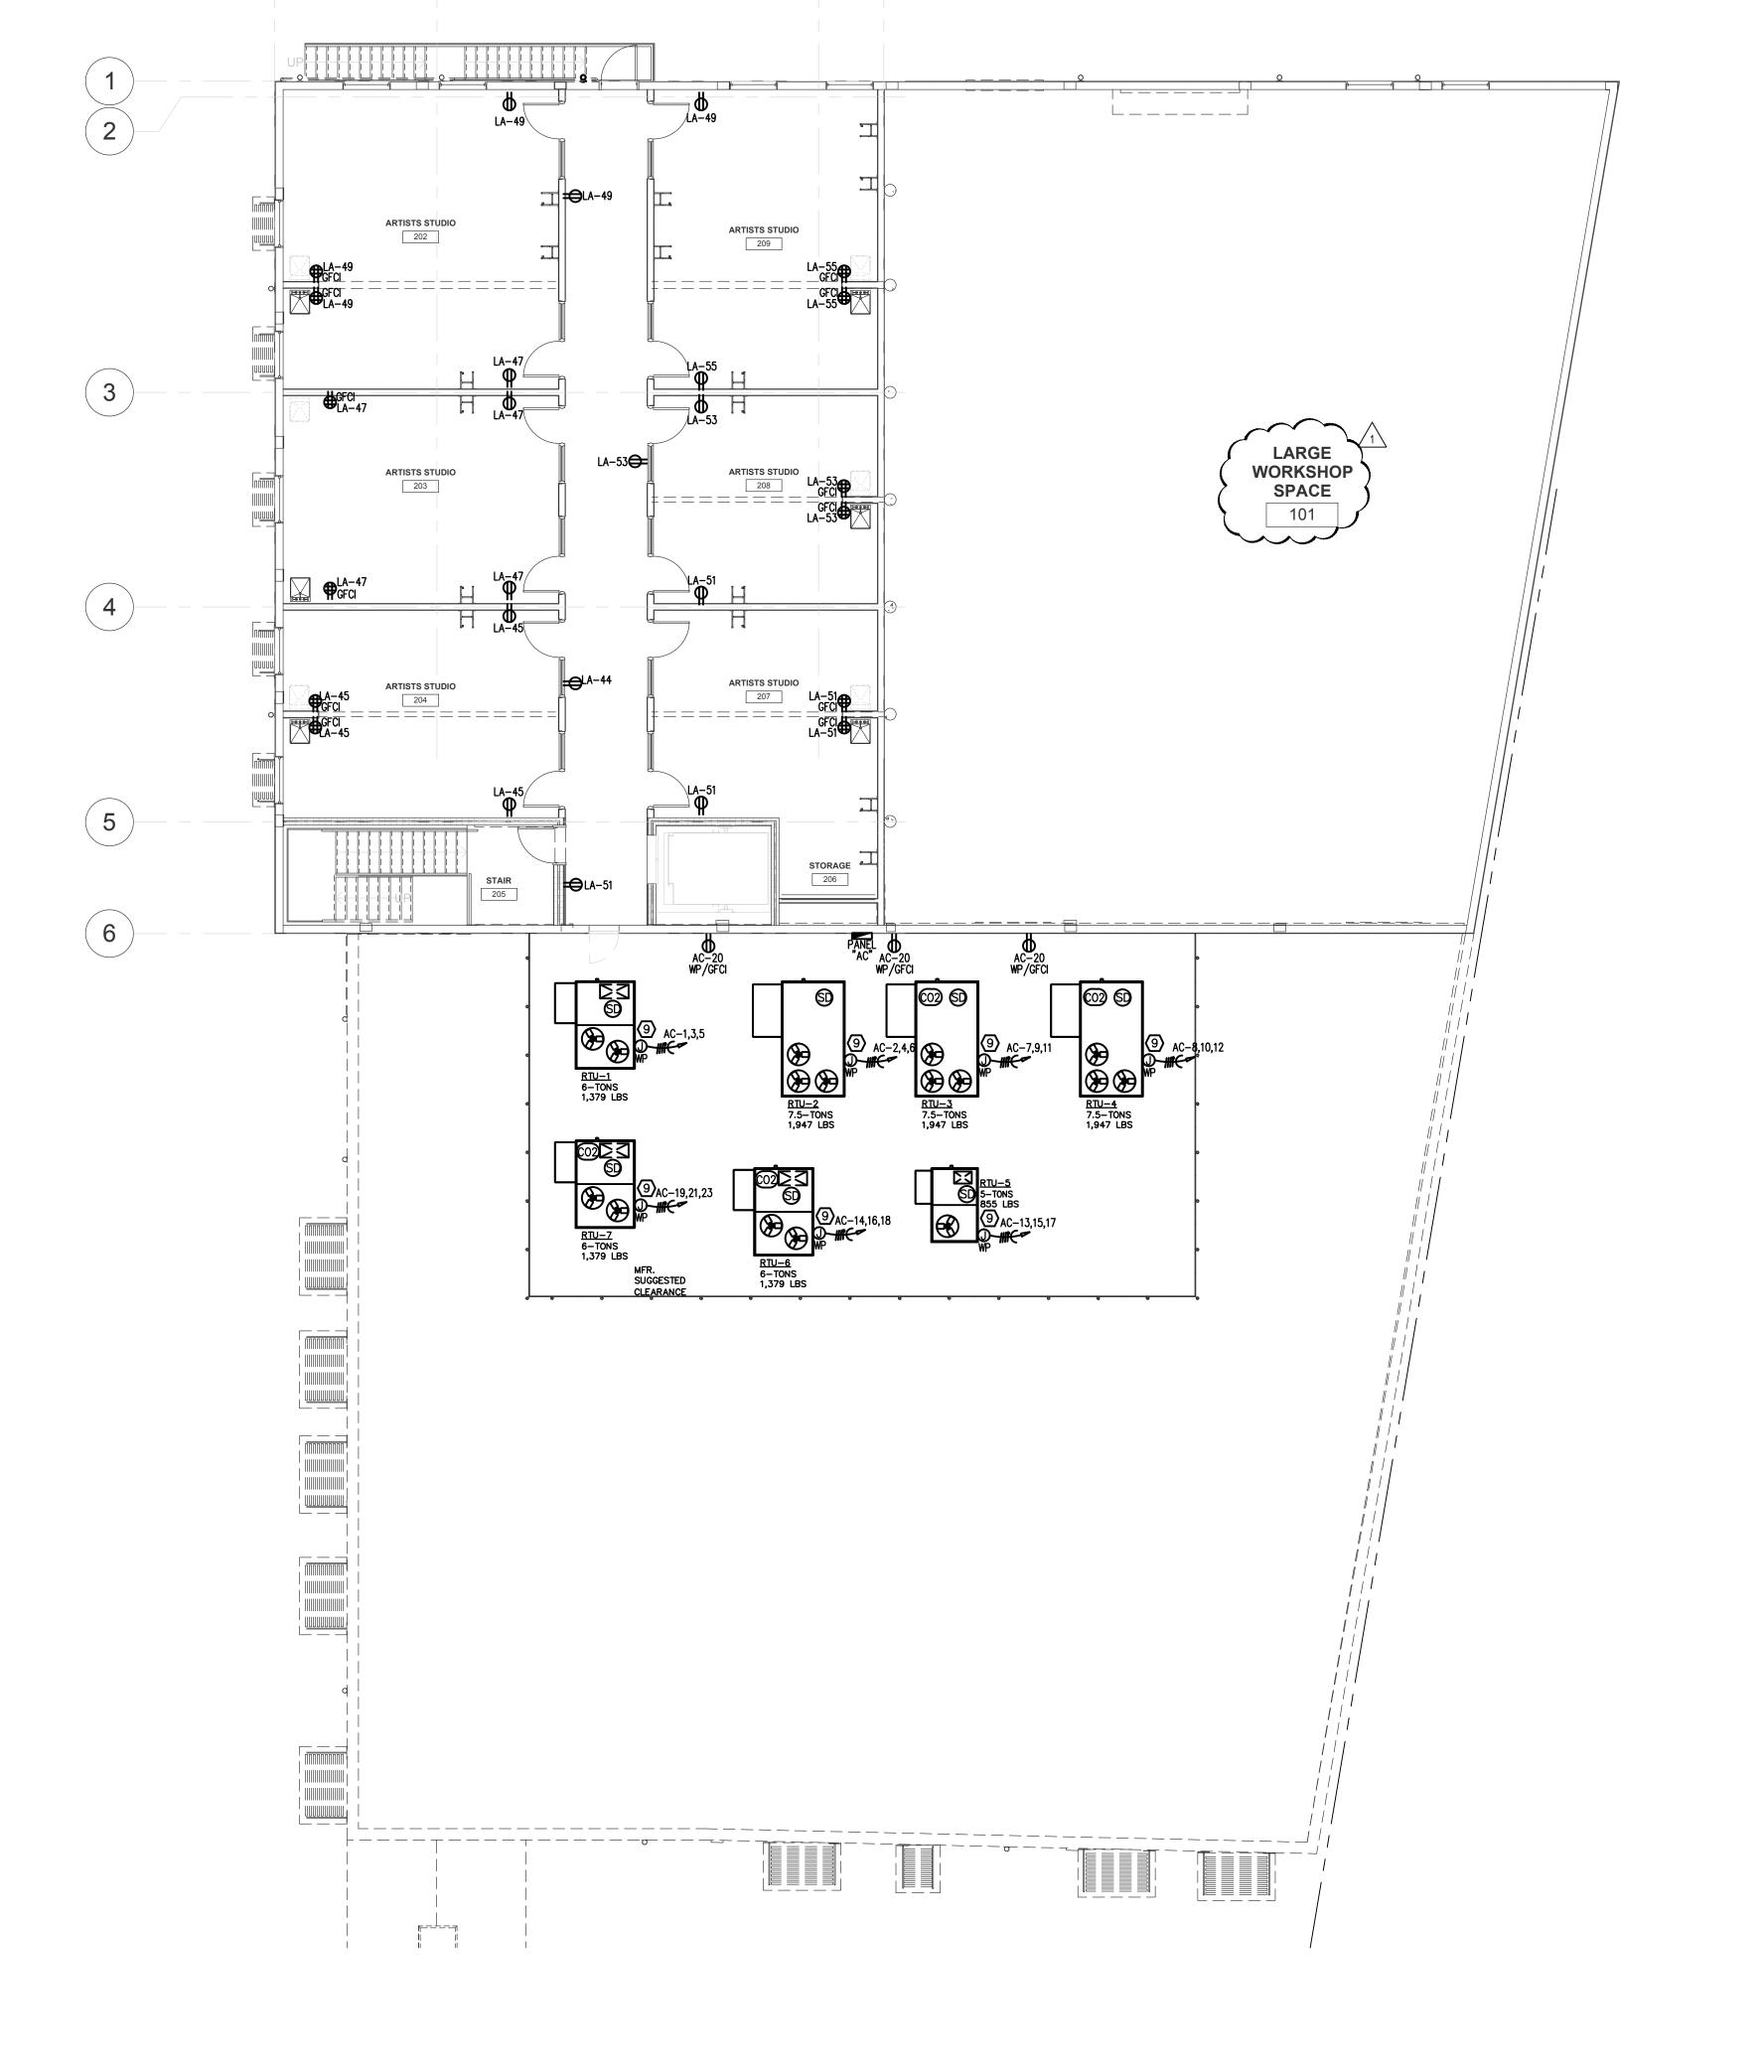




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- FPL APPROVED C/T CABINET, SEE RISER DIAGRAM.
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GROUND LUGS, SEE RISER DIAGRAM.

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  CONSTRUCTION

  SEAL



# **CURRIE SOWARDS AGUILA**

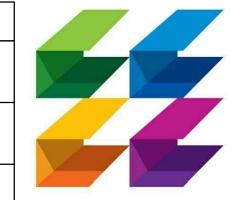architects


Sustainable Design AA26001584 185 NE 4TH AVENUE SUITE 101

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DELRAY BEACH, FL 33483 T:(561) 276-4951 F:(561) 243-8184 E-MAIL: office@csa-architects.com

ISSUED FOR :

02/13/2015 06/25/2015 06/25/2015

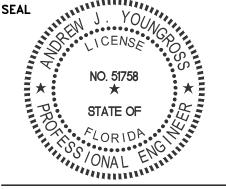

PROJECT TITLE Art Warehouse

313 NE 3rd Street Delray Bch, Florida, 33444

REVISIONS

NUM. DESCRIPTION DATE
1 Bldg. Dept. comments 08.21.15

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- ELECTRICAL ი PLAN

0 DATE 06/25/2015 AA/MT/HI JOB NUMBER


LLC DRAWING NUMBER

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**CURRIE SOWARDS AGUILA** architects

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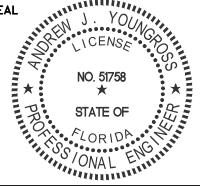
185 NE 4TH AVENUE SUITE 101 DELRAY BEACH, FL 33483

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02/13/2015 06/25/2015

06/25/2015

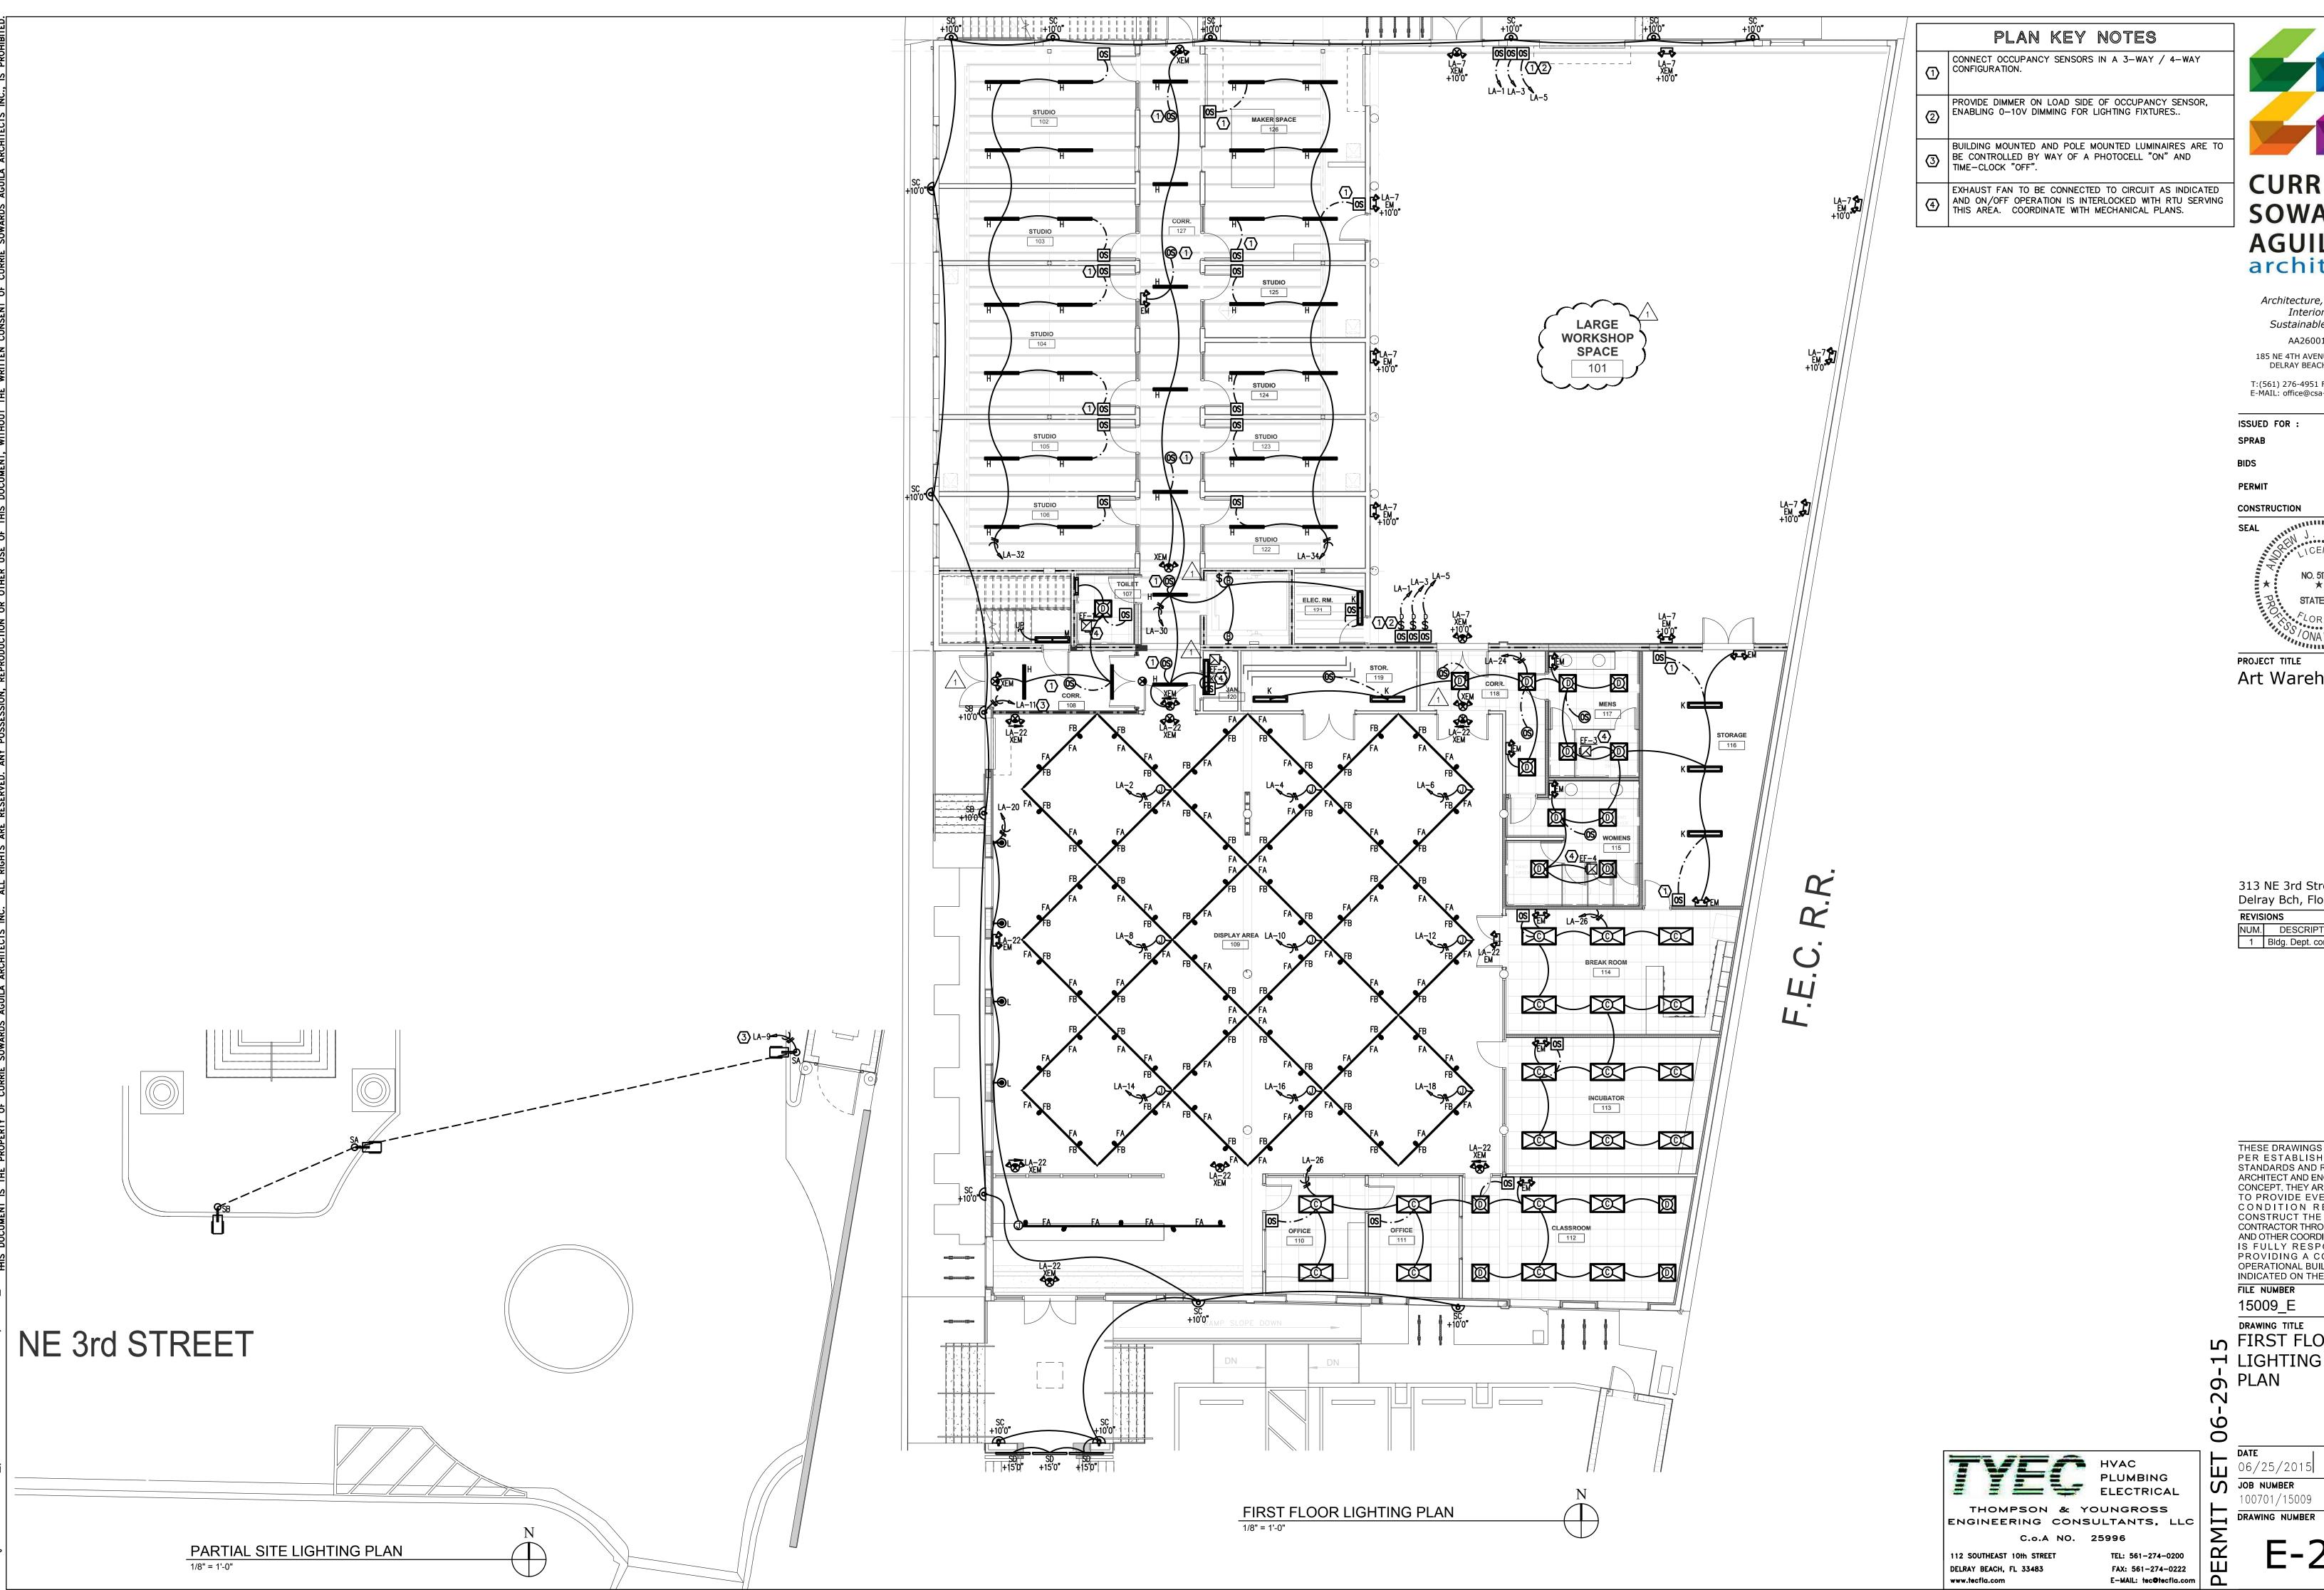CONSTRUCTION



Art Warehouse

313 NE 3rd Street

Delray Bch, Florida, 33444


NUM. DESCRIPTION DATE
1 Bldg. Dept. comments 08.21.15

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☐ FIRST FLOOR

□ LIGHTING

AA/MT/HL

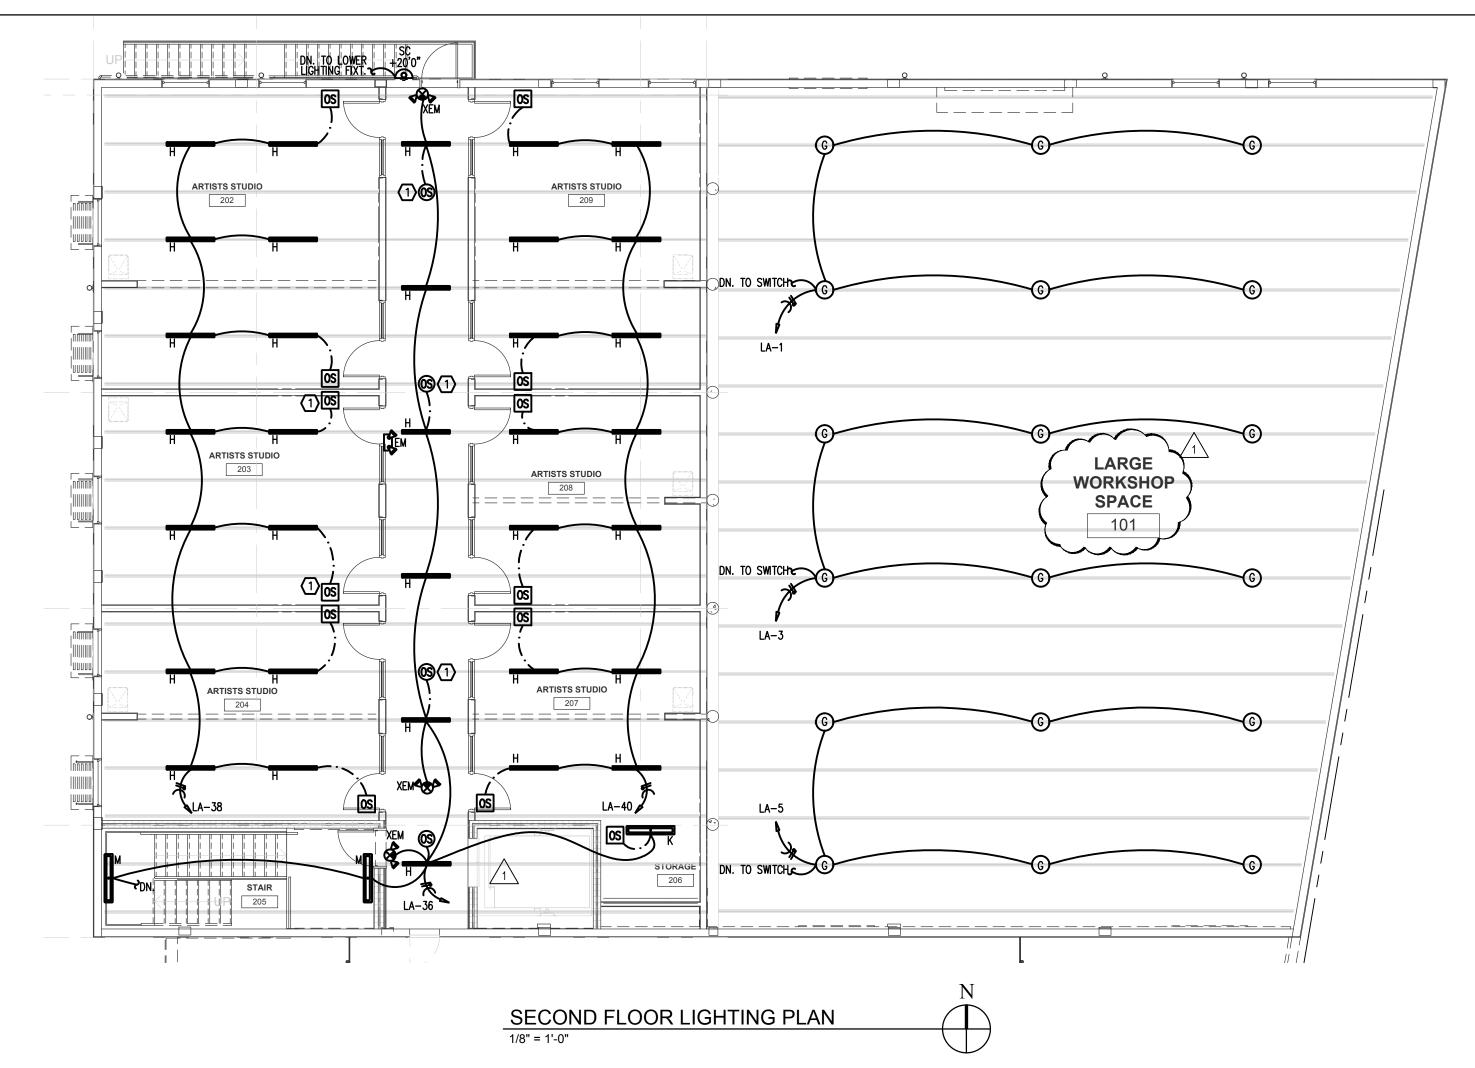

## PLAN KEY NOTES

- CONNECT OCCUPANCY SENSORS IN A 3-WAY / 4-WAY CONFIGURATION.
- PROVIDE DIMMER ON LOAD SIDE OF OCCUPANCY SENSOR, ENABLING 0-10V DIMMING FOR LIGHTING FIXTURES..
- BUILDING MOUNTED AND POLE MOUNTED LUMINAIRES ARE TO BE CONTROLLED BY WAY OF A PHOTOCELL "ON" AND TIME\_CLOCK "OFF" TIME-CLOCK "OFF".
- EXHAUST FAN TO BE CONNECTED TO CIRCUIT AS INDICATED AND ON/OFF OPERATION IS INTERLOCKED WITH RTU SERVING THIS AREA. COORDINATE WITH MECHANICAL PLANS.



**CURRIE SOWARDS AGUILA** architects

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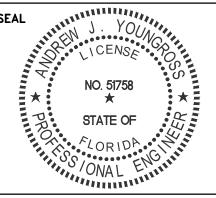
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CONSTRUCTION



PROJECT TITLE Art Warehouse

313 NE 3rd Street Delray Bch, Florida, 33444

REVISIONS

NUM. DESCRIPTION DATE
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15009\_E

DRAWING TITLE SECOND FLOOR - LIGHTING PLAN

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DATE DRAWN BY 06/25/2015 AA/MT/HL

JOB NUMBER


LLC DRAWING NUMBER

-: 561-274-0200
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THOMPSON & YOUNGROSS ENGINEERING CONSULTANTS, LLC

C.o.A NO. 25996 112 SOUTHEAST 10th STREET

DELRAY BEACH, FL 33483 www.tecfla.com

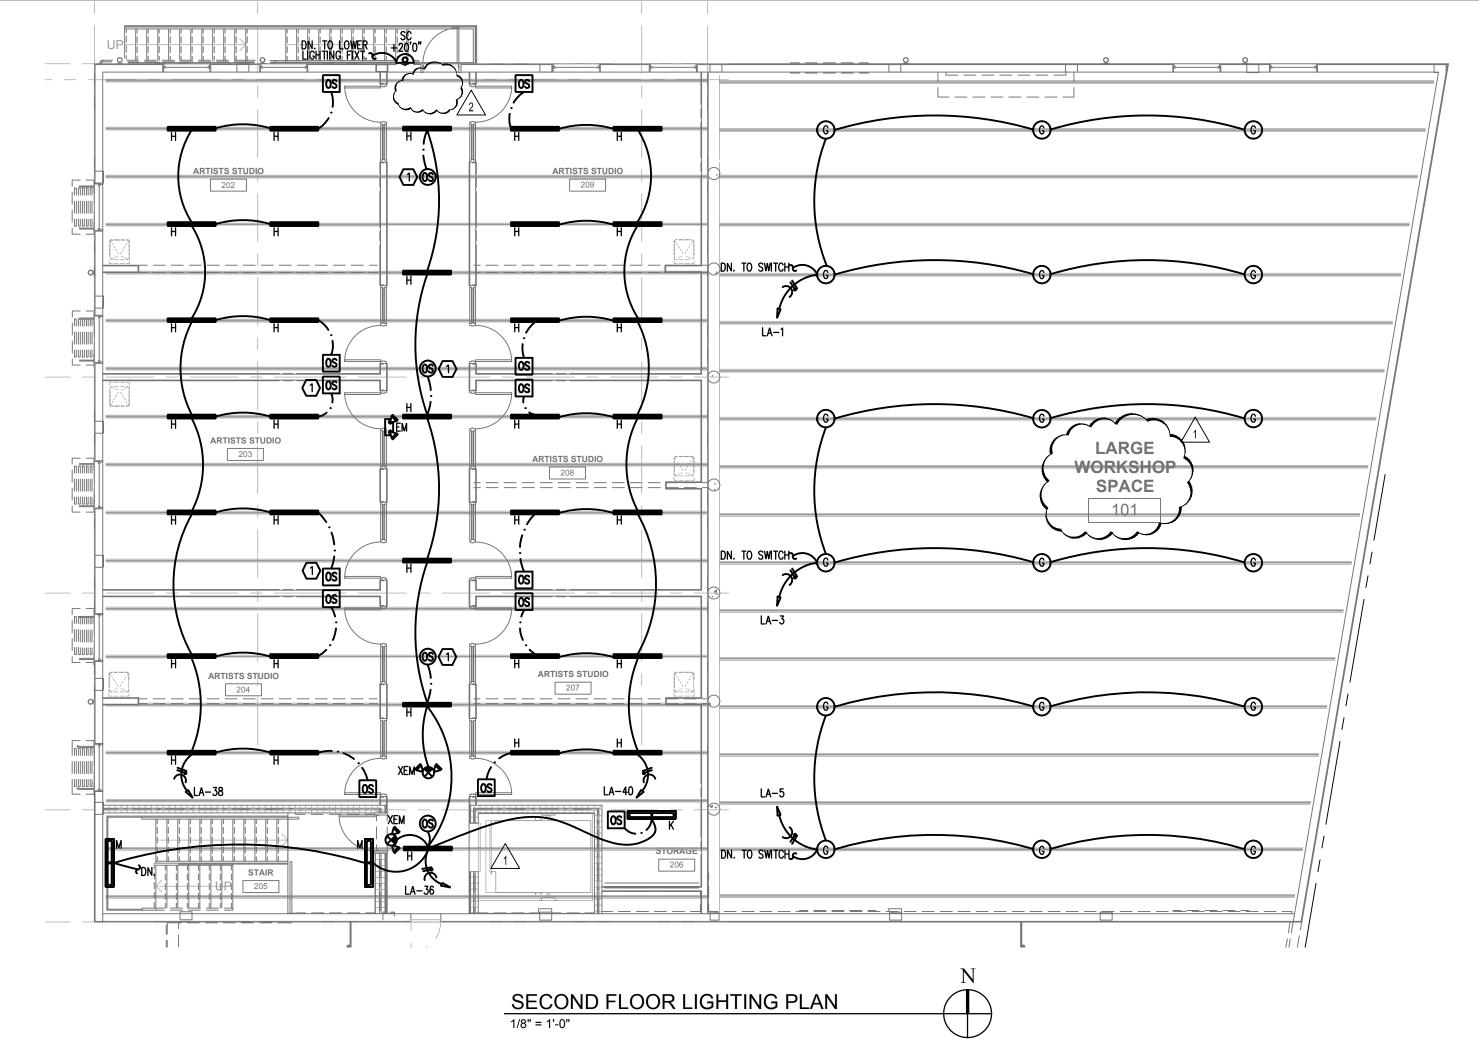

### PLAN KEY NOTES

- CONNECT OCCUPANCY SENSORS IN A 3-WAY / 4-WAY CONFIGURATION.
- PROVIDE DIMMER ON LOAD SIDE OF OCCUPANCY SENSOR, ENABLING 0-10V DIMMING FOR LIGHTING FIXTURES...
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**CURRIE SOWARDS AGUILA** architects

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Sustainable Design


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CONSTRUCTION



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313 NE 3rd Street Delray Bch, Florida, 33444

REVISIONS

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2 Bldg. Dept. comments 10.26.15
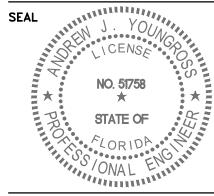
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15009\_E

DRAWING TITLE SECOND FLOOR H LIGHTING PLAN

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06/25/2015 AA/MT/HL

JOB NUMBER DRAWING NUMBER

HVAC PLUMBING ELECTRICAL THOMPSON & YOUNGROSS ENGINEERING CONSULTANTS, LLC

C.o.A NO. 25996


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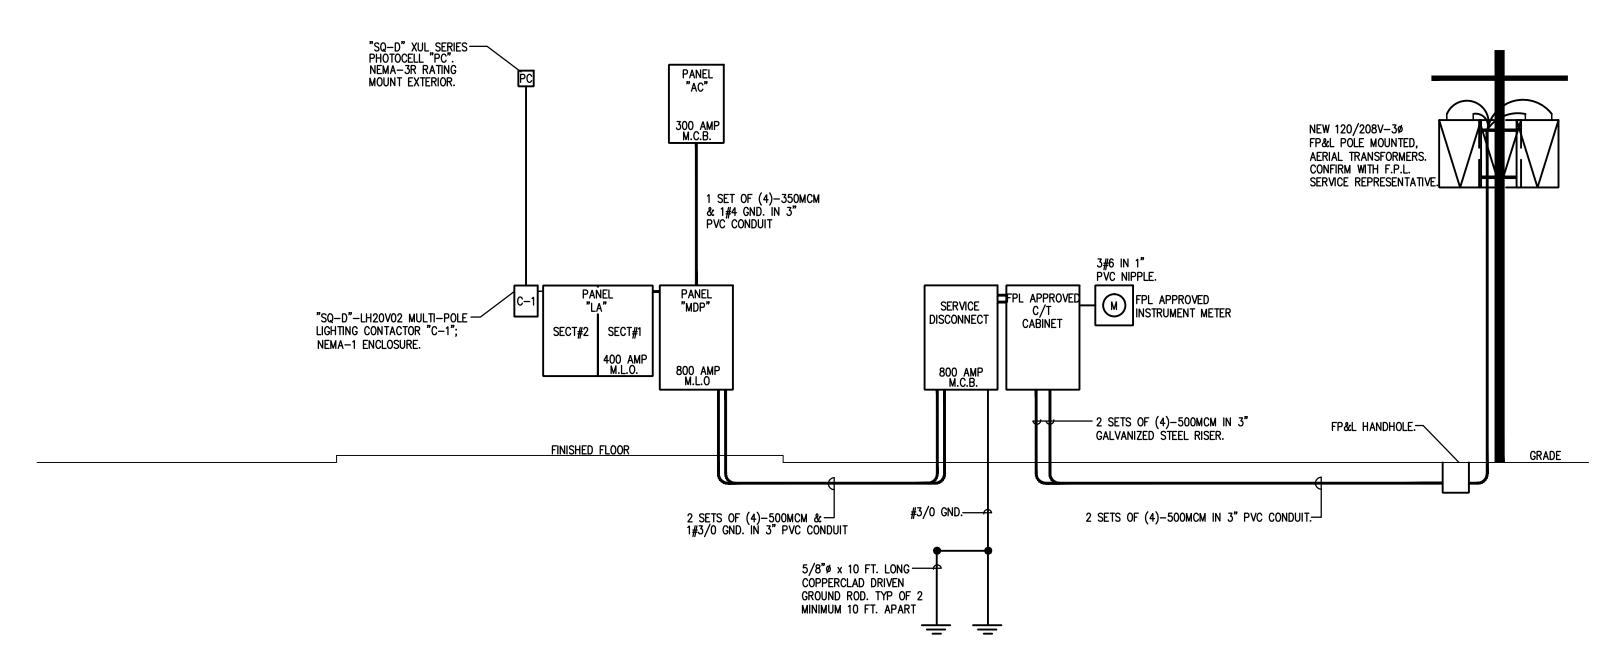
PERM] 0: 561.274.0200 F: 561.274.0222 E: tec@tecfla.com

			P/	ANE	LB	OAF	RD S	SCH	ED	ULE	"L	<u>4" -</u>	SE	CTIC	NC	#1				
В	US (KVA)	LOAD	WIRE	GND	COND	AMPS	POLE		В	US		POLE	AMPS	COND	GND	WIRE	LOAD	В	BUS (K\	VA)
Α	ВС	LOAD	VVIIXE	911	COND	Alvii S	IOLL		Α	в с		, oll	CIVII 3	COND	GILD	WINE	EOAD	Α	В	С
1.4		INTERIOR LIGHTING - MULTIPURPOSE RM	#12	#12	1/2"	20	1	1 =	•		2	1	20	1/2"	#12	#12	INTERIOR LIGHTING - TRACK	1.0		
	1.4	INTERIOR LIGHTING - MULTIPURPOSE RM	#12	#12	1/2"	20	1	3	┿	+	4	1	20	1/2"	#12	#12	INTERIOR LIGHTING - TRACK		1.0	
	1.4	INTERIOR LIGHTING - MULTIPURPOSE RM	#12	#12	1/2"	20	1	5 =		╅	6	1	20	1/2"	#12	#12	INTERIOR LIGHTING - TRACK			1.0
0.5		EM / EXIT LIGHTING - MULTIPURPOSE RM.	#12	#12	1/2"	20	1	7 =	1	╁	8	1	20	1/2"	#12	#12	INTERIOR LIGHTING - TRACK	1.0		
	0.3	EXTERIOR LIGHTING - POLE MTD.	#12	#12	1/2"	20	1	9 =	╁		10	1	20	1/2"	#12	#12	INTERIOR LIGHTING - TRACK		1.0	
	1.0	EXTERIOR LIGHTING - WALL MTD.	#12	#12	1/2"	20	1	11=	+	╬	12	1	20	1/2"	#12	#12	INTERIOR LIGHTING - TRACK			1.0
0.2		EXTERIOR LIGHTING - TIME CLOCK	#12	#12	1/2"	20	1	13		╫	14	1	20	1/2"	#12	#12	INTERIOR LIGHTING - TRACK	1.0		
	1.6	GENERAL RECEPTACLES - DISPLAYAREA	#12	#12	1/2"	20	1	15	+		16	1	20	1/2"	#12	#12	INTERIOR LIGHTING - TRACK		1.0	
	0.6	GENERAL RECEPTACLES - CORR. & R.R.	#12	#12	1/2"	20	1	17=	╫	╬	18	1	20	1/2"	#12	#12	INTERIOR LIGHTING - TRACK			1.0
1.0		APPLIANCE RECEPTACLES - BREAK RM	#12	#12	1/2"	20	1	19	+		20	1	20	1/2"	#12	#12	INTERIOR LIGHTING - TRACK & SCONCES	1.0		
	1.0	APPLIANCE RECEPTACLES - BREAK RM.	#12	#12	1/2"	20	1	21=	╁		<b>22</b>	1	20	1/2"	#12	#12	EM / EXIT LIGHTING - DISPLAY AREA		0.6	
	1.6	GENERAL RECEPT BRK. RM. & INCUB.	#12	#12	1/2"	20	1	23	╁	+	24	1	20	1/2"	#12	#12	INTERIOR LIGHTING - CORR. & R.R.			0.0
1.2		REFRIGERA TOR - BREAK RM.	#12	#12	1/2"	20	1	25	•	+	26	1	20	1/2"	#12	#12	INTERIOR LIGHTING - INCUB. & BRK.RM.	0.6		
	0.8	GENERAL RECEPTACLES - STORAGE	#12	#12	1/2"	20	1	27	╁	┡	28	1	20	1/2"	#12	#12	INTERIOR LIGHTING - OFFICES & CLASSRIM		0.6	
	1.8	COMPUTER RECEPTACLES - INCUBATOR	#12	#12	1/2"	20	1	29	╁	+	30	1	20	1/2"	#12	#12	INTERIOR LIGHTING - 1st FL. CORR.			1.0
1.0		GENERAL RECEPTACLES - CLASS RM.	#12	#12	1/2"	20	1	31	•	₩	32	1	20	1/2"	#12	#12	INTERIOR LIGHTING - 1st FL.STUDIOS	1.3		
	1.2	GERERAL RECETPACLES - OFFICES	#12	#12	1/2"	20	1	33	╁	+	34	1	20	1/2"	#12	#12	INTERIOR LIGHTING - 1st FL. STUDIOS		1.3	
	1.2	EWC - GPCI RECEPTACLES	#12	#12	1/2"	20	1	35	╁	╬	36	1	20	1/2"	#12	#12	INTERIOR LIGHTING - 2nd FL. CORR.			0.4
0.5		ELEVATOR PIT - RECEPTACLE & LIGHT	#12	#12	1/2"	20	1	37=	•	+	38	1	20	1/2"	#12	#12	INTERIOR LIGHTING - 2nd FL. STUDIOS	1.3		
	0.8	GENERAL RECEPTACLES - CORR., JAN.	#12	#12	1/2"	20	1	39	╁		40	1	20	1/2"	#12	#12	INTERIOR LIGHTING - 2nd FL. STUDIOS		1.3	
	1.6	SPARE				20	1	41=	+	•	42	1	20				SPARE			1.6
K۱	/A BUS A	13.0 KVA BUS B 13.9 KVA BUS C	16.0	KVA	ТО	TAL	42.8	KVA		AM	PS	BUS A	108.0	AMPS	BUS B	115.5	AMPS BUSC 133.2 AMPS TOTAL	119	AMP	S
RATE	VOLTAGE:	<b>☑</b> 120/208	3-PHAS	SE, 4-V	VIRE						В	RANCH	POLE	S:	<u> </u>	<u> </u>	□ 20 □ 24 □ 30 □ 36 🗸 42			
RATE	AMPS:	100 🗹 225 🗌 400 📗	60	00							C	ABINE	T: 🔽	SUF	RFACE	☐ FI	LUSH			
√FU	LL NEUTRAL	BUS GROUND BUS V HING	D DOC	DR		<b>∀</b> K	EYED [	DOOR I	ATCH			ENCLO	SURE	TYPE:	NEN	1A-1				
BRAN	CHES DEVICE	ES FUSED _V CIRCUIT	BREA	KER (E	BOL T-I	N)				-										
M	AIN LUGS O	NLY MAIN AMPS		BREAK	ER		USED	SWITC	HED						то	BE GF	CI BREAKERS			
LL BREAKERS MUST BE RATED TO INTERRUPT A SHORT CIRCUIT CURRENT OF 10,000 AMPS SYMMETRICAL.																				
CCE	CCEP TABLE MANUFACTURERS:																			

В	JS (KVA	A)									BUS										BUS (	(VA)
Α	В	С	LOAD	WIRE	GND	COND	AMPS	POLE		Α	В	С		POLE	AIVIPS	COND	GND	WIRE	LOAD	Α	E	С
32.7			PANEL "AC"	2 #1/0	#4	3"	300	3	1	+	-		2	3	400	3"	#3	2 #3/C	PANEL "LA" (2-SECTION)	28.	2	
	32.7	_							3	+	+	+	4								25	.9
2000 Pr. 100		32.7			2008				5		=	+	6							Money de		29.3
14.4			ELEVATOR MOTOR (40HP)	#2/O	#6	2 1/2"	175	3	7				8	3	60				SPARE	5.8		
	14.4	14.4							9 11				10 12								5.	5.8
											_	_	_ ''-'									0.0
										+	+	_	-									
										+	╬	+	-									
										╅	┰	7	-									
										4	4	-	_									
										+	_	_	-									
										╬	+	+	-									
										╅	= -	┪	-									
										<b>1</b>	7	T										
K۱	/A	BUS A	81.1 KVA BUS B 78.8 KVA BUS 0	82.2	KVA	то	TAL	242.0	) KV	/A	╅	AMF	S	BUS A	675.5	AMPS	BUS B	656.3	AMPS BUSC 684.7 AMPS TOT	AL 67	2 AM	PS
(A TEI	VOL	TAGE:	<b>☑</b> 120/208 <b>☐</b> 120/240 <b>☐</b> 277/480 -	3-PHAS	SE, 4-V	VIRE							BF	RANCH	POLE	ES:	<b>√</b> 12	<u> 18</u>	20 24 30 36 42			
RATE	AMP	S: 🗆		1000									C	ABINE	T: 🔽	SUF	RFACE	□ FI	LUSH			
		JTRAL					<b>∀</b> K	EYED	DOOF	RLAT	CH		E	NCLC	SURE	TYPE:	NE	ЛА-1				
		DEVICE				on the same			100000000000000000000000000000000000000		-40											
		JGS OI	MINE TO SERVICE		BREAK			USED														
ALL B	REAKE	RS MU	JST BE RATED TO INTERRUPT A SHO IUFACTURERS: SQ-D, GE, SEIMENS, (					22,000	AMF	S SY	MME	IRICA	L.									

	BU	s (KV	(A)	LOAD	WIRE	GND	COND	ANDC	POLE		В	US		POLE	AMPS	COND	GND	WIRE	LOAD	В	SUS (KV	(A)
Α		В	С	LOAD	WIKE	GND	COND	AIVIFS	POLE		Α	в с		FOLE	AIVIFS	COND	GND	WINE		Α	В	
1.2	2			GENERAL RECEPTACLES - MULTIPURPOSI	#12	#12	1/2"	20	1	43=	-		=	44 1	20	1/2"	#12	#12	GENERAL RECEPTACLES - 1st FL. STUDIO	1.4		▕
	▋	1.2		GENERAL RECEPTACLES - 2nd FL. STUDIO	#12	#12	1/2"	20	1	45	┿	•	H	46 1	20	1/2"	#12	#12	GENERAL RECEPTACLES - 1st FL. STUDIO		1.4	≣
			1.4	GENERAL RECEPTACLES - 2nd FL. STUDIO	#12	#12	1/2"	20	1	47	+		H	48 1	20	1/2"	#12	#12	GENERAL RECEPTACLES - 1st FL. STUDIO			
1.4	ı			GENERAL RECEPTACLES - 2nd FL. STUDIO	#12	#12	1/2"	20	1	49=	+	-	+[	50 1	20	1/2"	#12	#12	GENERAL RECEPTACLES - 1st FL. STUDIO	1.4		
		1.4		GENERAL RECEPTACLES - 2nd FL. STUDIO	#12	#12	1/2"	20	1	51	+	•	=	52 1	20	1/2"	#12	#12	GENERAL RECEPTACLES - 1st FL. STUDIO		1.4	
			1.4	GENERAL RECEPTACLES - 2nd FL. STUDIO	#12	#12	1/2"	20	1	53	+	₩	H	54 1	20	1/2"	#12	#12	GENERAL RECEPTACLES - MULTIPURPOS			13
1.0				GENERAL RECEPTACLES - 2nd FL. STUDIO	#12	#12	1/2"	20	1	55	+	-	=	56 2	60	1 1/4"	#10	#6	IWH-1	4.8		
		0.5		FIRE A LARM PANEL POWER	#12	#12	1/2"	20	1	57	╁		=	58					(JANITOR'S CLOSET)		4.8	
			0.5	SECURITY PANEL POWER	#12	#12	1/2"	20	1	59	╅	1		60 2	60	1 1/4"	#10	#6	IWH-2			Ī,
3.0	3			TELE / DATA / TV B.BOARD RECEPTACLES	#12	#12	1/2"	20	1	61	+		+	62					(BREAK RM)	4.8		蒷
		0.5		ELEVATOR CAB LIGHTING	#12	#12	1/2"	20	1	63	+	•	$\dashv$	64 1	20	1/2"	#12	#12	HAND DRYER		1.6	
			1.6	HAND DRYER	#12	#12	1/2"	20	1	65	╁	1		66 1	20	1/2"	#12	#12	HAND DRYER			
1.6	ì			HAND DRYER	#12	#12	1/2"	20	1	67	+		$\exists$	68 1	20	1/2"	#12	#12	GARBA GE DISPOSER	1.2		į
		1.6		SPARE				20	1	69	+	•	$\exists$	70 2	60	1 1/4"	#10	#6	IWH-3		4.8	
			1.6	SPARE				20	1	71	╅		+	72					(MEN'S RESTROOM)			Γ
				SPACE					1	73	+		$\forall$	74 2	60	1 1/4"	#10	#6	IWH-4	4.8		≣
	▋			SPACE					1	75	╁	•	$\dashv$	<u>7</u> 6	l				(WOMEN'S RESTROOM)		4.8	
				SPACE					1	77=	╁	1		78 1					SPACE			ſ
				SPACE					1	79	+	₩	H	80 1					SPACE			≣
	▋			SPACE					1	81	+	•	H	82 1					SPACE			Ī
				SPACE					1	83	+			84 1					SPACE			i
I	K۷	A	BUS A	24.3 KVA BUS B 23.9 KVA BUS C	20.4	KVA	то	TAL	68.5	KV	A	ΑN	IP S	BUSA	202.1	AMPS	BUS B	198.8	AMPS BUSC 170.0 AMPS TOTAL	190	AMP	S
RAT	ED	VOL	TAGE:	▼ 120/208	3-PHAS	SE, 4-W	/IRE							BRANCI	H POLE	S:	<b>12</b>	<u>18</u>	□ 20 □ 24 □ 30 □ 36 ☑ 42			
RAT	ED.	AMF	S: [	100 🗹 225 🗌 400 🗌	6	00								CABINE	T: 🔽	SUF	RFACE	☐ FL	USH			_
FULL NEUTRAL BUS   GROUND BUS   HINGED DOOR   KEYED DOOR LATCH ENCLOSURE TYPE: NEMA-1																						
BRA	NC	HES	DEVIC	ES FUSED _V CIRCUIT	BREA	KER (E	OLT-I	V)				1 .										_
	MA	IN L	UGS C	NLY MAIN AMPS		BREAK	ER	□ F	USED	SWIT	CHED						TO E	BE GF	CI BREAKERS			_
ALL	BR	EAK	ERS M	UST BE RATED TO INTERRUPT A SHOP	RT CIR	CUITC	URRE	NT OF	10,000	AMP	S SYMI	METRIC	AL									_
A CC	ED.	TARI	E MAI	NUFACTURERS:																		_



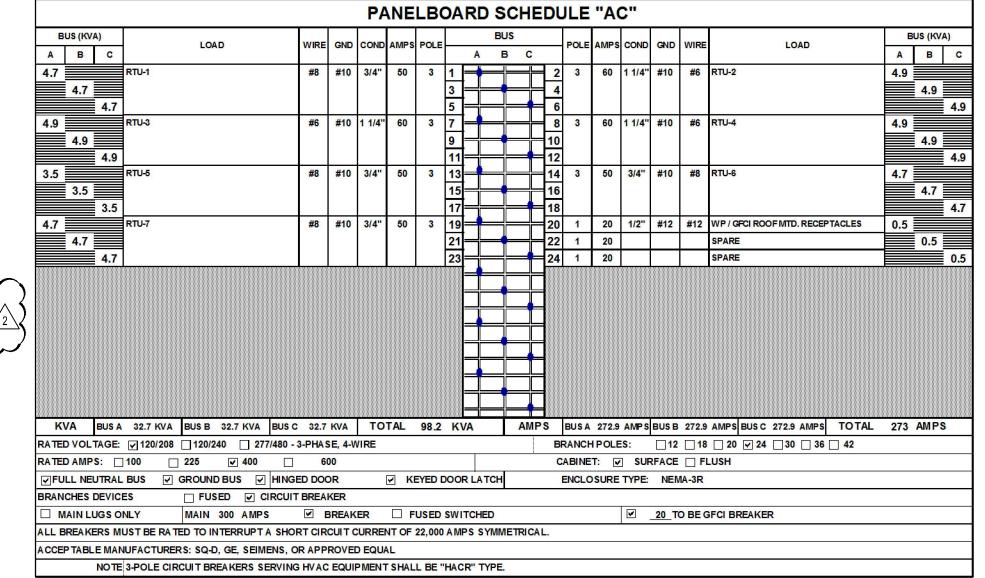

ELECTRICAL RISER DIAGRAM NOTEMSEF2BANESVECHEDINESOFORMOWIRE AND CONDUIT SIZES **CURRIE** 

**SOWARDS AGUILA** architects

Architecture, Planning, Interiors, & Sustainable Design AA26001584

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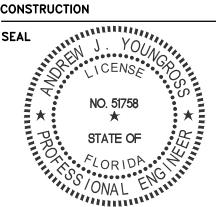
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ISSUED FOR:

PERMIT

SPRAB 02/13/2015 06/25/2015

CONSTRUCTION



06/25/2015

PROJECT TITLE Art Warehouse

313 NE 3rd Street Delray Bch, Florida, 33444

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15009\_E DRAWING TITLE

**L** ELECTRICAL T RISER DIAGRAM & O PANEL SCHEDULES

90

06/25/2015 AA/MT/HL JOB NUMBER

100701/15009

DRAWING NUMBER


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PLUMBING
ELECTRICAL THOMPSON & YOUNGROSS ENGINEERING CONSULTANTS, LLC C.o.A NO. 25996


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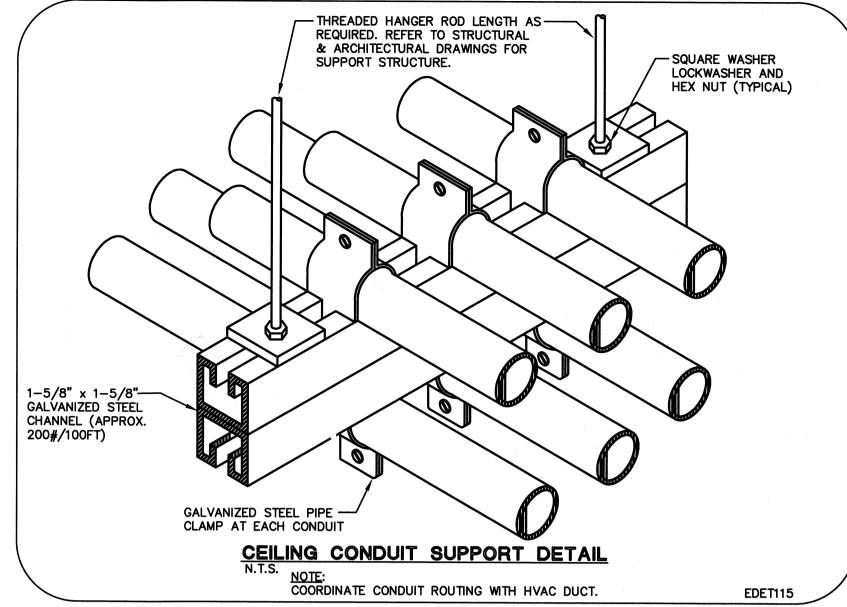
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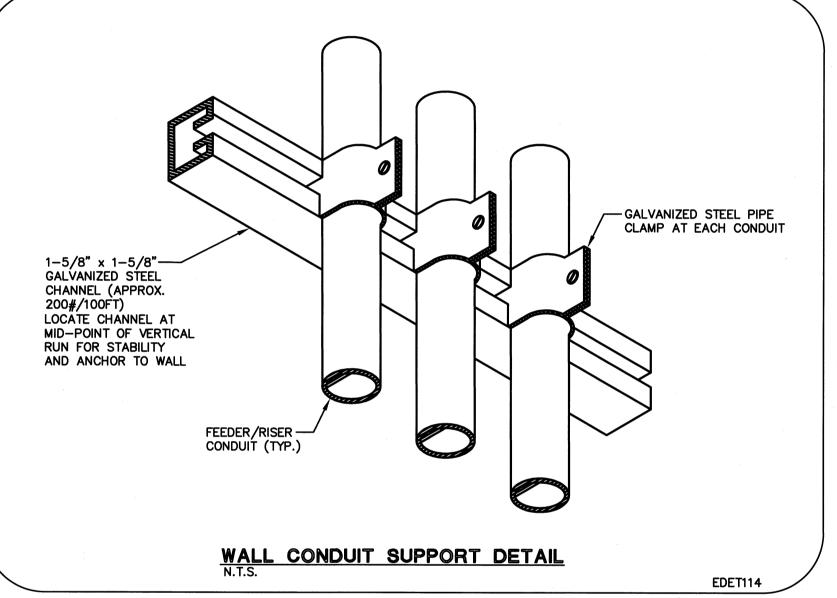
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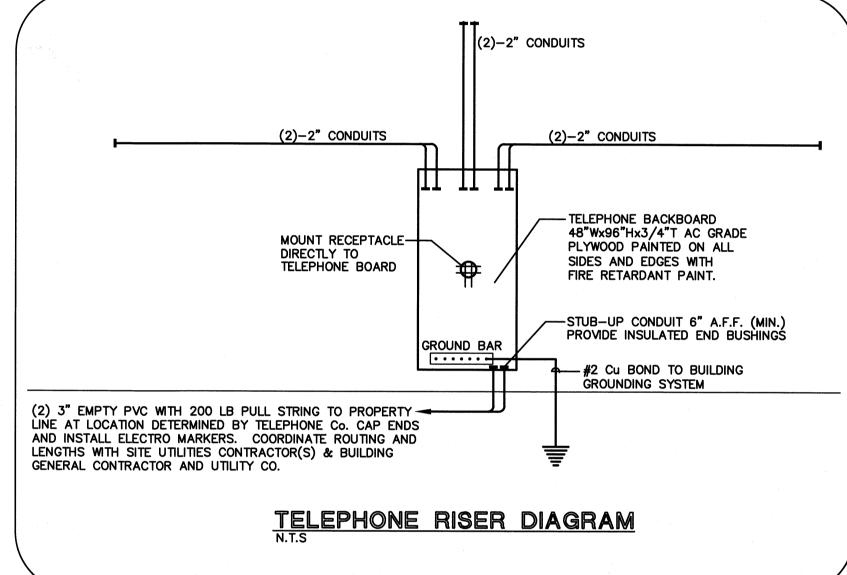
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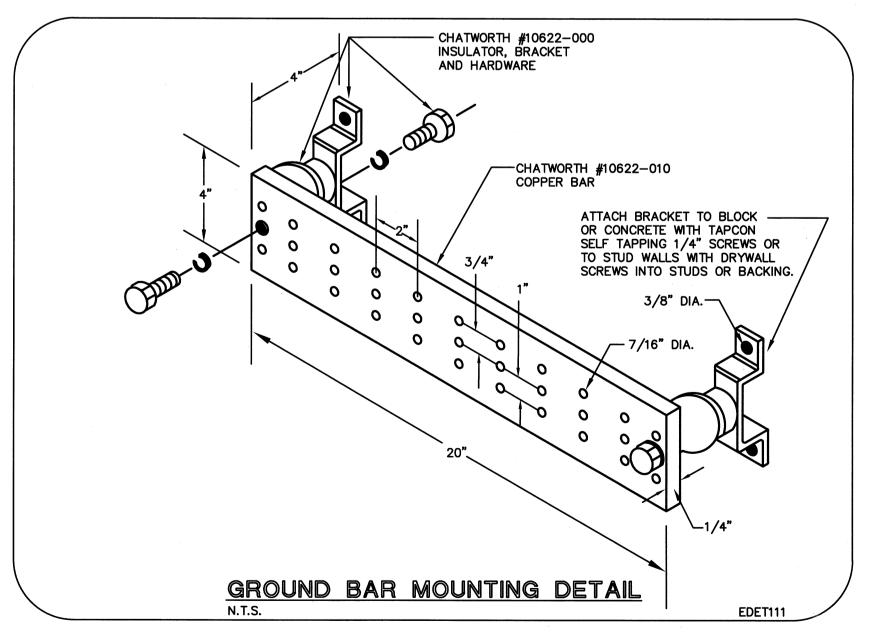










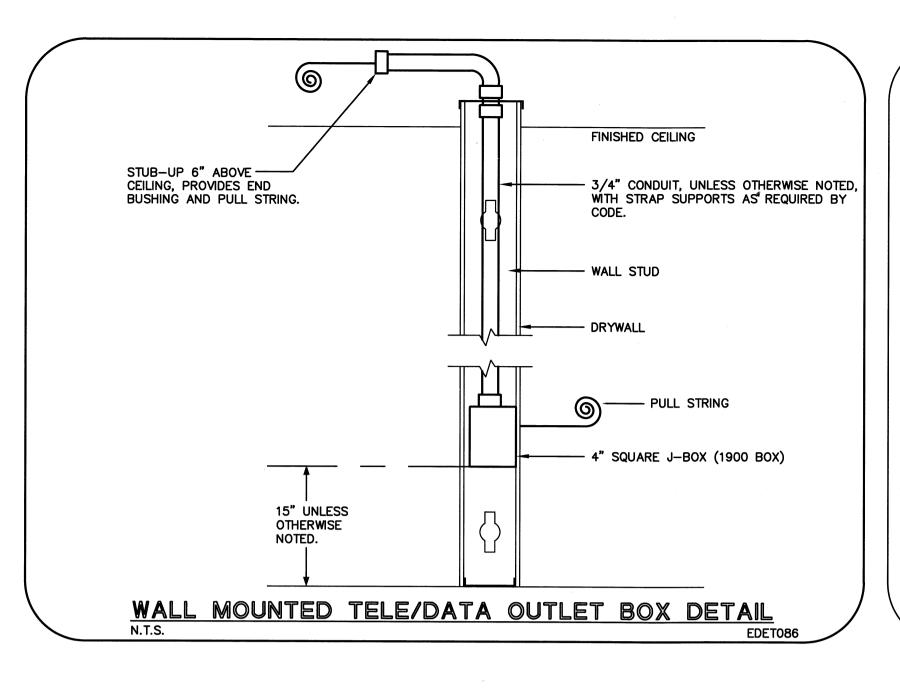

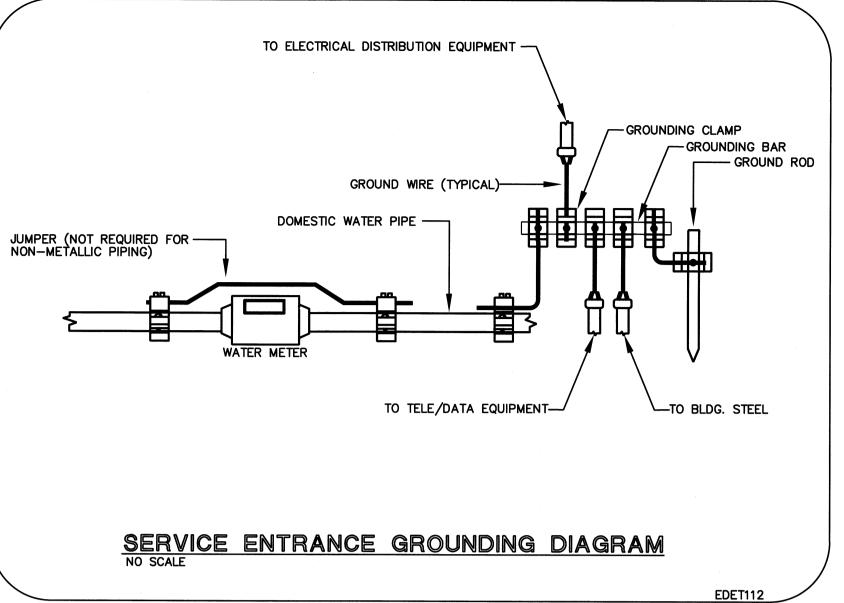

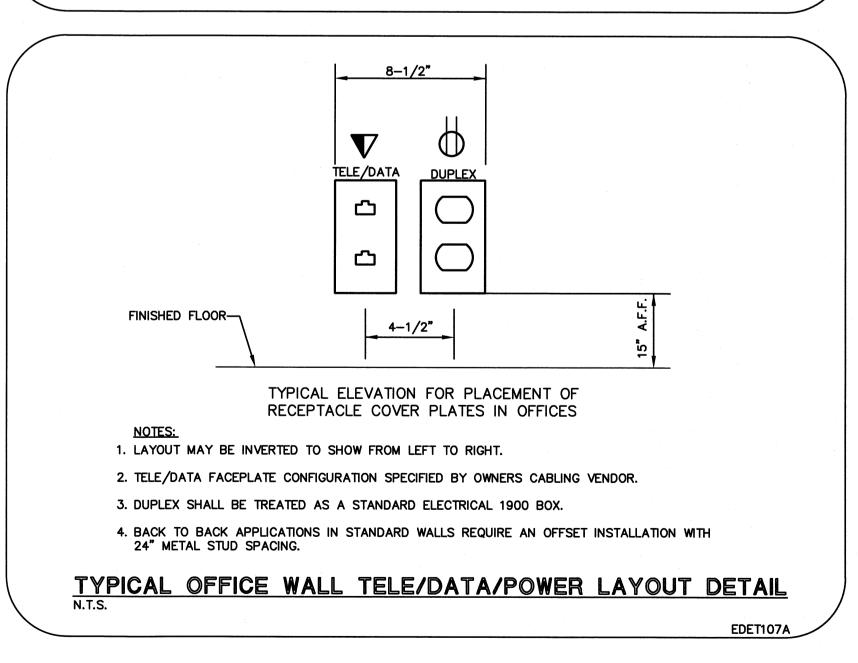

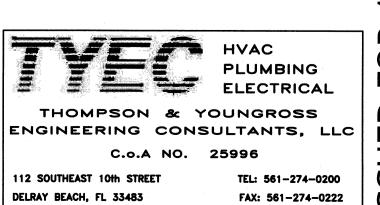

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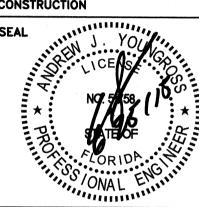
E-MAIL: office@csa-architects.com

ISSUED FOR:

02/13/2015 06/25/2015

PERMIT 06/25/2015

CONSTRUCTION



PROJECT TITLE Art Warehouse

313 NE 3rd Street Delray Bch, Florida, 33444

REVISIONS NUM. DESCRIPTION DATE

THESE DRAWINGS ARE PREPARED PER ESTABLISHED INDUSTRY STANDARDS AND REPRESENT THE ARCHITECT AND ENGINEERS DESIGN CONCEPT. THEY ARE NOT INTENDED TO PROVIDE EVERY DETAIL OR CONDITION REQUIRED TO CONSTRUCT THE BUILDING. THE CONTRACTOR THROUGH SUBMITTALS AND OTHER COORDINATION EFFORTS IS FULLY RESPONSIBLE FOR PROVIDING A COMPLETE AND OPERATIONAL BUILDING WHETHER

> INDICATED ON THE PLANS OR NOT. FILE NUMBER **Ш** 15009\_Е

DRAWING TITLE Щ ELECTRICAL DETAILS

00 DATE DATE DRAWN BY O6/25/2015 AA/MT/HI

JOB NUMBER DRAWING NUMBER

	Pl	LUMBIN	IG FIXTURE LIST
FIXTURES	FOR APPRO	OVAL. COLOR	N PRODUCTS ARE LISTED. SUBMIT ALTERNATE IS WHITE UNLESS OTHERWISE NOTED. H TABLE 604.4 OF F.B.C.—PLUMBING
			STOP VALVES, FITTINGS, ACCESSORIES, R A COMPLETE FUNCTIONAL PLUMBING
TAG	MFG.	MODEL	REMARKS
LAV	AMERICAN STANDARD	0497.221 7385.003 .V05	UNDER COUNTER TOP LAVATORY. FAUCET, 0.5 GPM, GRID DRAIN, LESS POP-UP HOLE VANDAL RESISTANT, INDEXED METAL LEVER HANDLE.
HLAV	AMERICAN STANDARD	0355.012 7385.003 .V05	WALL HUNG HANDICAPPED LAVATORY, WITH CARRIER ZURN Z1231 CONCEALED ARM SYSTEM. PROVIDE OPTION—SL WHEN BACK WALL IS 4" OR LARGER. FAUCET, 0.5 GPM, GRID DRAIN, LESS POP—UP HOLE, VANDAL RESISTANT, INDEXED METAL LEVER HANDLE, PROVIDE TRUEBRO DRAIN/PIPE INSULATION.
WC	AMERICAN STANDARD SLOAN	2234.528 #111-1.28	FLUSH VALVE WATER CLOSET (1.28 GPF) MADERA, TOP SPUD ROYAL FLUSH VALVE, OLSONITE #95 SEAT.
HWC	AMERICAN STANDARD SLOAN	3043.528 #111-1.28	HANDICAPPED FLUSH VALVE WATER CLOSET (1.6 GPF) MADERA, 17"H, TOP SPUD ROYAL FLUSH VALVE, OLSONITE #95 SEAT.
HUR	AMERICAN STANDARD SLOAN	6501.511 #186–1.0	HANDICAPPED WASHBROOK URINAL. TOP SPUD. 3/4" TOP SPUD, ZURN Z1221 CARRIER, PLATE TYPE SYSTEM. MOUNT RIM AT MAX. 17" A.F.F. — ADA COMPLIANT. ROYAL FLUSH VALVE. 1.0 GPF
SK-2 W/GD	ELKAY	LR3322 LK1000 BADGER 5	DOUBLE BOWL 33"x22", 3 FAUCET HOLES, SINGLE LEVER FAUCET ADA COMPLIANT, 1.5 GPM AND EX99 STRAINER W/ 1-1/2" S.S. TAILPIESE. GARBAGE DISPOSER, 1/2HP, 120V/60HZ/1ø.
HI-LO EWC	<u>ELKAY</u>	^ <u>LZSTL8SE</u>	BARRIER FREE, WALL MOUNTED WATER COOLER WITH WATERSENTRY FILTER SYSTEM, STAINLESS STEEL, SUPPLY ANY ADDITIONAL WALL CARRIERS REQUIRED FOR COMPLETE INSTALLATION. MUST MEET A.D.A. CODE. 115V, 4.0 AMPS, 60HZ, SINGLE PHASE.
FD	ZURN	Z415BZ NHP	FLOOR DRAIN, DURA COATED CAST IRON BODY WITH BOTTOM OUTLET, POLISHED BRONZE ROUND LEVELING STRAINER TOP, NO HUB, 3"ø SIZE, 1/2" TRAP PRIMER CONNECTION.
FD-1	ZURN	Z551 -NH-P-Y	FLOOR DRAIN, DURA COATED CAST IRON BODY WITH BOTTOM OUTLET, SEDIMENT BUCKET. MEDIUM DUTY SLOTTED GRATE. NO HUB, 3"Ø SIZE, 1/2" TRAP PRIMER CONNECTION.
TP	ZURN	Z1022	SANI-GUARD AUTOMATIC TRAP PRIMER, ALL BRONZE BODY WITH INTEGRAL VACUUM BREAKER. 1/2" PIPE SIZE.
SS	MUSTEE	14CP	MOLDED RESIN CONSTRUCTION, 20 GALLON CAPACITY, 13" DEEP, 6" SWING SPOUT FAUCET WITH AERATOR AND HOSE END. 20" FLEXIBLE SUPPLY LINES. STEEL LEGS WITH ADJUSTABLE LEVELERS. WHITE FINISH.
PLASTER TRAP	DCA	9520	DENTAL CORPORATION OF AMERICA PLASTER TRAP 3.5 GALLON, TWO WIRE REINFORCED HOSES, ONE PLUMBING ADAPTER, ONE CONTAINER WITH LID HOSE FITTING. TWO HOSE FITTING CAPS FOR DISPOSING.
НВ	ZURN	Z1341-P34	HOSE BIBB W/ VACUUM BREAKER. ROUGH BRONZE.

PLU	mbing legend
C.O.	CLEAN OUT
C.O.T.G.	CLEAN OUT TO GRADE
CW	DOMESTIC COLD WATER
HW	DOMESTIC HOT WATER
HWR	DOMESTIC HOT WATER RETURN
VTR	VENT THRU ROOF
AAV	AIR ADMITTANCE VALVE
DN	DOWN
V.I.F.	VERIFY IN FIELD
WHA	WATER HAMMER ARRESTER- PDI #
sov	SHUT-OFF VALVE
U.G.	UNDER GROUND
T.P.	TRAP PRIMER
@ CEIL.	PLUMBING LINE ROUTED AT CEILING
(E)	EXISTING
A.F.F.	ABOVE FINISHED FLOOR
A.F.G.	ABOVE FINISHED GRADE
⋈ 3	BALL VALVE
ю	BALL VALVE IN VERTICAL
<del>-</del>	HOSE BIBB WITH VACUUM BREAKER
-·-·-	DOMESTIC COLD WATER PIPING
	DOMESTIC HOT WATER PIPING (110°F)
— COND —	CONDENSATE PIPING
	VENT PIPING
	SANITARY SEWER PIPING
— ғм —	FORCE MAIN PIPING
<del></del>	PIPE DROP DOWN
	PIPE RISER UP
<del></del>	CAPPED END OF PIPE
	P-TRAP
	CLEAN OUT
<b></b>	UNION — SCREWED OR FLANGED
	CONDENSATE PIPE SUPPORT
⊅ <b>⊝</b> FD	FLOOR DRAIN
i	1

	PLUMBING FIXTURE SCHEDULE													
MARK	FIXTURE		IPE S H.W.	WASTE	TRAP	FIXTURE UNIT	QTY	TOTAL FIXTURE UNIT	REMARKS					
HLAV	LAVATORY (HANDICAPPED)	1/2"	_	2"	1-1/4"	1	3	3						
LAV	LAVATORY	1/2"	-	2"	1-1/4"	1	4	4						
HWC	WATER CLOSET (HANDICAPPED)	1"	ı	3"	INT.	4	3	12	3x4					
WC	WATER CLOSET	1"	ı	3"	INT.	4	4	16	3x4					
HUR	URINAL (HANDICAPPED)	3/4"	ı	2"	INT.	4	1	4						
HI-LO EWC	HI-LO ELECTRIC WATER COOLER	1/2"	-	2"	1-1/2"	0.5	2	1						
SS	SERVICE SINK	1/2"	_	2"	1-1/2"	2	13	24						
	MOP SINK	1/2"	ı	3"	3"	2	1	2						
	FUTURE SERVICE SINK	1/2"	ı	2"	FUT.	2	11	22						
SK-2	2 BOWL SINK	1/2"	_	2"	1-1/2"	2	1	2						
FD	FLOOR DRAIN	_	_	3"	3"	0	3	0	1/2"T.P.					
нв	HOSE BIBB	3/4"	_	_	_	0	2	0						

TOTAL

ALL FIXTURES SHALL COMPLY WITH TABLE 604.4 (MAX. FLOW RATES), TABLE 604.5 (MIN. SIZES OF WATER SUPPLY), & TABLE 709.1 (MIN. SIZE OF TRAP) OF F.B.C.-PLUMBING WATER METER AND BACKFLOW PREVENTOR SHALL BE SIZED BY THE CITY OF DELRAY BEACH. WATER METER AND BACKFLOW PREVENTOR SHALL BE PROVIDED AND INSTALLED BY PLUMBING CONT.

#### GENERAL PLUMBING NOTES

- ALL WORK SHALL COMPLY WITH THE 2010 EDITION OF THE FLORIDA PLUMBING, ENERGY CONSERVATION, ACCESSIBILITY AND FUEL GAS CODES, AND ALL LOCAL CODE
- DO NOT SCALE DRAWINGS. VERIFY DIMENSIONS IN FIELD PRIOR TO COMMENCEMENT OF WORK. THE DRAWINGS ARE DIAGRAMMATIC AND INDICATE GENERAL LAYOUT OF PLUMBING SYSTEMS.
- CONTRACTOR SHALL VISIT THE EXISTING SITE (IF APPLICABLE) PRIOR TO BIDDING AND SHALL INVESTIGATE ALL CONDITIONS THAT AFFECT HIS WORK; VERIFY LOCATIONS, SIZES, DIMENSIONS, AND INVERT ELEVATIONS OF ALL ON-SITE SANITARY SEWERS, STORM DRAINS, WATER MAINS AND NATURAL GAS MAINS, AND MAKE CERTAIN THAT ALL CONNECTIONS CAN BE MADE. THE CONTRACTOR SHALL MAKE THE ARCHITECT/ENGINEER AWARE OF ANY CONFLICTS.
- CONTRACTOR SHALL REVIEW ARCHITECTURAL, STRUCTURAL, MECHANICAL AND OTHER DRAWINGS PRIOR TO BID AND SHALL COORDINATE ALL TRADES TO PROVIDE A COMPLETE PRODUCT TO AVOID CONFLICTS BETWEEN THE TRADES, AND TO DETERMINE WHICH TRADE IS TO PERFORM THE NECESSARY WORK. RESOLVE ALL QUESTIONS OR CONFLICTS WITH THE ENGINEER BEFORE ANY EQUIPMENT IS ORDERED, MATERIALS FABRICATED OR SYSTEMS INSTALLED. CONSULT THE ARCHITECT'S DRAWINGS FOR ALL GRADE AND FINISH FLOOR ELEVATIONS.
- CONTRACTOR SHALL GUARANTEE THE INSTALLATION AGAINST DEFECTS IN MATERIALS AND WORKMANSHIP WHICH MAY OCCUR UNDER NORMAL USAGE FOR A PERIOD OF ONE YEAR AFTER OWNER'S ACCEPTANCE. DEFECTS SHALL BE PROMPTLY REMEDIED WITHOUT COST TO
- CONTRACTOR SHALL SECURE AND PAY FOR ALL PERMITS, FEES, INSPECTION AND TESTS. CONTRACTOR SHALL OBTAIN PERMIT AND APPROVED SUBMITTALS PRIOR TO COMMENCEMENT OF WORK OR ORDERING EQUIPMENT. PLUMBING CONTRACTOR SHALL BE PRESENT FOR ALL INSPECTIONS OF HIS WORK BY REGULATORY AUTHORITIES.
- CONTRACTOR SHALL PROVIDE RECORD DRAWINGS TO THE BUILDING OWNER AND ARCHITECT. DRAWINGS SHALL INCLUDE ALL ADDENDUM ITEMS, CHANGE ORDERS, ALTERATIONS, REROUTINGS, ETC.
- CONTRACTOR SHALL PROVIDE INSURANCE FOR PROTECTION AGAINST PUBLIC LIABILITY AND PROPERTY DAMAGE FOR THE DURATION OF THE WORK.
- 9. CONTRACTOR SHALL PROVIDE SHOP DRAWINGS FOR ALL EQUIPMENT AT ONE TIME, BOUND IN THREE-RING BINDERS, INDEXED IN A NEAT AND ORDERLY MANNER. PARTIAL SUBMITTALS WILL NOT BE ACCEPTED. PLUMBING CONTRACTOR SHALL NOT ORDER ANY EQUIPMENT WITHOUT APPROVAL FROM PLUMBING ENGINEER, ARCHITECT, OWNER, AND INTERIOR DESIGNER (IF APPLICABLE).
- 10. CONTRACTOR SHALL PROVIDE ACCESS PANELS FOR ALL CONCEALED VALVES. ACCESS PANELS IN RATED WALLS OR CEILINGS MUST MAINTAIN THE SAME RATING AND MUST MATCH THE FINISH OF THE WALL OR CEILING IN WHICH IS INSTALLED.
- 11. TRENCHING, BACKFILL AND CONCRETE WORK ASSOCIATED WITH PLUMBING SHALL BE PERFORMED IN ACCORDANCE WITH THE APPLICABLE SPECIFICATIONS.
- 12. CONTRACTOR SHALL PROVIDE AND INSTALL ALL SLEEVES THROUGH FLOORS AND WALLS. PIPING THROUGH FLOORS SHALL BE SLEEVED, CAULKED AND FLASHED TO PREVENT LEAKAGE. SEAL ALL WALL PENETRATIONS WATERTIGHT WITH SILICONE CAULKING AND BACKER ROD, OR COVERED WITH ESCUTCHEON PLATES. IT SHALL ALSO BE THE RESPONSIBILITY OF THE PLUMBING SUBCONTRACTOR TO PROVIDE ALL LAYOUT, SLEEVING, CONCRETE CUTTING AND PATCHING, AND CONCRETE COREBORING AS REQUIRED TO COMPLETE ALL OF PLUMBING WORK. ALL LAYOUT OF REQUIRED CONCRETE CUTTING MUST BE APPROVED BY THE GENERAL CONTRACTOR PRIOR TO PLUMBING SUBCONTRACTOR'S EXECUTION OF SAME.
- 13. PIPE PENETRATIONS THROUGH FIRE RATED WALLS OR FLOORS SHALL HAVE EQUIVALENTLY RATED SLEEVES AND SHALL BE SEALED AND FIRE CAULKED WITH A UL LISTED FIRE STOPPING SYSTEM INSTALLED IN ACCORDANCE WITH THE MANUFACTURE'S LISTED DETAILS
- 14. LAYOUT PIPES TO FALL (CONCEALED) WITHIN PARTITION WALL OR CHASES. NOTIFY ARCHITECT IF ADDITIONAL WALL SPACE IS REQUIRED. COORDINATE PIPE DROP WITH FOOTINGS, STRUCTURAL STEEL, FIRE RATED WALLS, WHICH MAY FALL BELOW PARTITION WALL OR CHASE. MAKE NECESSARY ADJUSTMENT TO PIPING TO AVOID CONFLICT WITH BUILDING OBSTRUCTIONS. CONSULT WITH ARCHITECT AND CONTRACT DOCUMENTS FOR LOCATION OF ALL RATED WALLS, CEILINGS, FLOORS AND ROOF. FURNISH AND INSTALL APPROPRIATE AND APPROVED FIRE BARRIER AT ALL PENETRATIONS. INSTALLATION SHALL BE PER MANUFACTURES SPECIFICATIONS.
- 15. NO COMBUSTIBLE MATERIAL TO BE USED IN MECHANICAL ROOM(S) OR IN CEILING SPACE(S) WHERE USED AS RETURN AIR PLENUMS.
- 16. NO WATER, SANITARY OR DRAINAGE PIPING PERMITTED IN ELECTRICAL OR ELEVATOR EQUIPMENT ROOMS.
- 17. CONTRACTOR SHALL PROVIDE PIPE HANGERS FOR ALL PIPING. HANGER RODS AND DEVICES SHALL BE USED FOR SUPPORT OF ALL PIPING. MAKESHIFT DEVICES WILL NOT BE ACCEPTABLE. HANGER DEVICES SHALL BE SIZED TO FIT AROUND INSULATION. PROVIDE GALVANIZED STEEL SADDLES AS REQUIRED. PIPING SUPPORT SPACING SHALL COMPLY WITH THE FLORIDA PLUMBING CODE-2010.
- 18. SANITARY, VENT PIPING AND DOMESTIC WATER PIPING SHALL BE TESTED IN ACCORDANCE WITH SECTION 312 OF THE FLORIDA PLUMBING CODE-2010.
- 19. DIELECTRIC COUPLINGS ARE REQUIRED BETWEEN ALL DISSIMILAR METAL IN PIPING AND EQUIPMENT CONNECTIONS.
- 20. IN AREAS OF EXPOSED CMU, ALL PIPING SHALL BE WITHIN CMU WALL. NO EXPOSED PIPING SHALL BE ALLOWED. COORDINATION WITH OTHER TRADES SHALL BE THE RESPONSIBILITY OF THE PLUMBING CONTRACTOR.
- 21. MAINTAIN A MINIMUM SEPARATION OF 5 FFFT BETWEEN POTABLE WATER PIPE AND BUILDING SEWER. WHEN THERE IS LESS THAN 5 FEET OF SEPARATION MAINTAIN A MINIMUM OF 12 INCHES BETWEEN INVERT OF POTABLE WATER AND TOP OF SEWER.
- 22. MATERIALS AND EQUIPMENT SHALL BE NEW OF AMERICAN MANUFACTURER, FREE OF DEFECTS AND IT SHALL MEET THE REQUIREMENTS OF THE NATIONAL BOARD OF FIRE UNDERWRITERS, ASTM & ANSI SPECIFICATIONS WHERE SUCH EXIST, STANDARD AND LOCAL BUILDING CODES, AND SHALL BE SUITABLE FOR THE USE INTENDED.
- 23. PLUMBING PIPING SHALL BE LABELED WITH CONTENT DESCRIPTION AND FLOW DIRECTION.
- 24. CONTRACTOR SHALL PROVIDE AN ELEVATOR PIT SUMP PUMP AS SHOWN ON THE DRAWINGS AND SPECIFICATIONS. ELEVATOR PIT SUMP PUMP SHALL BE IN ACCORDANCE WITH FLORIDA ELEVATOR SAFETY TECHNICAL ADVISORY COUNCIL-STANDARD FOR SUMP PUMP INSTALLATION AND 2007 FLORIDA BUILDING CODE-PLUMBING SECTIONS 301.6-EXCEPTION, 712.3 AND 1003.4-EXCEPTION.

#### WATER PIPING SYSTEM NOTES

- WATER PIPING SHALL BE: COPPER PIPING (ABOVE GRADE): ASTM B88, TYPE L, HARD DRAWN.
- FITTINGS: (a) SOLDERED: ANSI/ASME B16.23, CAST BRASS OR ANSI/ASME B16.29, WROUGHT COPPER. (b) PRESSED: ASME B16.18 OR ASME B16.22, COPPER PRESS FITTING WITH
- EPDM O-RING AND SMART CONNECT (SC FEATURE). JOINTS: (a) SOLDERED: ANSI/ASTM B32, LEAD-FREE SOLDER, GRADE 95TA.
- (b) PRESSED: ASME B16.18 OR ASME B16.22, COPPER PRESS FITTING WITH EPDM O-RING AND SMART CONNECT (SC FEATURE). COPPER PIPING (UNDERGROUND BUILDING EXTERIOR): ASTM B88, TYPE K, HARD DRAWN.
- FITTINGS: (a) SOLDERED: ANSI/ASME B16.29, WROUGHT COPPER. (b) PRESSED: ASME B16.18 OR ASME B16.22, COPPER PRESS FITTING WITH
- EPDM O-RING AND SMART CONNECT (SC FEATURE). JOINTS: (a) SOLDERED: ANSI/ASTM B32, LEAD-FREE SOLDER, GRADE 95TA. (b) PRESSED: ASME B16.18 OR ASME B16.22, COPPER PRESS FITTING WITH
- EPDM O-RING AND SMART CONNECT (SC FEATURE). COPPER PIPING (UNDERGROUND UNDER BUILDING SLAB): ASTM B878, TYPE K, SOFT DRAWN. FITTINGS: (a) SOLDERED: ANSI/ASME B16.29, WROUGHT COPPER.
- (b) PRESSED: ASME B16.18 OR ASME B16.22, COPPER PRESS FITTING WITH EPDM O-RING AND SMART CONNECT (SC FEATURE).
- JOINTS: (a) SOLDERED: ANSI/ASTM B32, LEAD-FREE SOLDER, GRADE 95TA. (b) PRESSED: ASME B16.18 OR ASME B16.22, COPPER PRESS FITTING WITH EPDM O-RING AND SMART CONNECT (SC FEATURE).
- FITTINGS AND JOINTS SHALL COMPLY WITH SECTIONS 605.14.1 THROUGH 605.14.5 OF FBC-PLUMBING. WATER VALVES 2" AND SMALLER SHALL BE A BRONZE BALL VALVE, TWO-PIECE BODY, 600 PSI WORKING PRESSURE, NIBCO MODEL S-585-80-LF (NSF-61 LEAD FREE) OR APPROVED EQUAL. THE USE OF GATE VALVES SHALL BE PROHIBITED.
- NEW OR REPAIRED POTABLE WATER SYSTEMS SHALL BE PURGED OF DELETERIOUS MATTER AND WHERE REQUIRED BY THE ADMINISTRATIVE AUTHORITY, DISINFECTED PRIOR TO UTILIZATION. THE METHOD TO BE FOLLOWED SHALL BE AS PER SECTION 610 OF FPC-2010.
- ALL FIXTURES MUST BE PROVIDED WITH READILY ACCESSIBLE STOPS AND APPROPRIATELY MARKED ACCESS PANELS. COORDINATE LOCATIONS WITH GENERAL CONTRACTOR PRIOR TO INSTALLATION.
- PROVIDE ANGLE STOPS ON ALL WATER SERVICE LINES TO FIXTURES FOR INDIVIDUAL SHUT-OFF.
- PROVIDE A WATER HAMMER ARRESTOR ON ALL WATER SUPPLY LINES SERVING FLUSH VALVE PLUMBING FIXTURES, SOLENOID VALVES, ETC. INCLUDING OTHER FIXTURES OR EQUIPMENT WITH QUICK CLOSING VALVES (ICE MAKERS, & DISHWASHERS). USE SIOUX CHIEF SHOCK ARRESTORS, P.D.I.#A; 1/2"CONN., P.D.I.#B; 3/4"CONN. P.D.I.#C; 1"CONN.. APPROVED FOR INSTALLATION WITH NO ACCESS PANEL REQUIRED. CONFORMS WITH ANSI/ASSE 1010 STANDARDS.
- PROVIDE AUTOMATIC TRAP PRIMER ON COLD WATER CONNECTION TO LAVATORY FIXTURE WITH COLD WATER TUBE TO FLOOR DRAIN AUXILIARY INLET FITTING. FLOOR DRAINS IN AREAS WHERE A LAVATORY (TRAP PRIMER) CONNECTION IS NOT AVAILABLE, PROVIDE A TRAP PRIMER DISTRIBUTION UNIT PRECISION PLUMBING PRODUCTS, MODEL PR-500 (OR APPROVED EQUAL) AND A SHUT-OFF VALVE IN ACCESSIBLE AREA.
- 8. INSTALL VACUUM BREAKERS ON ALL HOSE BIBBS AND HYDRANTS.
- 9. ALL OUTSIDE HOSE BIBBS SHALL BE INSTALLED 2'-0" ABOVE FINISHED GRADE UNLESS OTHERWISE NOTED.
- 10. DO NOT PENETRATE DOMESTIC WATER PIPING USED FOR ELECTRICAL GROUNDING THROUGH AND INTO THE ELECTRICAL ROOMS. TERMINATE THE PIPE OUTSIDE OF THE ELECTRICAL ROOM AND PROVIDE GROUND STRAPS.
- ESCUTCHEONS SHALL BE CHROME PLATED BRASS WITH LOCKING SCREWS WHERE PIPES PASS THROUGH FINISHED WALLS.

### SANITARY. VENT & CONDENSATE DRAIN SYSTEMS

- SANITARY, VENT, STORM DRAIN AND CONDENSATE DRAIN PIPING SHALL BE SOLID WALL SCHEDULE 40 PVC COMPLIANT WITH ASTM D 2665. PROVIDE 3/4" THICK AP/ARMAFLEX SS (SELF-SEAL) INSULATION FOR ALL HORIZONTAL ABOVE-GRADE CONDENSATE PIPING. INSTALLATION SHALL BE IN STRICT CONFORMANCE WITH MANUFACTURER'S REQUIREMENTS.
- CONDENSATE DRAIN PIPING SHALL BE SOLID WALL SCHEDULE 40 PVC COMPLIANT WITH ASTM D 2665 BELOW GRADE AND HUBLESS CAST IRON OR TYPE "DMV" COPPER ABOVE SLAB. PROVIDE 3/4" THICK AP/ARMAFLEX SS (SELF-SEAL) INSULATION FOR ALL HORIZONTAL ABOVE-GRADE PIPING. SCHEDULE 40 PVC MAY BE USED IF NOT IN A RETURN AIR PLENUM RATED SPACE. ALL CONDENSATE PIPING ABOVE ROOF DECK SHALL BE SCHEDULE 40 PVC WITH NO INSULATION, PVC PIPING EXPOSED TO SUNLIGHT SHALL BE COATED WITH AN ULTRA VIOLET INHIBITING MATERIAL. INSTALLATION SHALL BE IN STRICT CONFORMANCE WITH MANUFACTURER'S REQUIREMENTS.
- PROVIDE CHROME PLATED COMBINATION COVER PLATE AND CLEANOUT PLUG OR ACCESS PANEL FOR ALL WALL CLEANOUTS.
- 3. MAINTAIN A MINIMUM SLOPE OF 1/4" PER FOOT FOR DRAIN PIPING 2-1/2" OR LESS,
- 4. ALL DRAINAGE P-TRAPS FOR SINKS, LAVATORIES, AND WATER COOLERS SHALL BE OF A SLIP-JOINT TYPE.

AND 1/8" PER FOOT FOR PIPES 3" AND LARGER.

- 5. ALL VENT AND BRANCH VENT PIPES SHALL BE SO GRADED AND CONNECTED AS TO DRAIN BACK TO THE DRAINAGE PIPE BY GRAVITY.
- 6. EVERY DRY VENT SHALL RISE VERTICALLY TO A MINIMUM OF 6 INCHES ABOVE THE FLOOD LEVEL RIM OF THE HIGHEST TRAP OR TRAPPED FIXTURE BEING VENTED.
- VENT FLASHING AND COUNTER FLASHING SHALL BE COMPATIBLE TO ROOFING SYSTEM.
- 8. A CLEANOUT SHALL BE PROVIDED AT THE BASE OF EACH SOIL, WASTE AND STORM STACK. 9. ALL (VTR'S) VENT THRU ROOF PENETRATIONS INDICATED ON PLANS ARE PRELIMINARY. FINAL LOCATIONS SHALL BE COORDINATED WITH ALL TRADES. ALL VTR'S SHALL BE A

MINIMUM OF 10'-0" FROM ALL FRESH AIR INTAKE OPENINGS.

PLUMBING DRAWING LIST

P0.1 PLUMBING NOTES, LEGEND, AND SCHEDULE

P1.1 FIRST FLOOR PLAN- PLUMBING

P1.2 2ND FLOOR PLAN- PLUMBING P2.1 PLUMBING ISOMETRIC DIAGRAMS

P3.1 | PLUMBING DETAILS

NUMBER

DRAWING NAME



# architects

Architecture, Planning, Interiors, & Sustainable Design AA26001584


185 NE 4TH AVENUE SUITE 101 DELRAY BEACH, FL 33483

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ISSUED FOR: 02/13/2015 06/25/2015

06/25/2015 PERMIT

CONSTRUCTION

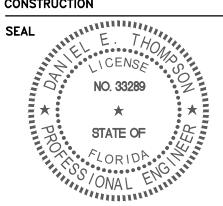

Art Warehouse

313 NE 3rd Street Delray Bch, Florida, 33444

REVISIONS NUM. DESCRIPTION DATE 1 Bldg. Dept. comments 08.21.15

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DRAWING TITLE LO PLUMBING  $\dashv$  NOTES

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06/25/2015 AA/MT/HL JOB NUMBER


100701/15009

ENGINEERING CONSULTANTS, LLC C.o.A NO. 25996 112 SOUTHEAST 10th STREET DELRAY BEACH, FL 33483 FAX: 561-274-0222 E-MAIL: tec@tecfla.com www.tecfla.com

ELECTRICAL

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PLUMBING



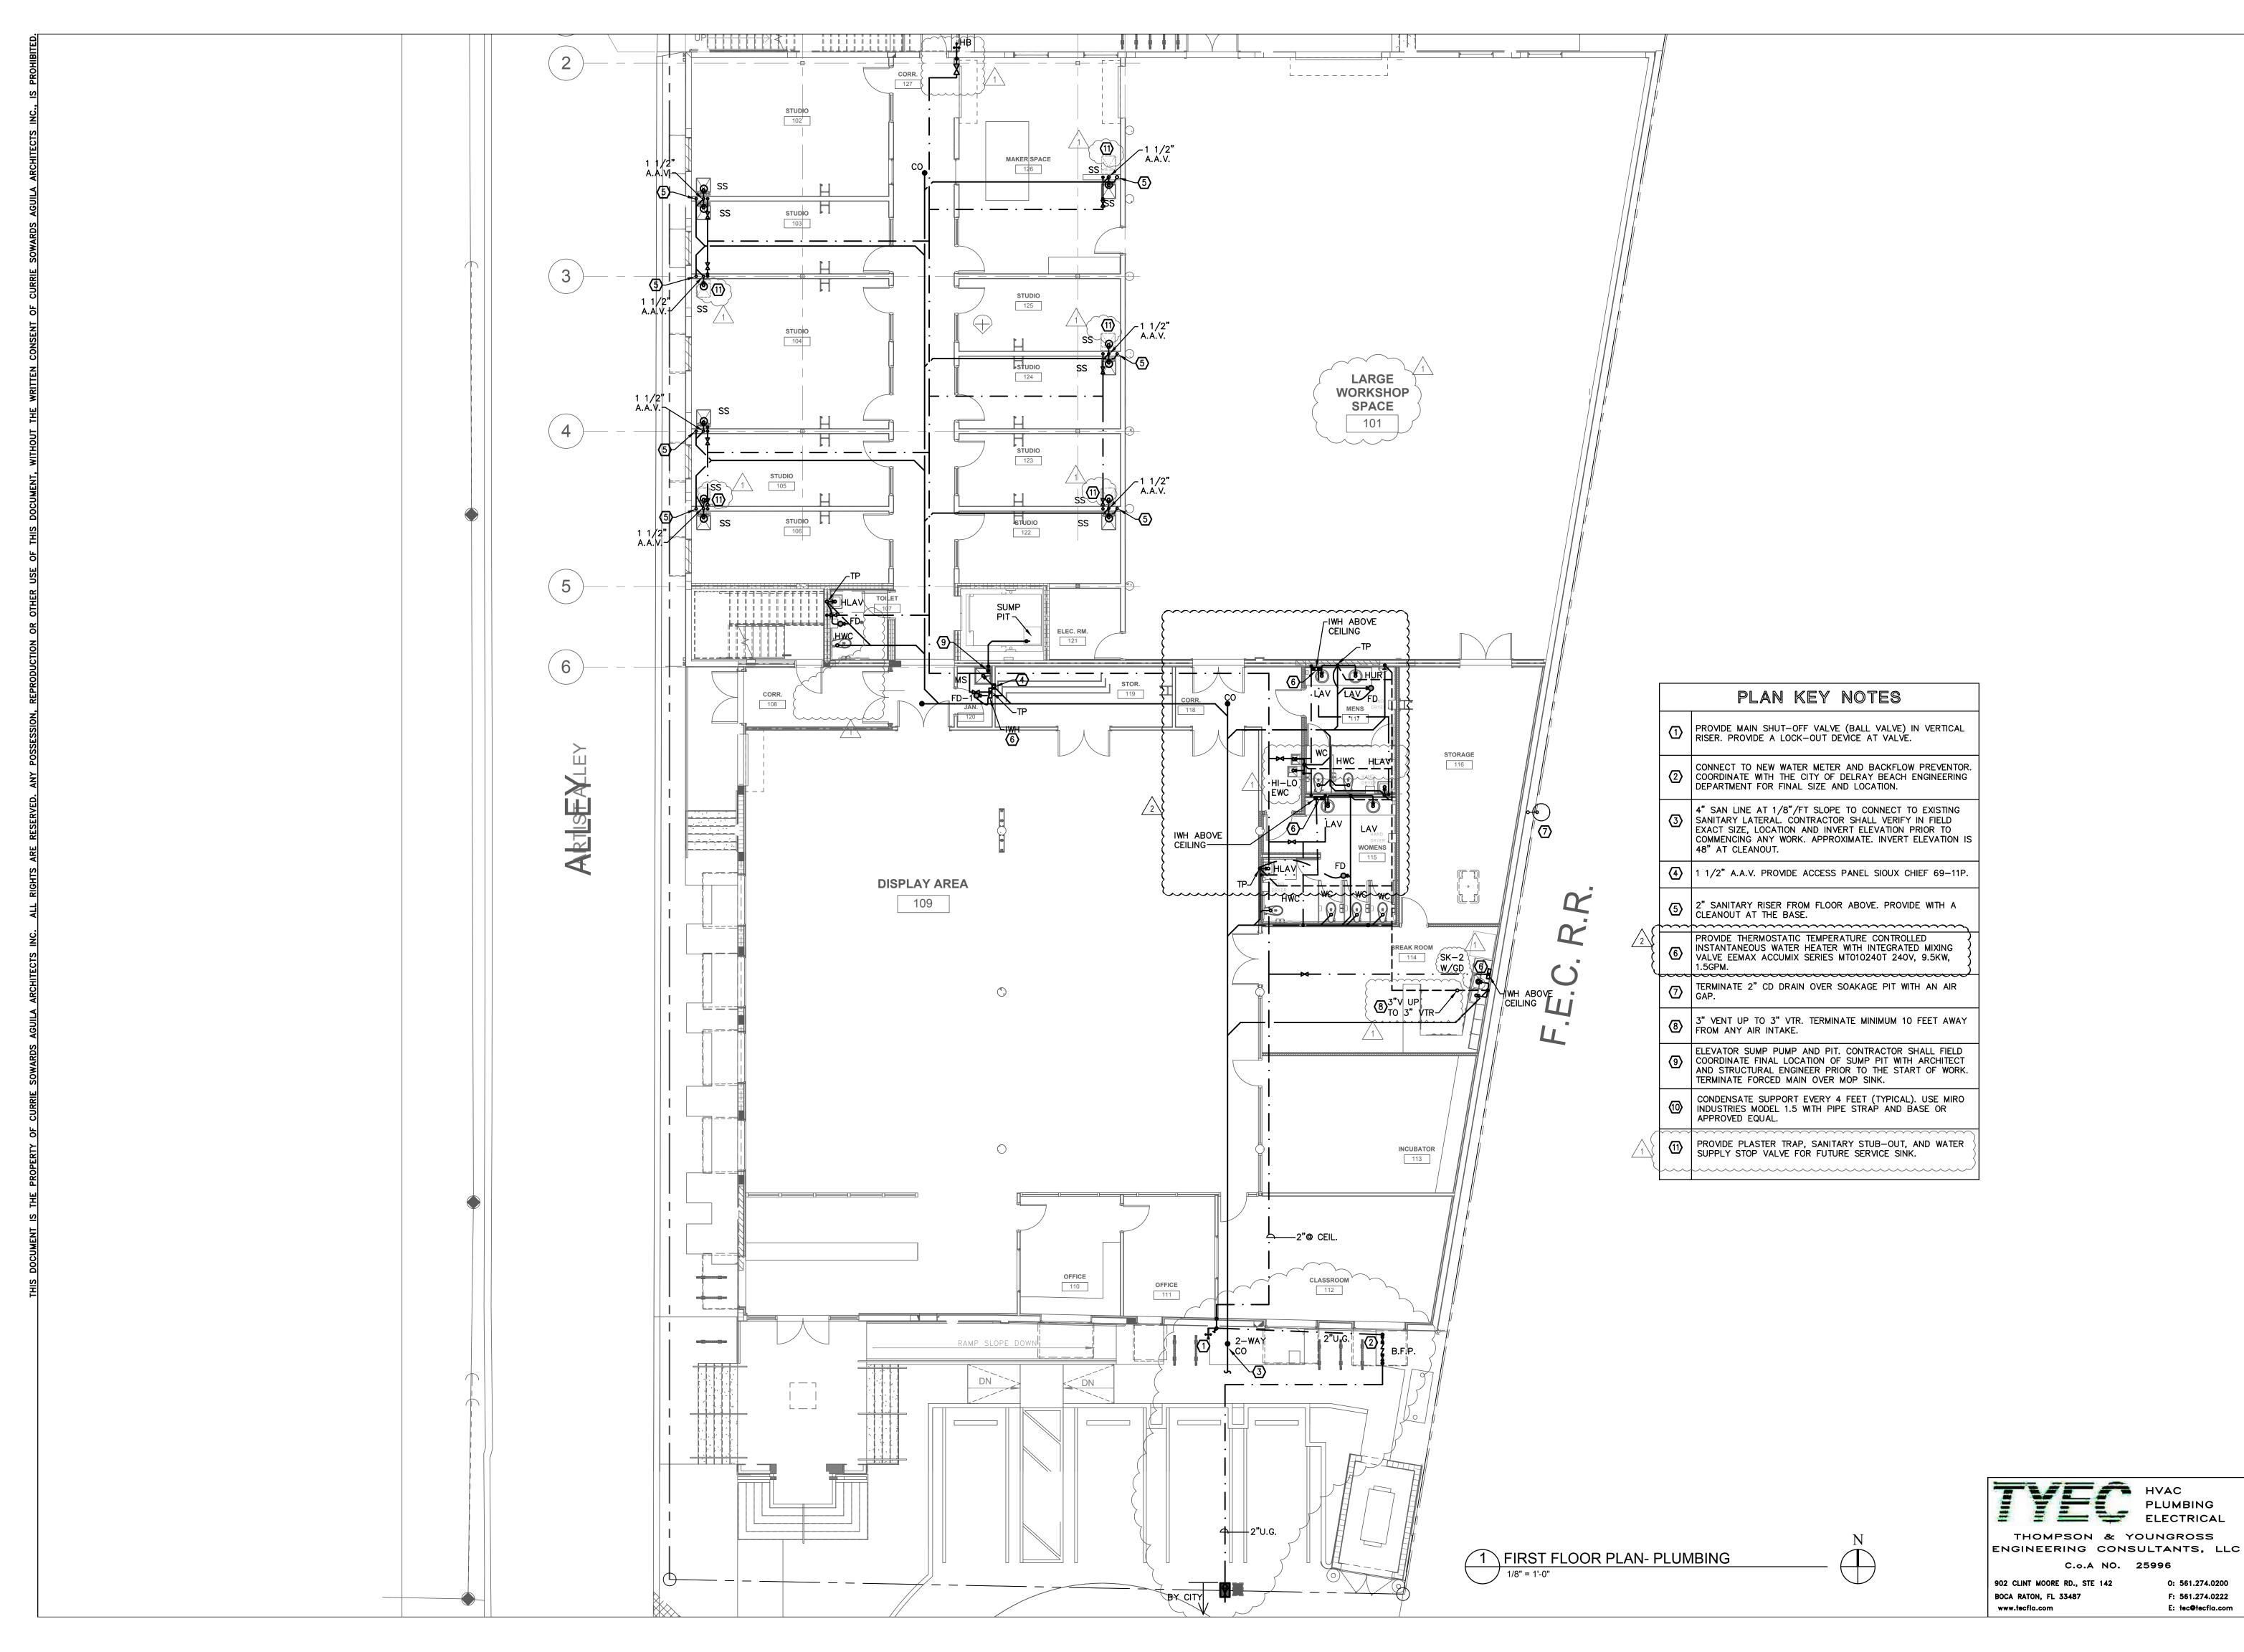

Architecture, Planning, Interiors, & Sustainable Design AA26001584

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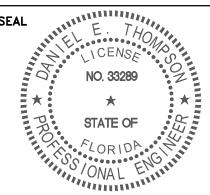
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Delray Bch. Florida, 33444

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REVISIONS

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1 Bldg. Dept. comments 08.21.15
2 Bldg. Dept. comments 10.26.15

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DRAWING TITLE

FIRST FLOOR PLAN

DILIMBING

FIRST FLOOR
PLUMBING

DATE DRAWN BY 06/25/2015 AA/MT/HL


JOB NUMBER

100701/15009

DRAWING NUMBER

0

P1.1

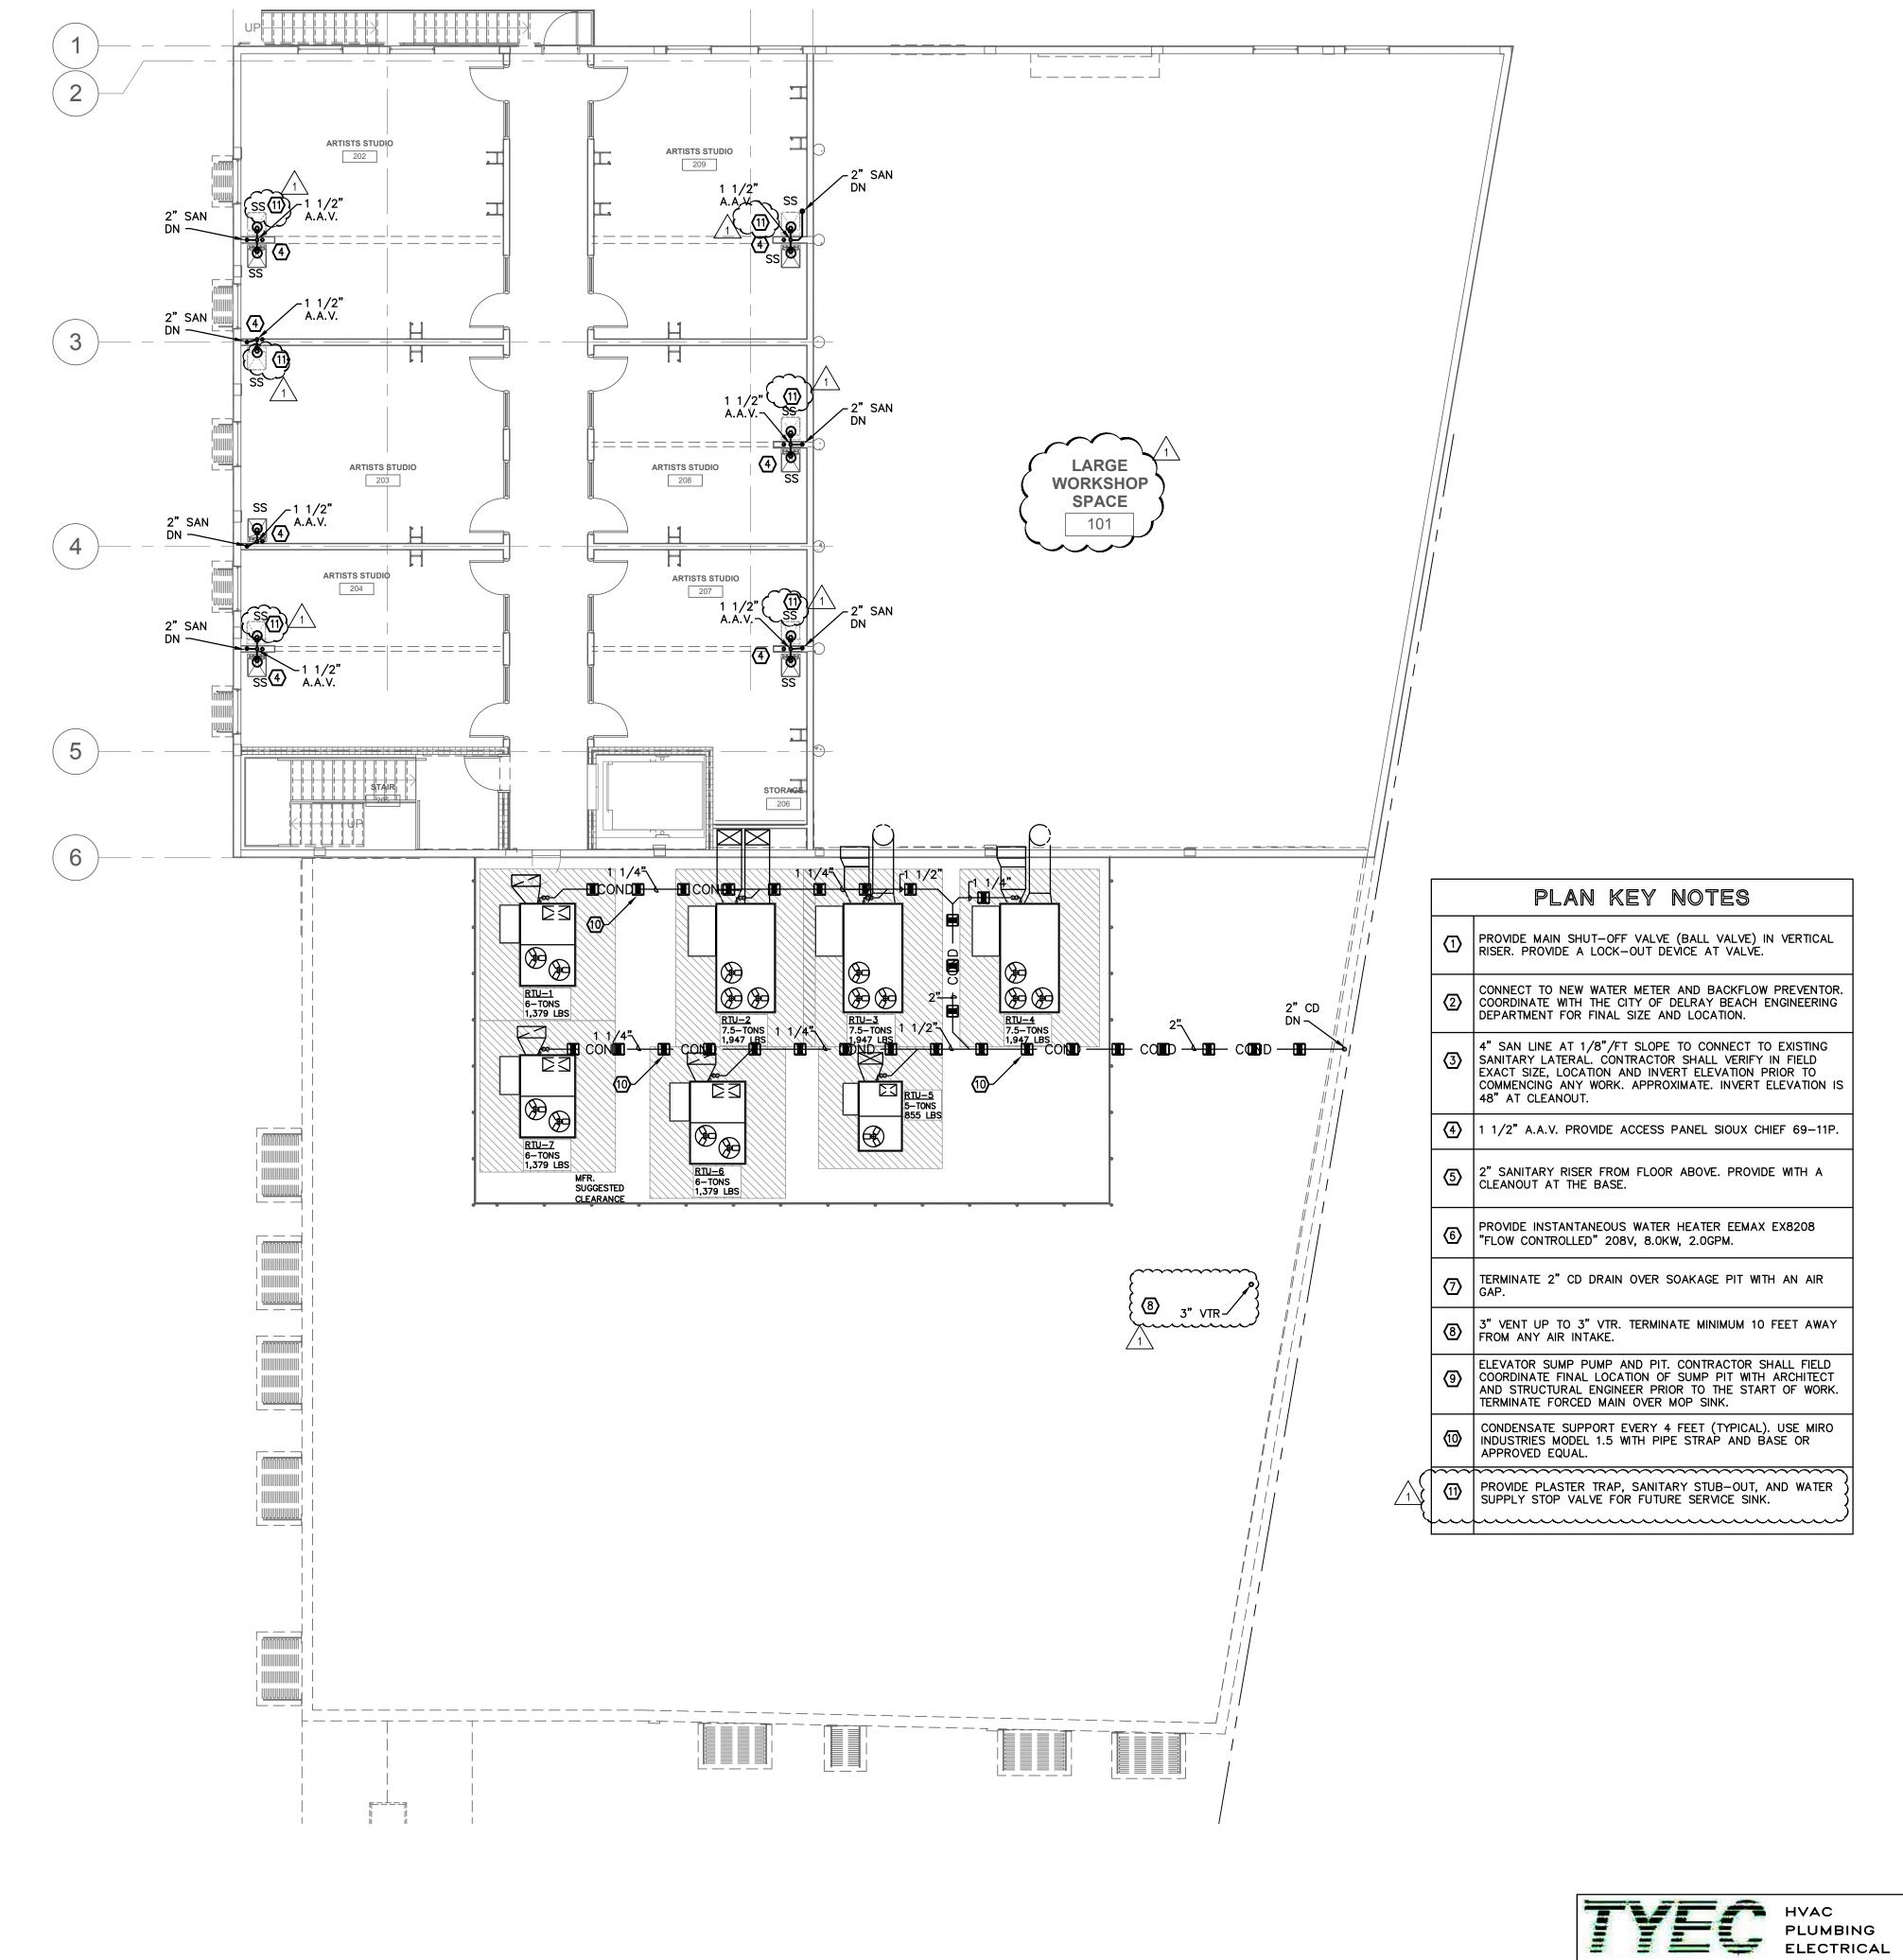

1 SECOND FLOOR PLAN- PLUMBING

/ 1/8" = 1'-0"



THOMPSON & YOUNGROSS

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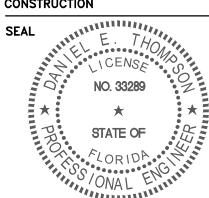
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PROJECT TITLE Art Warehouse

> 313 NE 3rd Street Delray Bch, Florida, 33444

REVISIONS


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1 Bldg. Dept. comments 08.21.15

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DRAWING TITLE **n** 2ND FLOOR PLAN 
 → PLUMBING


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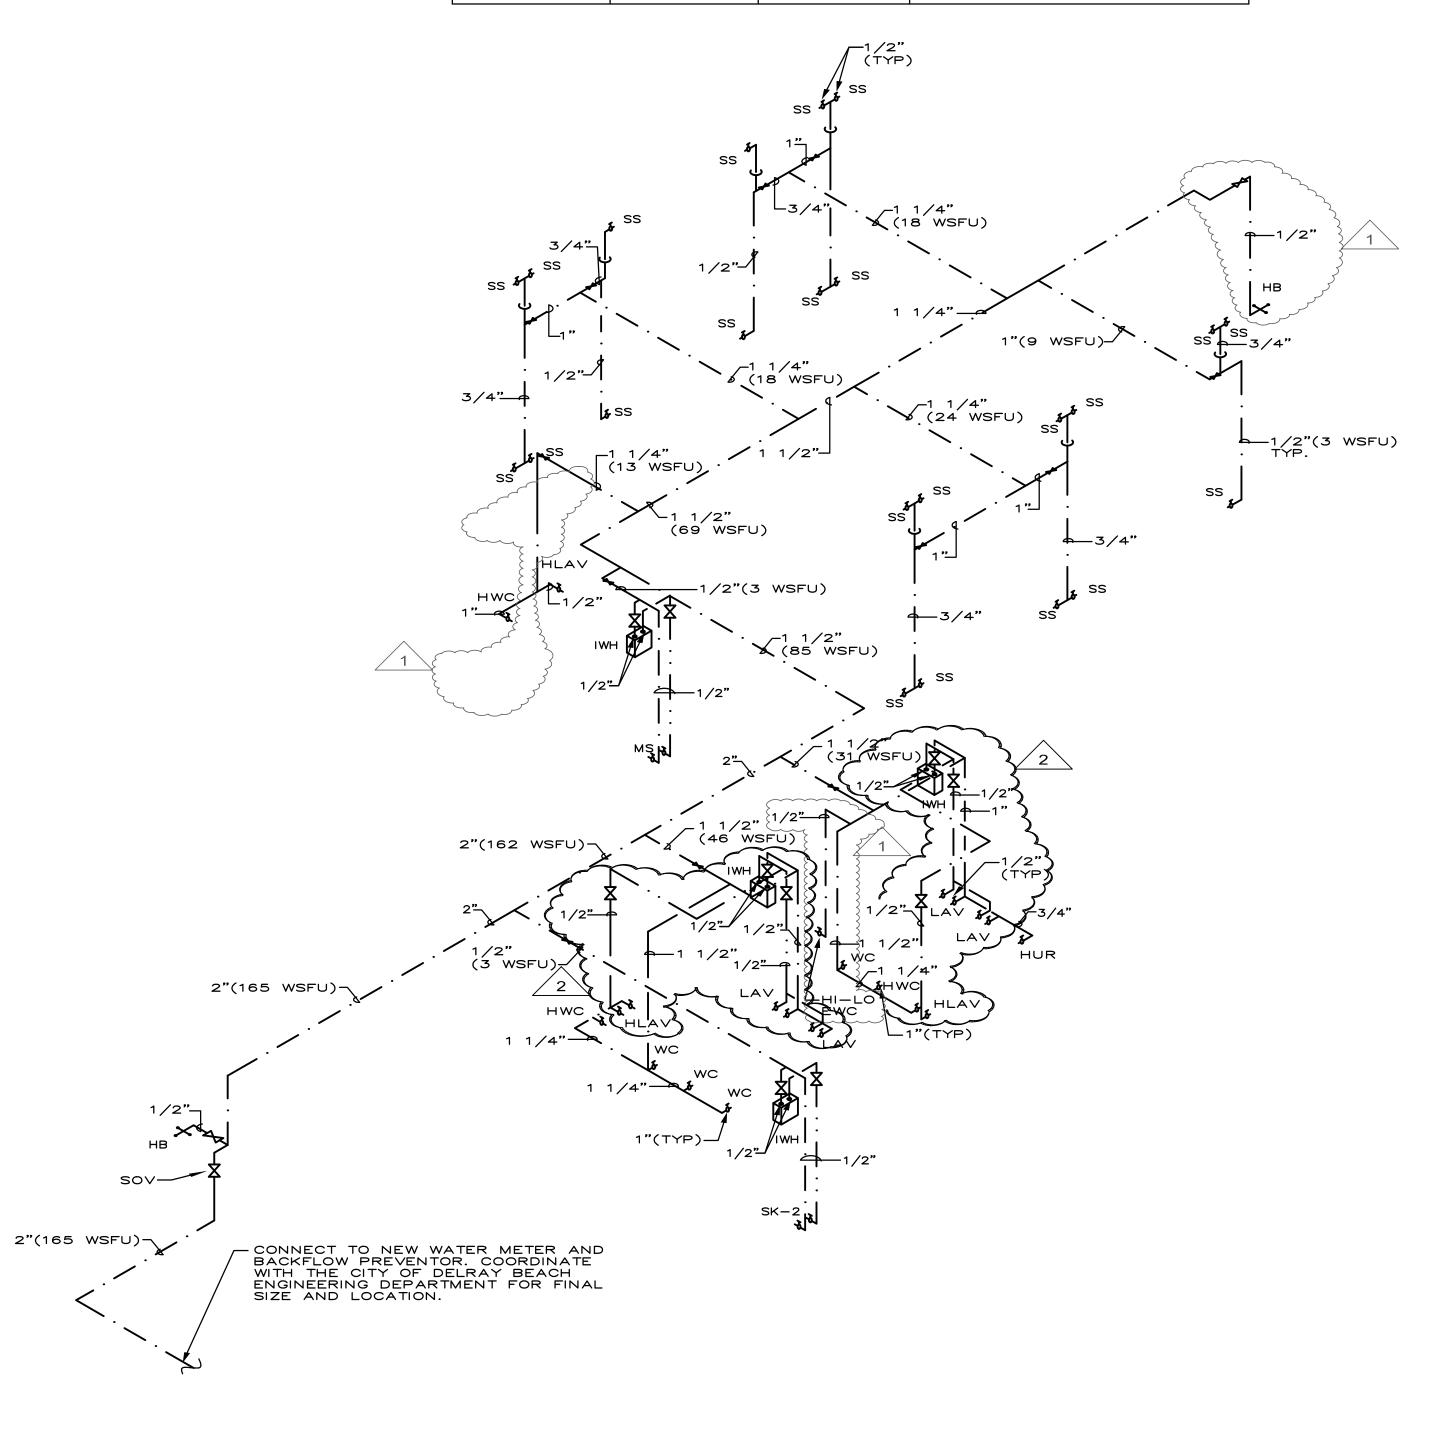
TYPICAL SERVICE SINK CONNECTION. (ORIENTATION MAY VARY)

N.T.S.

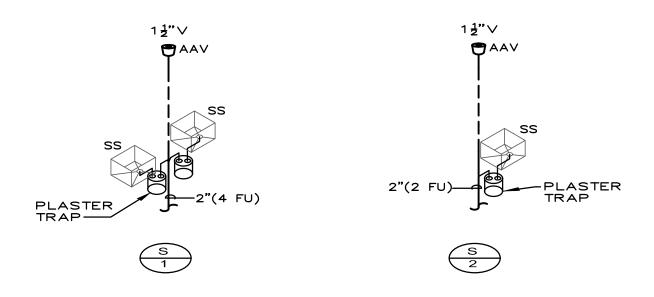

SANITARY WASTE ISOMETRIC DIAGRAM N.T.S.

WATER	HAMME	R ARRE	ster schedule
DESIGNATION	PDI UNIT	PIPE SIZE	MANUFACTURER
WHA-1	Α	1/2"	SIOUX CHIEF
WHA-2	В	3/4"	SIOUX CHIEF
WHA-3	С	1"	SIOUX CHIEF
WHA-4	D	1-1/4"	SIOUX CHIEF
WHA-5	E	1-1/2"	SIOUX CHIEF

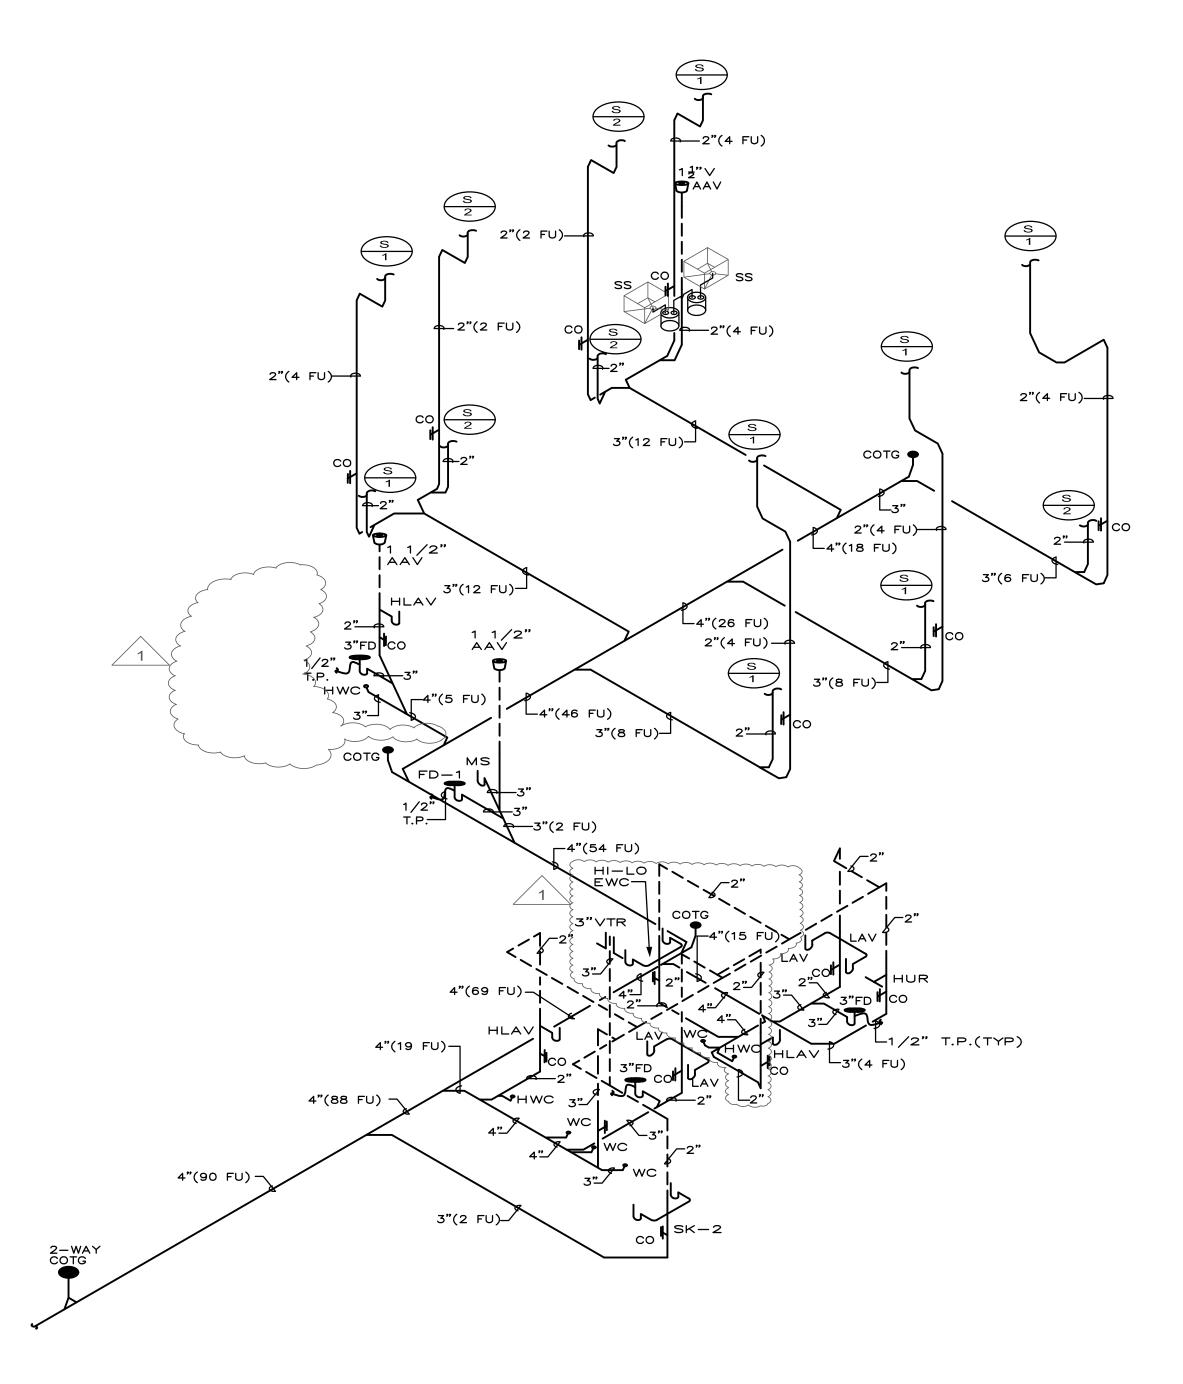

DOMESTIC WATER ISOMETRIC DIAGRAM N.T.S.



902 CLINT MOORE RD., STE 142 BOCA RATON, FL 33487 F: 561.274.0222

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# **CURRIE SOWARDS AGUILA** architects


Architecture, Planning, Interiors, & Sustainable Design AA26001584

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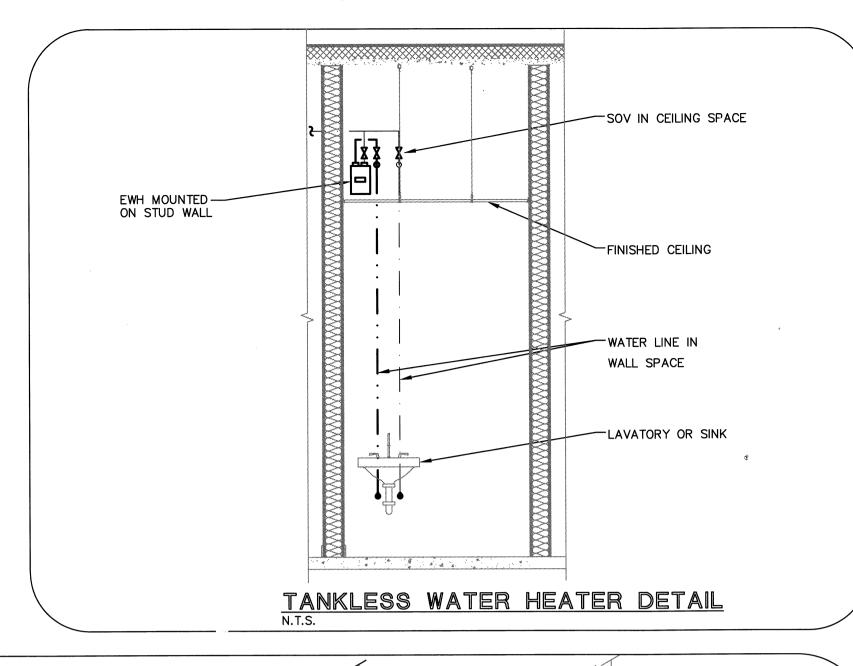
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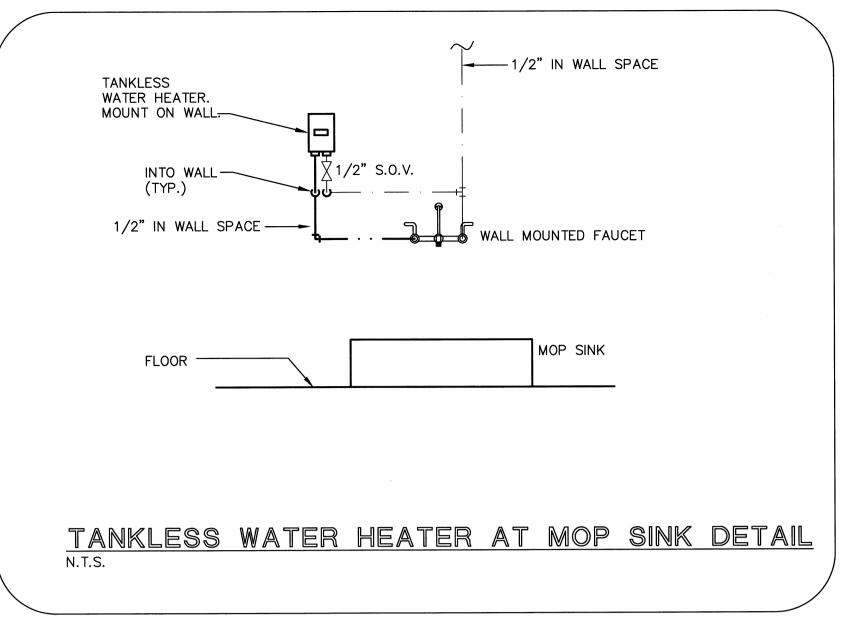
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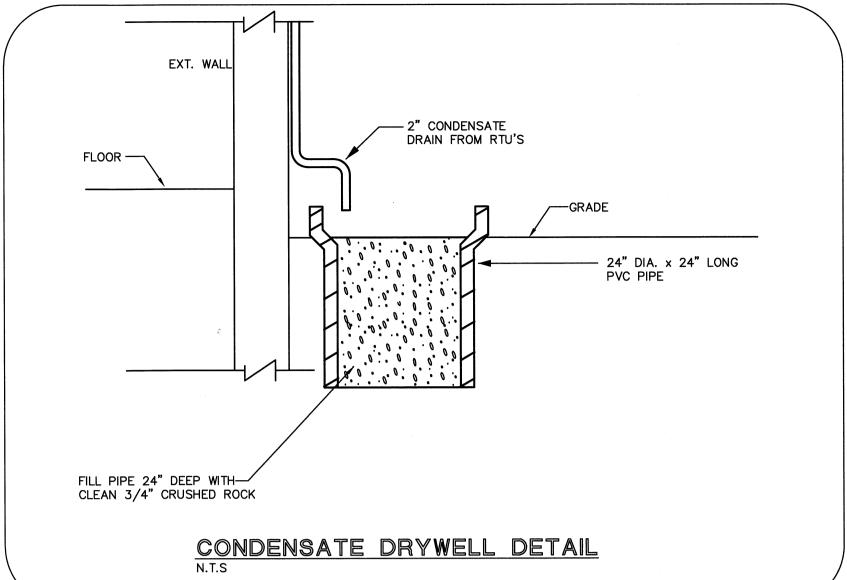
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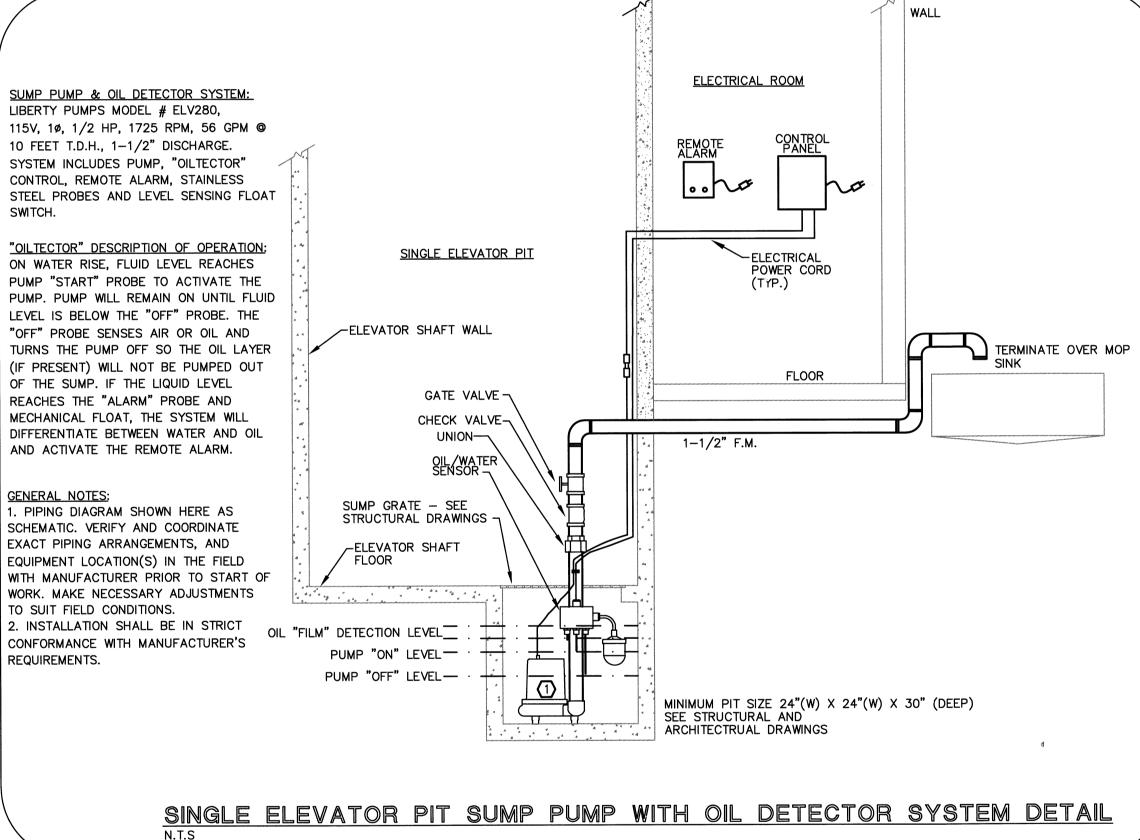
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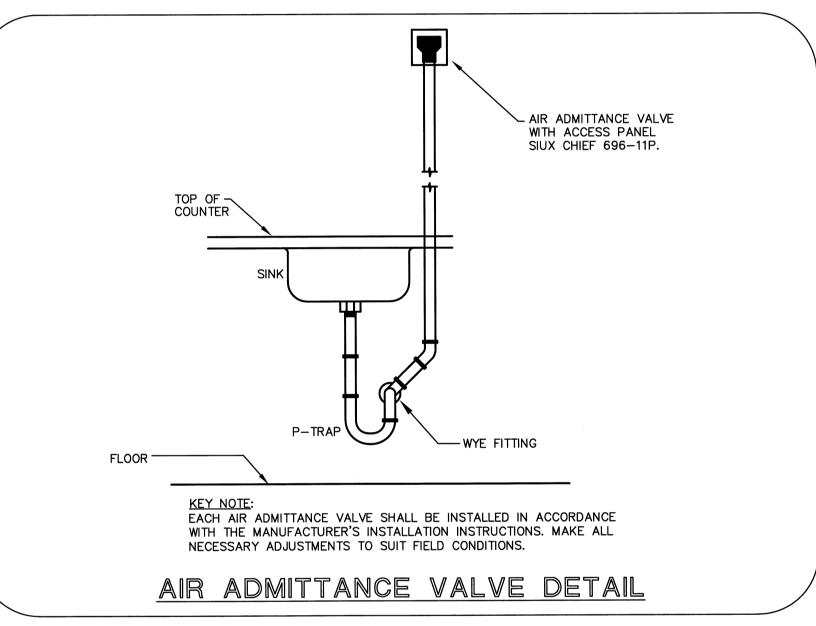
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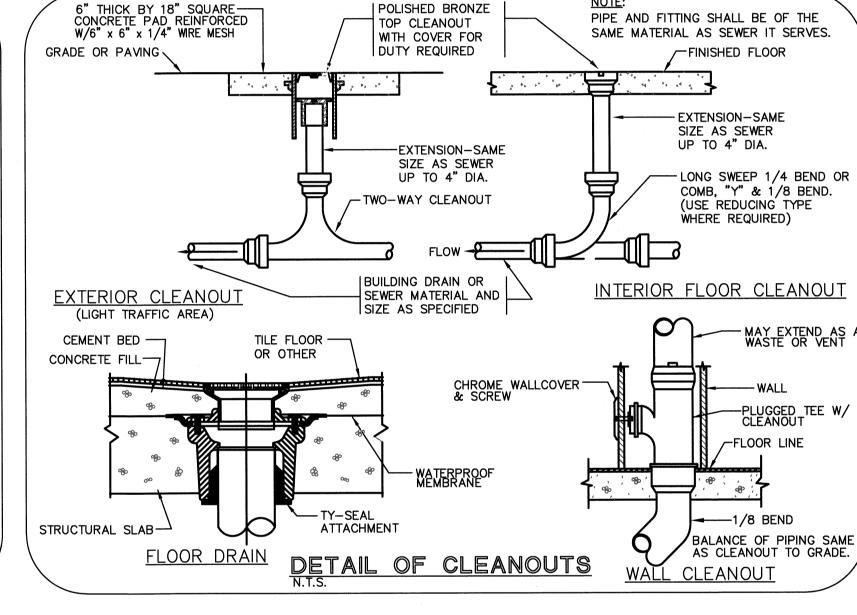











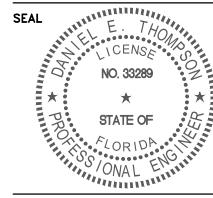



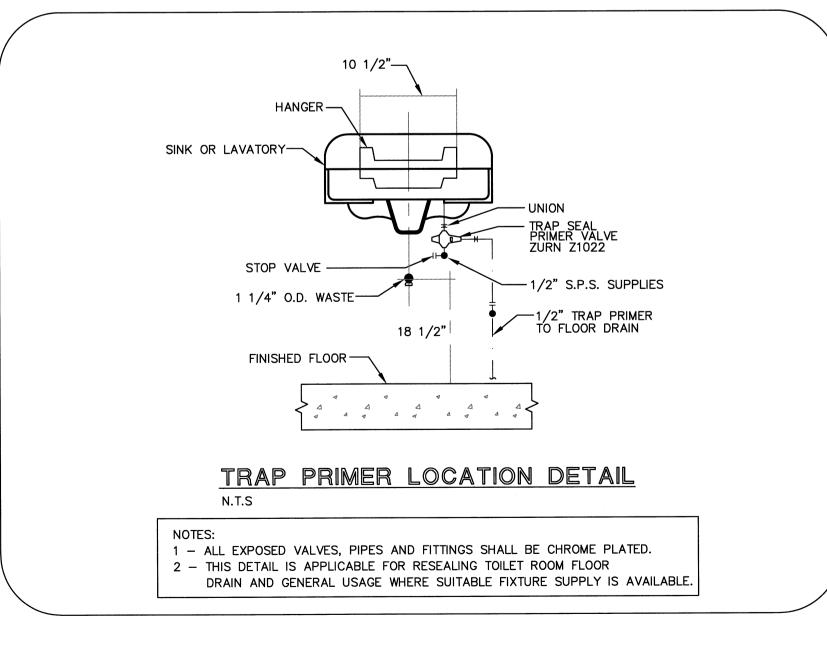

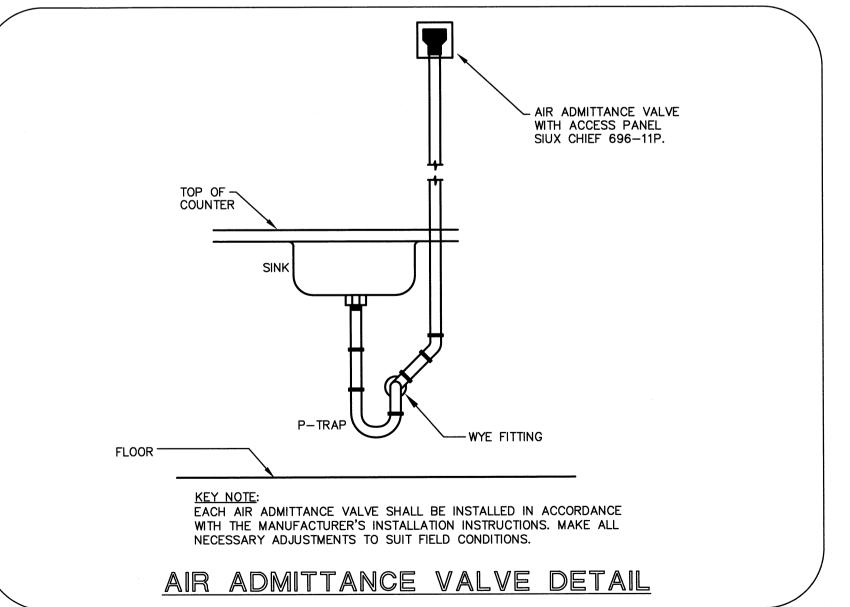

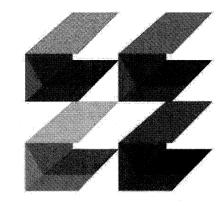

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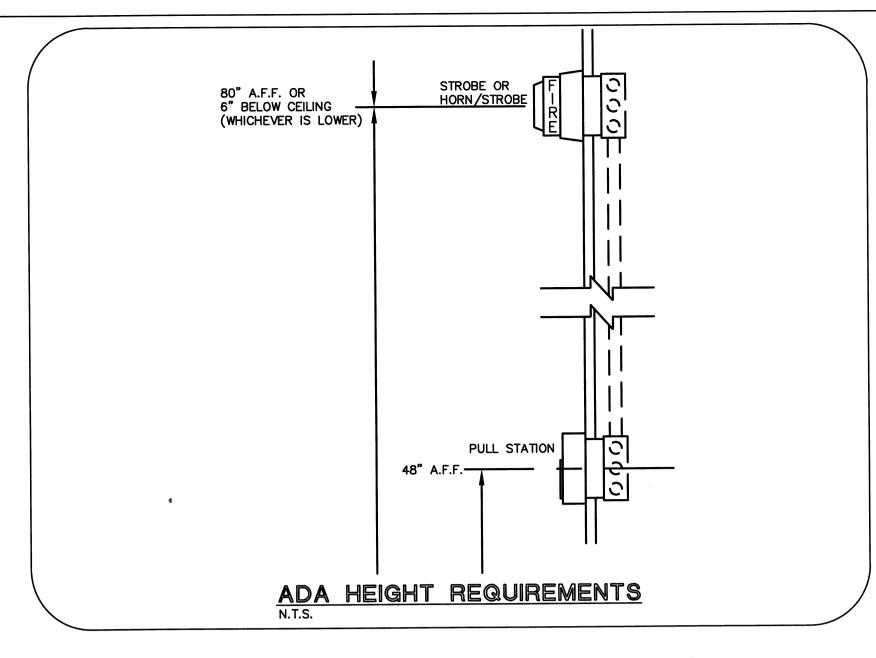
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PLUMBING THOMPSON & YOUNGROSS ENGINEERING CONSULTANTS, LLC C.o.A NO. 25996

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## FIRE ALARM SYSTEM SPECIFICATION

- 1. SYSTEM SHALL BE GENERAL ALARM, NON-CODED, ELECTRICALLY SUPERVISED, ADDRESSABLE, POWER LIMITED, BATTERY BACK-UP, TELEPHONE AUTO DIALER TO SEND SIGNALS TO CENTRAL STATION FACILITY, TROUBLE BELL, TROUBLE LIGHT, & SILENCING SWITCH. SLC CIRCUIT SHALL BE "CLASS B-STYLE 4", NOTIFICATION CIRCUIT SHALL BE "CLASS B-STYLE Y".
- 2. FIRE ALARM CONTROL PANEL SHALL BE NOTIFIER "NFS-320", INCLUDING ALL MODULES, CARDS, COMPONENTS REQUIRED FOR A FULLY OPERATIONAL SYSTEM. PANEL SHALL BE EXPANDABLE. FIRE ALARM ANNUNCIATOR PANEL SHALL BE NOTIFIER "LCD-80" (EXPANDABLE) WITH LED'S TO ANNUNCIATE BY FLOOR & LOCATION ALL MANUAL & AUTOMATIC DEVICES. EQUAL BRANDS ACCEPTABLE.
- 3. SUPPLEMENTARY APPLIANCE INDICATING PANEL SHALL HAVE TWO 1.25 AMP-24VOLT (30 VA) NOTIFICATION APPLIANCE CIRCUITS, WITH SELF-CONTAINED POWER AND 7 AMP-HOUR BACK-UP BATTERY CHARGER & BATTERIES.
- 4. EACH FIRE ALARM PANEL SHALL HAVE MAINTENANCE FREE BATTERY BACK-UP WITH MINIMUM 24 HOURS STANDBY AND ADDITIONAL 5 MINUTES ALARM. FIRE ALARM SUPPLIER/INSTALLER SHALL SUBMIT BATTERY CALCULATIONS BASED UPON DEVICES ACTUALLY INSTALLED FOR SHELL BLDG., AND PROVIDE FOR 100% SPARE CAPACITY FOR FUTURE DEVICES.
- 5. MAKE ALL SPLICES/CONNECTIONS ON TERMINAL STRIPS. TAPED OR WIRE NUT SPLICES NOT ALLOWED. WIRING COLOR CODE IS HIGHLY RECOMMENDED FOR EASE OF TERMINATIONS IF COLOR CODE IS NOT USED, LABEL WIRES WITH CORRESPONDING LETTER DESIGNATION.
- 6. AT START OF JOB AND PRIOR TO ANY INSTALLATION, SUBMIT COMPLETE WIRING DIAGRAMS INCLUDING WIRE AND CONDUIT SIZES, EQUIPMENT LISTS AND CATALOGUE CUTS OF EACH ITEM OF EQUIPMENT TO ARCHITECT AND TO LOCAL FIRE INSPECTION AUTHORITY FOR APPROVALS.
- 7. INSTALLER SHALL BE U.L. CERTIFIED + STATE LICENSED FIRE ALARM SYSTEMS CONTRACTOR. AT COMPLETION OF JOB, TEST SYSTEM IN PRESENCE OF FIRE INSPECTOR TO HIS SATISFACTION.
- 8. ALL WIRE COUNTS ARE BASED ON EQUIPMENT NEEDS.
  THE TYPE OF WIRE USED (SIZE, INSULATION, # OF STRANDS, ETC.)
  AND HOW IT IS INSTALLED IS THE SOLE RESPONSIBILITY
  OF THE ELECT. CONTRACTOR. IT MUST MEET ALL APPLICABLE CODES
  AND SPECIFICATIONS. ALL WIRE SHALL BE #14 THWN CU.
- 9. ALL CONDUIT SIZE SHALL BE 3/4", UNLESS NOTED OTHERWISE. THE INSTALLATION OF THE FIRE ALARM RACEWAY SYSTEM IS THE SOLE RESPONSIBILITY OF THE ELECTRICAL CONTRACTOR.
- 10. ALL COMPONENTS SHALL REFLECT 'UL' LISTING FOR FIRE SERVICE USE, MEET NFPA 72 REQUIREMENTS, AND SHALL BE COMPATIBLE. FIRE ALARM SYSTEM TO BE INSTALLED IN ACCORDANCE WITH NFPA
   11. A BREAK IN ANY FIELD WIRING OR GROUNDING OF ANY CONDUCTOR
- WILL RESULT IN THE ACTIVATION OF THE FIRE ALARM PANEL TROUBLE BUZZER, WHICH CAN BE SILENCED BY OPERATING THE "TROUBLE SILENCE" BUTTON ON THE FIRE ALARM PANEL.
- 12. PULL STATIONS TO BE MOUNTED AT 48" A.F.F. PER THE A.D.A. CODE.
- 13. WALL MOUNTED HORNS AND STROBES TO BE AT 80" TO BOTTOM OR 6" FROM CEILING WHICH EVER IS LOWER.
- 14. CEILING MOUNTED SMOKE DETECTORS SHALL BE LOCATED IN A DIRECT AIRFLOW, NOR CLOSER THAN 3 FEET FROM AN AIR SUPPLY DIFFUSER. NFPA 72 A-5-3.6.1 AND A-5-5.7.1.
- 15. THE CONTROL RELAY MODULE FOR RTU SHUTDOWN SHALL BE LOCATED WITHIN 3 FEET OF THE DEVICE BEING CONTROLLED. NFPA 101 A-7-6.5.5. THE RELAY CONTACTS HAVE A MAXIMUM CAPABILITY OF 1.0 AMPS @ 24V AND 0.3 AMPS AT 120VAC. CONTRACTOR MUST VERIFY THAT THE SHUTDOWN CIRCUIT DOES NOT EXCEED THESE MAXIMUM CURRENT RATINGS.
- 16. THE DUCT SMOKE DETECTOR AND REMOTE TEST IS PROVIDE BY THE FIRE ALARM CONTRACTOR. THE MECHANICAL CONTRACTOR IS RESPONSIBLE FOR THE INSTALLATION OF THE DUCT SMOKE DETECTOR IN THE DUCT WORK. THE FIRE ALARM CONTRACTOR IS RESPONSIBLE FOR ALL WIRING.
- 17. THE INSTALLING CONTRACTOR SHALL SET THE DEVICE ADDRESS AS
- 18. THE 120VAC POWER FEED FOR THE FIRE PANEL AND BOOSTER POWER SUPPLIES MUST BE FROM A DEDICATED EMERGENCY PANEL BREAKER, AND THE BREAKER MUST BE LOCKABLE, RED IN COLOR, AND IDENTIFIED THAT IT IS FOR THE 'FIRE ALARM SYSTEM'.
- 19. POWER UP AND POWER DOWN OF THE FIRE ALARM PANEL MUST BE DONE IN THE PROPER SEQUENCE:

  POWER DOWN: DISCONNECT THE BATTERY AND THEN TURN OFF THE BREAKER IN POWER PANEL.

  POWER UP: TURN ON THE BREAKER IN THE PANEL AND THEN CONNECT THE BATTERY.

  NOTE: DO NOT DISCONNECT THE 120VAC POWER FEED FROM THE TERMINAL BLOCK TO DISCONNECT POWER.

FIRE ALARM SYMBOL LIST FIRE ALARM SYSTEM SMOKE DETECTOR NOTIFIER # SDX-751 WITH NOTIFIER #B710LP BASE FIRE ALARM SYSTEM DUCT SMOKE DETECTOR NOTIFIER # DHX-502 HOUSING & NOTIFIER #SDX-551 DETECTOR FIRE ALARM SYSTEM HEAT DETECTOR - RATE-OF-RISE AND FIXED NOTIFIER # FDX-551R WITH NOTIFIER # BX-501 BASE. FIRE ALARM SYSTEM ADDRESSABLE PULL STATION NOTIFIER # BGX101-L FIRE ALARM SYSTEM STROBE LIGHT, 75cd.
NOTIFIER # ST-24-15/75WR, A.D.A. COMPLIANT. FIRE ALARM SYSTEM STROBE LIGHT, 110cd NOTIFIER # ST-24-110WR, A.D.A. COMPLIANT. FIRE ALARM SYSTEM COMBINATION HORN/STROBE LIGHT, 75cd OR 110cd NOTIFIER # HS-24-75/110WR, A.D.A. COMPLIANT FIRE ALARM SYSTEM WATER FLOW SWITCH. SWITCH PROVIDED BY MECHANICAL CONTRACTOR. FIRE ALARM SYSTEM TAMPER SWITCH SWITCH PROVIDED BY MECHANICAL CONTRACTOR. FIRE ALARM SYSTEM REMOTE TEST STATION NOTIFIER #RTS451 FIRE ALARM SYSTEM ADDRESSABLE MONITOR MODULE. NOTIFIER #MMX101 FIRE ALARM SYSTEM ADDRESSABLE SIGNAL/CONTROL MODULE. NOTIFIER #CMX-2 FIRE ALARM SYSTEM DIGITAL COMMUNICATOR NOTIFIER #UDACT FIRE ALARM SYSTEM ELEVATOR STATUS/RECALL SWITCH FIRE ALARM SYSTEM CONTROL PANEL; NOTIFIER NFS-320 PROVIDE NOTIFIER AH BATTERIES. FIRE ALARM SYSTEM ANNUNCIATOR PANEL NOTIFIER # LCD-80, PROVIDE ANNUNCIATOR EXPANDER AS REQUIRED KNOX BOX (FURNISHED & INSTALLED BY GENERAL CONTRACTOR, SHOWN

90 MINUTE BATTERY

EMERGENCY LIGHT - 90 MIN. BATTERY

BACKFLOW PREVENTER - DOUBLE CHECK TYPE.

FOR COORDINATION PURPOSES ONLY.)

# FIRE ALARM WIRE SCHEDULE (FIRE ALARM SYSTEM SHALL BE POWER LIMITED)

EXIT SIGN - 90 MINUTE BATTERY (SEE LIGHTING PLAN)

COMBO EXIT SIGN + EMERGENCY LIGHT (SEE LIGHTING PLAN)

2#14 AWG THHN SOLID WRE FOR HORN AND STROBES, YELLOW (+) & BROWN (-)
2#12 AWG THHN SOLID WRE FOR HORN AND STROBES, YELLOW (+) & BROWN (-)
16-2 WRE FPL FOR DATA COMMUNICATION; BLACK JACKET
1#12 AWG THHN STR WRE FOR GROUND; GREEN JACKET

#### SEQUENCE OF OPERATION

1.) THE FIRST ACTIVATION OF ANY MANUAL FIRE ALARM PULL STATION, OR THE AUTOMATIC ACTUATION OF ANY THERMAL DETECTOR, SMOKE DETECTOR, OR ANY OTHER APPROVED ALARM INITIATING DEVICE SHALL IMMEDIATELY RESULT IN THE FOLLOWING:

2#12 AWG THHN STR WIRE FOR POWER SUPPLY AND PANEL POWER;

A. NOTIFY THE OWNER'S MONITORING SERVICE.

RËD JACKET (+) AND BLACK (-)

- B. THE EVACUATION SIGNAL SHALL BE A HORN TONE, ELECTRONICALLY GENERATED UNTIL SIGNALS ARE SILENCED. WHEN SIGNALS ARE SILENCED THE VISUAL ALARM DEVICES SHALL ALSO BE EXTINGUISHED.
- C. ALL A.D.A. VISIBLE ALARM INDICATING APPLIANCES SHALL FLASH AT A SYNCHRONIZED RATE CONTINUOUSLY UNTIL THE SYSTEM IS RESET OR SILENCED.

  D. ALARM INDICATING APPLIANCES SHALL SOUND ALARM THROUGHOUT THE BUILDING IN GENERAL
- D. ALARM INDICATING APPLIANCES SHALL SOUND ALARM THROUGHOUT THE BUILDING IN GENERAL ALARM UNLESS SILENCED AT MAIN PANEL.
- E. ANY SUBSEQUENT ZONE ALARM SHALL REACTIVATE THE ALARM INDICATING APPLIANCES.

  F. THE SYSTEM ALARM LED SHALL FLASH ON THE DISPLAY UNIT. THE SYSTEM ALARM LED SHALL FLASH ON THE CONTROL PANEL UNTIL THE ALARM HAS BEEN ACKNOWLEDGED. ONCE ACKNOWLEDGED, THIS SAME LED SHALL LATCH ON. A SUBSEQUENT ALARM RECEIVED FROM ANOTHER ZONE SHALL FLASH THE SYSTEM ALARM LED ON THE CONTROL PANEL. THE LCD DISPLAY SHALL SHOW THE NEW ALARM INFORMATION.
- G. 1.) ACTIVATION OF 1ST FLOOR ELEVATOR SMOKE DETECTOR TO RECALL ELEVATOR TO 2ND FLOOR.
  2.) ACTIVATION OF 2ND FLR., 3RD FLR., OR ELEV. MACH. RM. ELEVATOR SMOKE DETECTORS TO RECALL ELEVATOR TO 1ST FLOOR.
- 3.) ACTIVATION OF ELEVATOR HEAT DETECTORS TO RECALL ELEVATOR TO FIRST FLOOR.

  H. NO MAGNETIC DOOR HOLDER OR SMOKE DOORS IN THIS BUILDING
- 2.) RECEIPT OF SPRINKLER WATER FLOW SIGNAL:
- A. WATER FLOW ALARM ANNUNCIATION AT FACP.

  B. WATER FLOW ALARM COMMUNICATED TO CENTRAL STATION.
- C. LOCAL HORN/STROBE DEVICES ACTIVATE THROUGHOUT PROTECTED SPACE/BUILDING AND WILL NOT BE SILENCED UNTIL WATERFLOW CONDITIONED IS CLEARED.
- 3.) ACTIVATION OF SUPERVISORY CONDITION:
- ACTIVATION OF SUPERVISORY CONDITION:

  A. ANNUNCIATION OF SUPERVISORY ALARM AT FACP.
- B. DEVICE ADDRESS AND SUPERVISORY ALARM CONDITION INDICATED AT FACP.
- C. SUPERVISORY SIGNAL TRANSMITTED TO CENTRAL MONITORING STATION.

  D. DUCT DETECTORS WILL CAUSE SUPERVISORY SIGNAL.
- D. DOCT DETECTORS WILL CAUSE SUFE
- 4.) ACTIVATION OF ANY TROUBLE CONDITION:
- A. TROUBLE SIGNAL TRANSMITTED TO CUSTOMERS CENTRAL MONITORING STATION.
  B. ANNUNCIATION OF TROUBLE ALARM AT FACP.
  C. DEVICE ADDRESS AND TROUBLE ALARM CONDITION INDICATED AT FACP.

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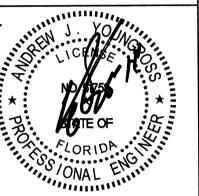
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PERMIT 06/25/2015
CONSTRUCTION



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FILE NUMBER

15009\_FA

DRAWING TITLE

FIRE ALARM

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DRAWING TITLE

FIRE ALARM

NOTES & LEGEND

DATE DRAWN BY

06/25/2015 AA/MT/HL

JOB NUMBER

100701/15009

DRAWING NUMBER

FA-0.1 FIRE ALARM NOTES & LEGEND

FA-1.1 FIRST FLOOR FIRE ALARM PLAN

FA-1.2 SECOND FLOOR FIRE ALARM PLAN

FA-1.3 FIRE ALARM PLAN

FA-1.4 FIRE ALARM NOTES & LEGEND

FA-1.5 FIRE ALARM NOTES & LEGEND

FA-1.6 FIRE ALARM NOTES & LEGEND

FA-1.7 FIRE ALARM PLAN

FA-1.8 FIRE ALARM PLAN

FA-1.9 FIRE ALARM PLAN

FA-1.1 FIRE ALARM PLAN

FA-1.1 FIRE ALARM PLAN

FA-1.2 SECOND FLOOR FIRE ALARM PLAN

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FA-1.7 FIRE ALARM

C.o.A NO. 25996

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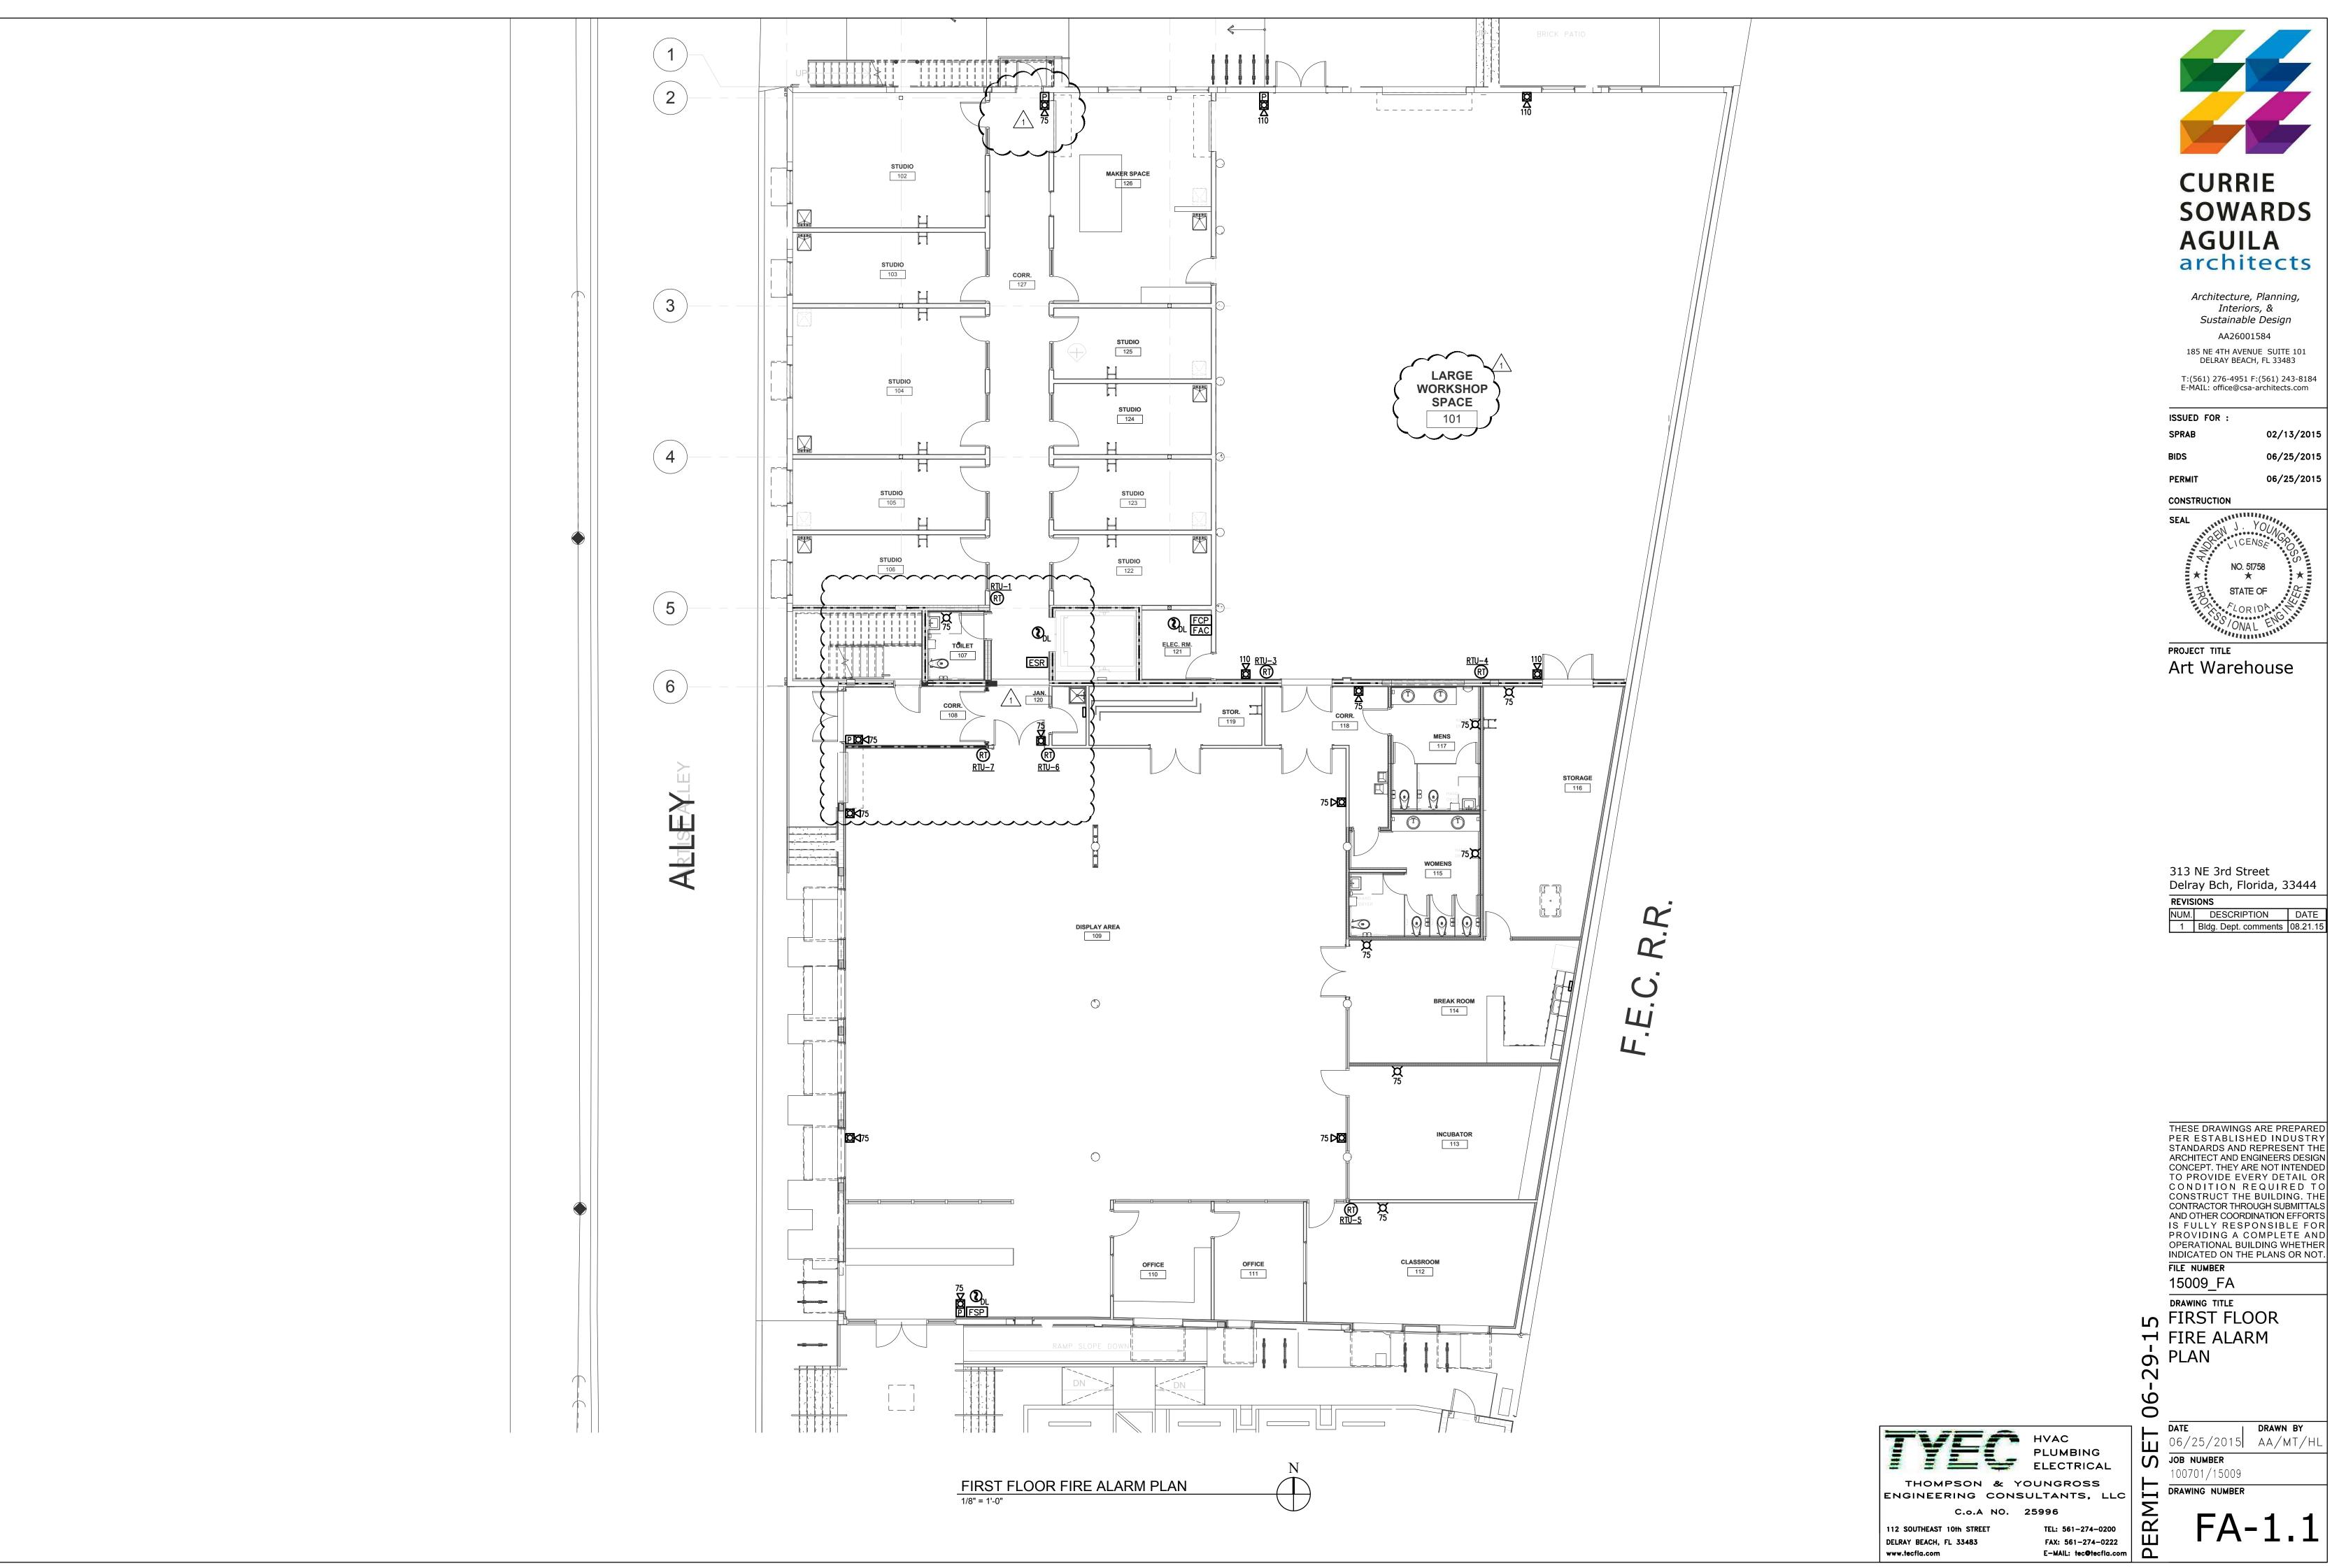
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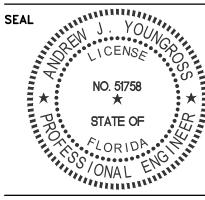
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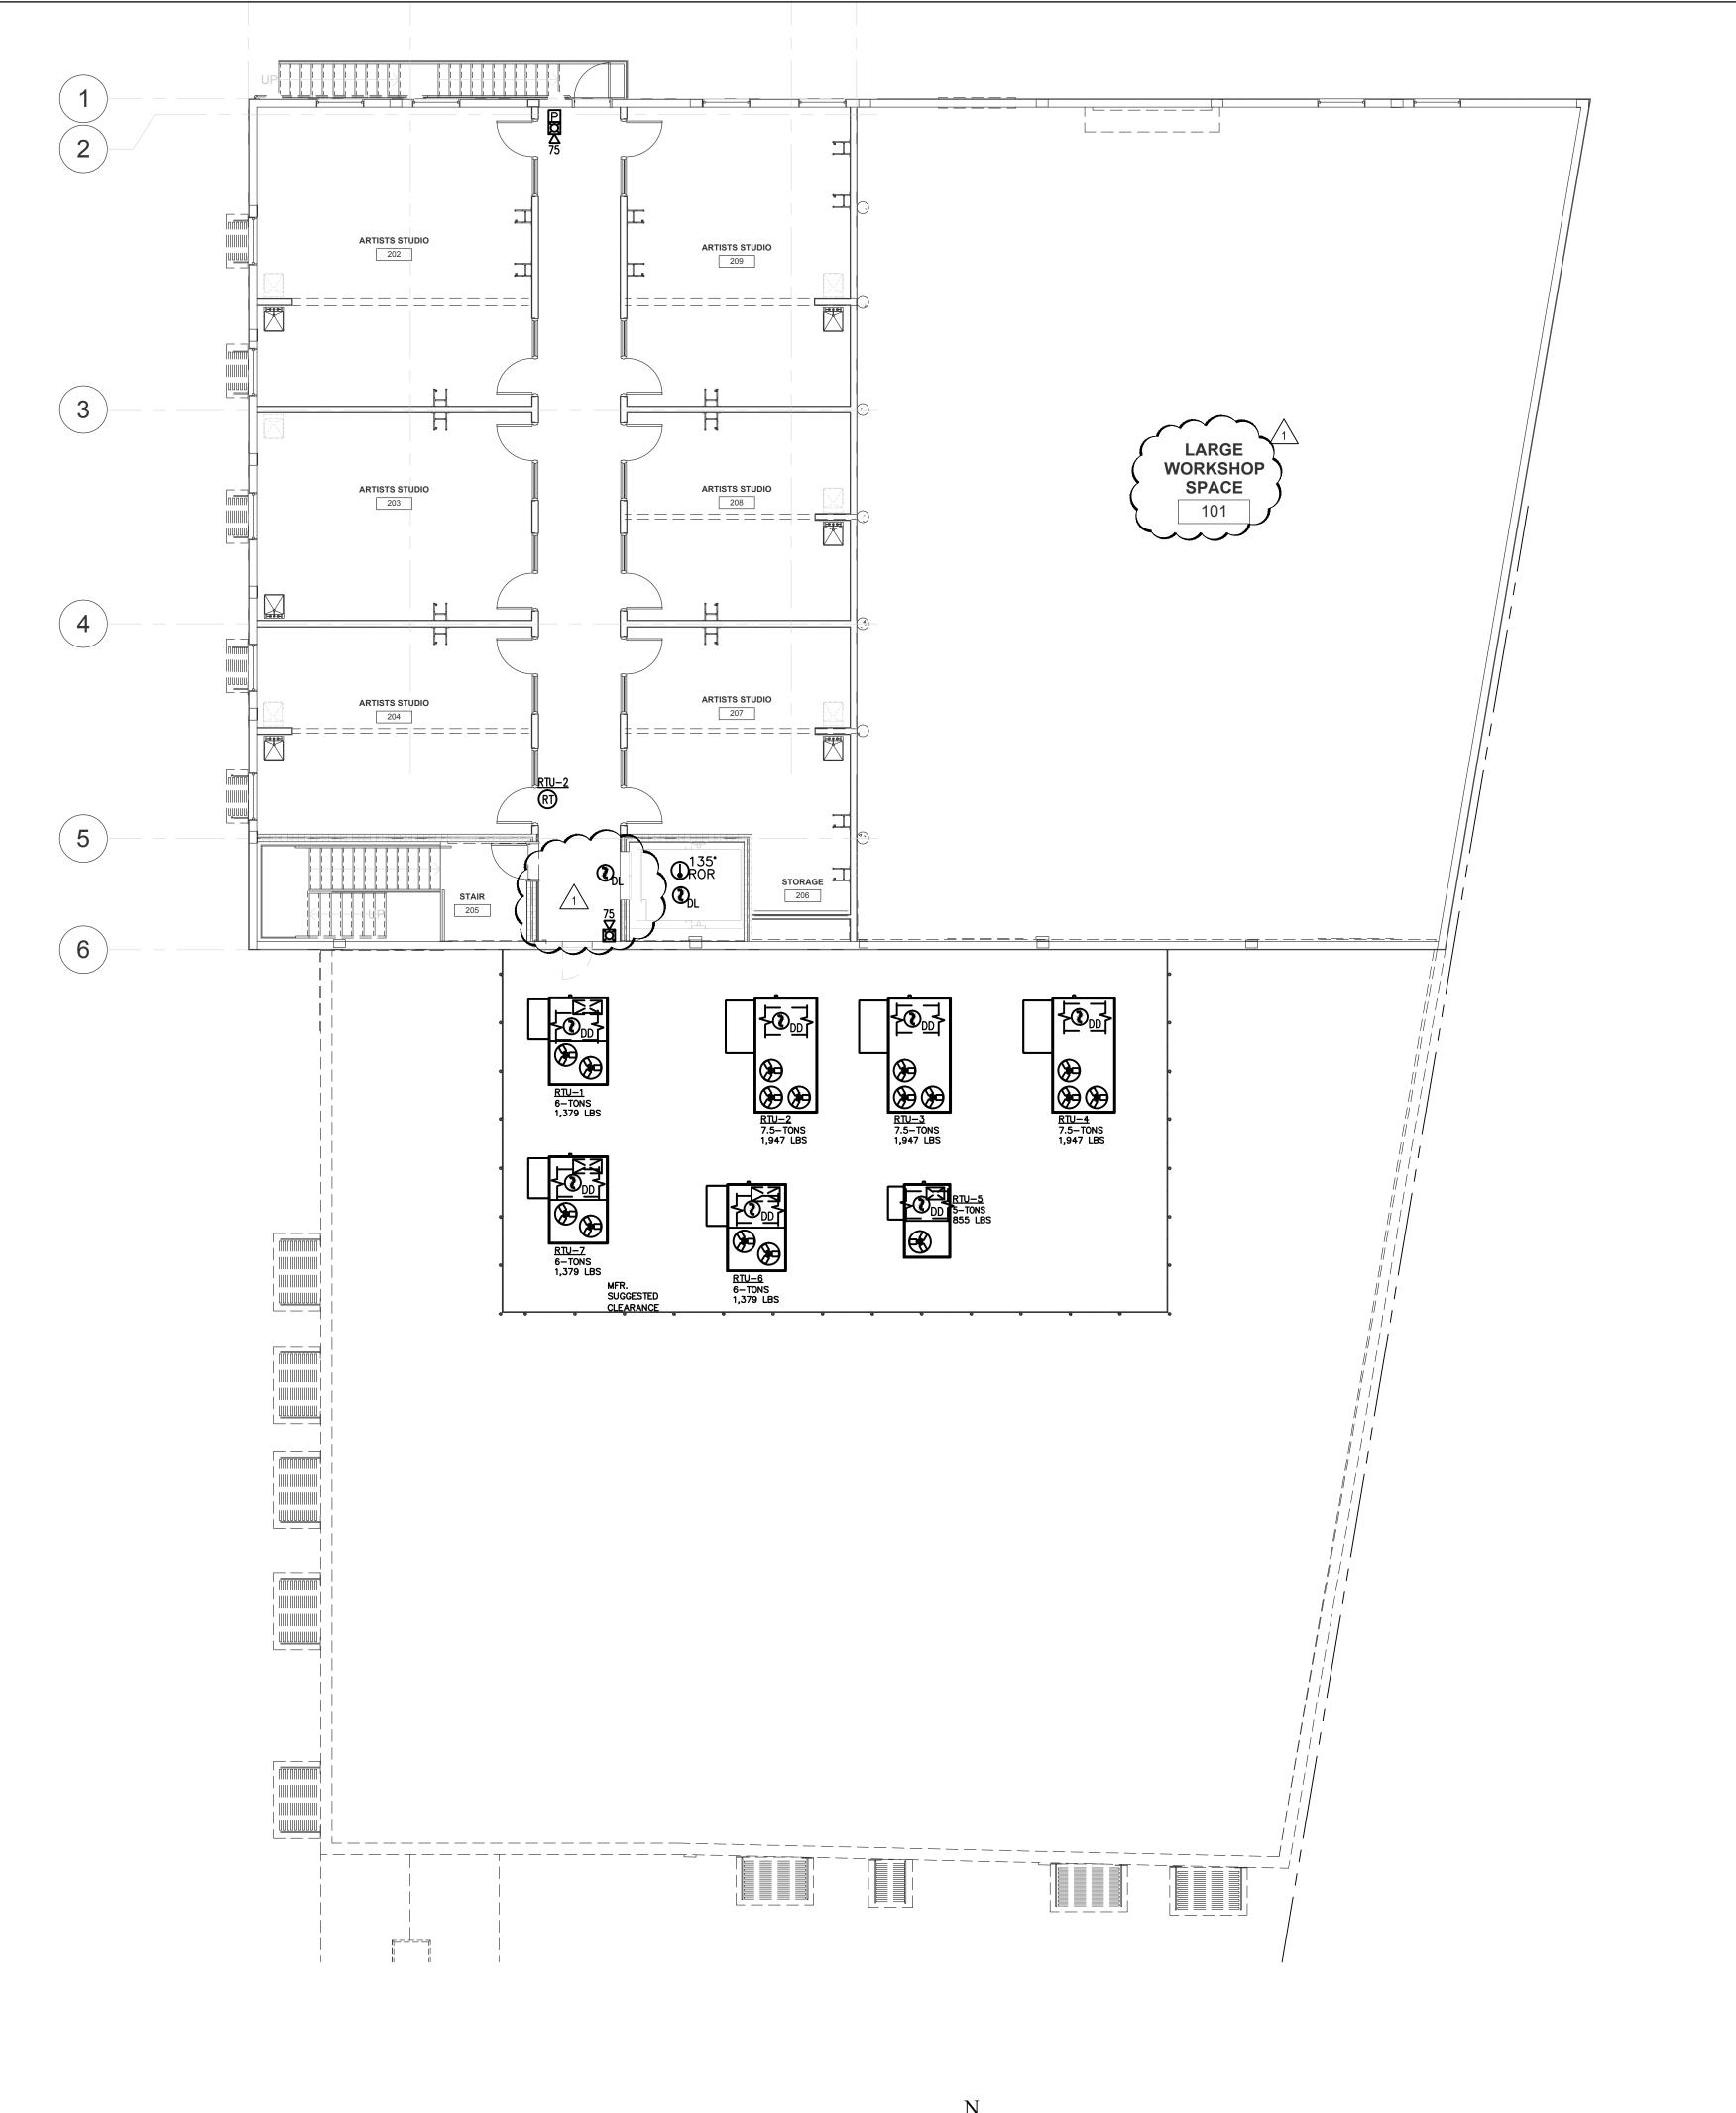
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☐ FIRST FLOOR FIRE ALARM

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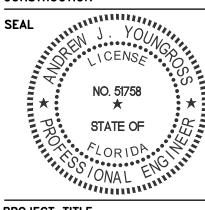
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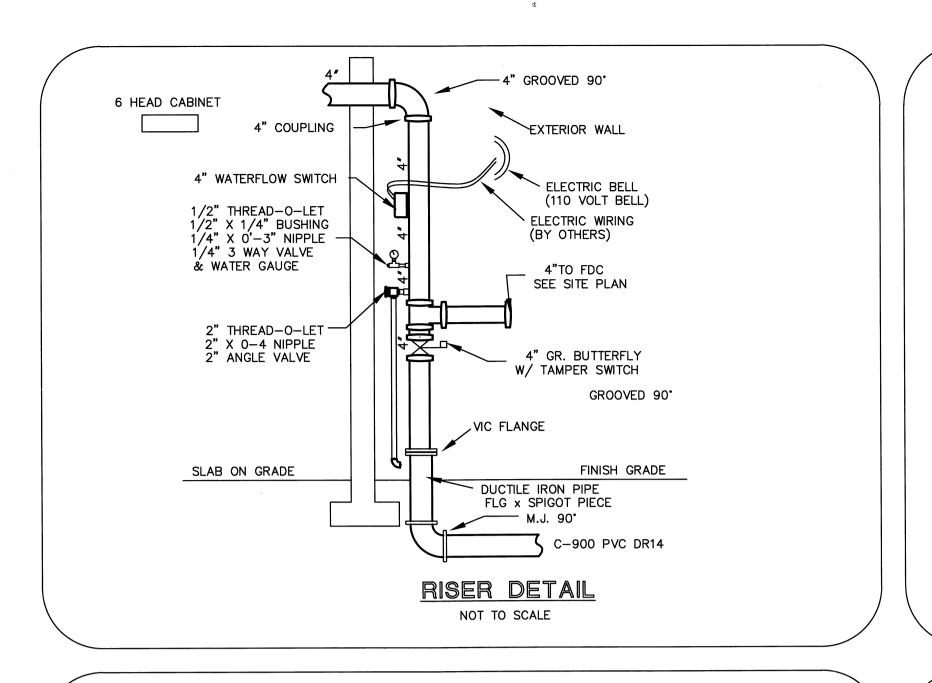
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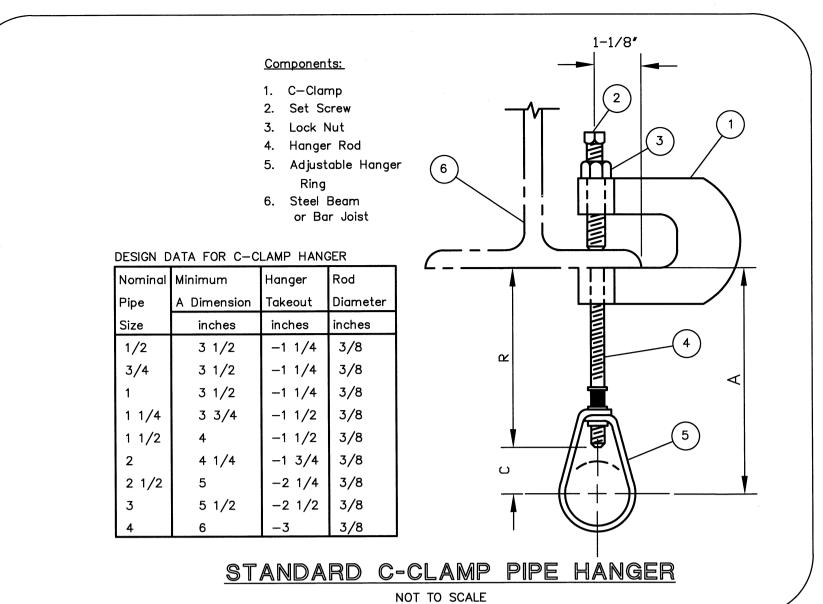
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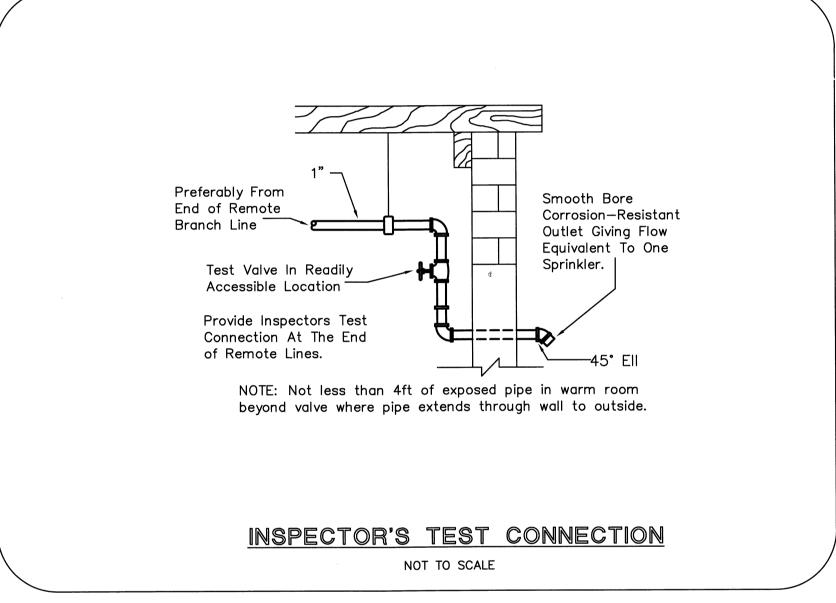
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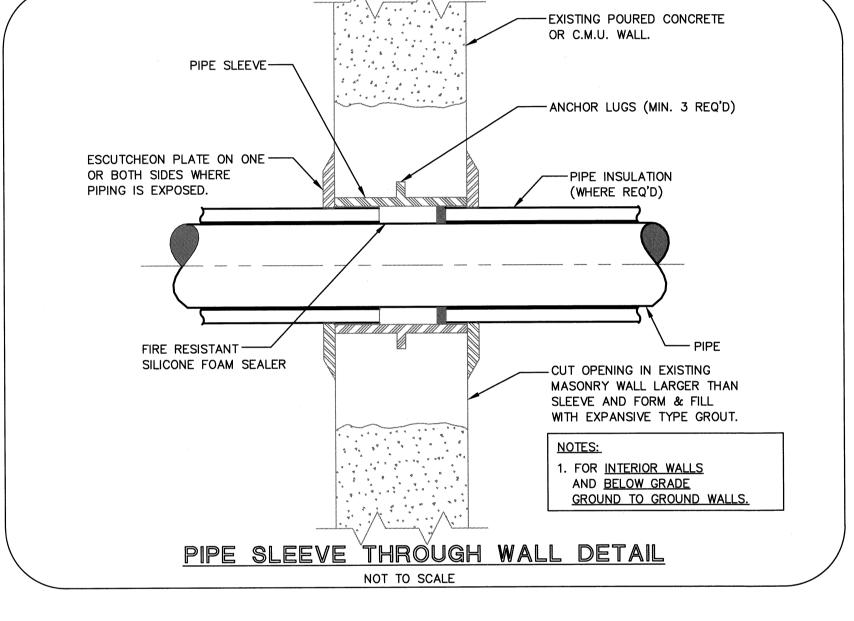
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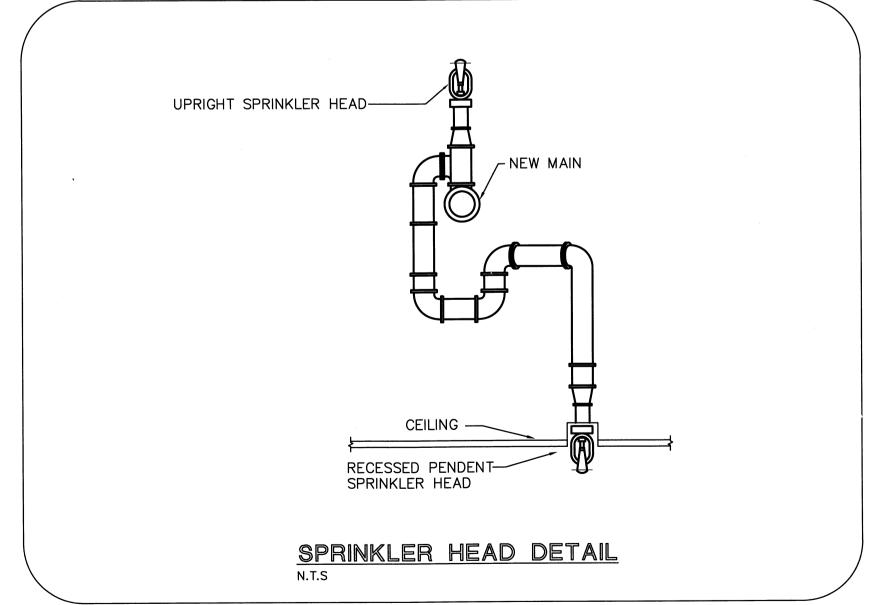
SECOND FLOOR FIRE ALARM PLAN











	SPRINKLER HEAD SCHEDULE													
SPRINKLER TYPE	SYMBOL	TEMPERATURE RATING (°F.)	NOMINAL ORIFICE SIZE	MANUFACTURER & MODEL	MAXIMUM SPACING	FLOW/PRESS GPM / PSI								
UPRIGHT QR-UPR	0	155	1/2" K=5.6	TYCO TY-FRB UPRIGHT STANDARD COVERAGE	13'X10'	5.6 / 7.0								
CONCEALED QR-PEN	•	155	1/2" K=5.6	TYCO RF-II CONCEALED PENDENT LIGHT HAZARD, WHITE	15 <b>'</b> X15 <b>'</b>	5.6 / 7.0								
HOR. SIDEWALL STD. COV	•	155	1/2" K=5.6	TYCO TY-FRB HORIZONTAL SIDEWALL LIGHT HAZARD WHITE	14'X14'	5.6 / 7.0								

S.6 LI	IGHT HAZAR	D WHITE	17717	3.6 / 7.0
	FIRE	PROTECT	TION LEG	END
	•	NEW PENDENT SPRIN	KLER HEAD	
	0	NEW UPRIGHT SPRIN	KLER HEAD	
-		NEW SPRINKLER PIP	NG (MAIN)	
_		NEW SPRINKLER PIP	NG (BRANCH LINE	Ξ)
_		EXISTING SPRINKLER	PIPING TO BE RE	EMAIN

#### FIRE SPRINKLER NOTES

- SUBMISSION OF PROPOSAL DIRECTLY OR INDIRECTLY IN CONNECTION WITH THIS WORK SHALL IMPLY THAT THE BIDDER HAS EXAMINED THE JOB SITE UNDER WHICH HE WILL BE OBLIGATED TO OPERATE SHOULD HE BE AWARDED THE WORK UNDER THIS CONTRACT. NO EXTRA CHARGE WILL BE ALLOWED FOR FAILURE OF ANY BIDDER TO EXAMINE THE SITE PRIOR TO BID.
- 2. CONTRACTOR SHALL VISIT THE SITE AND VERIFY ALL DIMENSIONS IN THE FIELD, AND SHALL ADVISE THE ARCHITECT/ENGINEER AND THE OWNER OF ANY DISCREPANCIES BEFORE PERFORMING THE WORK.
- 3. ALL WORK SHALL CONFORM TO ALL STATE AND LOCAL CODES, RULES AND REGULATIONS AND ORDINANCES INCLUDING BUT NOT LIMITED TO FLORIDA FIRE PREVENTION CODE 2010, NFPA 13, NFPA 20, NFPA 24, NFPA 25, NFPA 101.
- 4. CONTRACTOR SHALL SECURE AND PAY ALL FEES AND PERMITS PERTAINING TO THE CONTRACT.
- 5. ALL EQUIPMENT SHALL BE INSTALLED IN STRICT COMPLIANCE WITH THE MANUFACTURER'S WRITTEN INSTRUCTIONS. THE CONTRACTOR SHALL PROVIDE ALL HANGERS AND SUPPORTS REQUIRED FOR A COMPLETE INSTALLATION.
- 6. RESTORATION OF EXISTING SYSTEMS, DEVICES, FINISHES, ETC. DAMAGED OR ALTERED BY NEW WORK TO ACCEPTABLE CONDITION AS DETERMINED BY THE OWNER, ARCHITECT AND/OR ENGINEER.
- 7. CONTRACTOR SHALL BE RESPONSIBLE FOR WORKMEN'S IDENTIFICATION AND BADGING, SAFETY AND FIRE PROTECTION, CONTRACTOR'S LIABILITY INSURANCE, BARRICADES, WARNING SIGNS, TRASH REMOVAL, CUTTING AND PATCHING.
- 8. CONTRACTOR SHALL SCHEDULE ALL SHUTDOWNS THAT AFFECT UTILITIES AND PORTIONS OF THE BUILDING THAT MUST REMAIN IN OPERATION WITH THE OWNER.
- 9. CONTRACTOR SHALL COORDINATE ALL WORK WITH THE OWNER AND ALL OTHER CONTRACTORS.
- 10. CONTRACTOR SHALL BE RESPONSIBLE FOR ALL RIGGING, HANDLING

AND PROTECTION OF MATERIALS.

FURNISHED ITEMS.

- 11. CONTRACTOR SHALL PROVIDE LABOR TO RECEIVE, UNLOAD, STORE, PROTECT AND TRANSFER TO POINT OF INSTALLATION, OWNER
- 12. WHERE CONDUIT, CABLES, DUCTWORK OR PIPING PASSES THROUGH FIRE RATED FLOORS OR WALLS, THE SLEEVES SHALL BE COMPLETELY SEALED WITH A FIRE STOP MATERIAL THAT IS UL LISTED AND ACCEPTED BY THE BUILDING DEPARTMENT AND FIRE DEPARTMENT AS BEING SUITABLE FOR THIS SERVICE SUCH AS DOW CORNING CORP., SILICONE ELASTOMER, DOW CORNING 3-6548 SILICONE RTV FOAM, OR APPROVED EQUAL. THIS MATERIAL SHALL BE INSTALLED IN ACCORDANCE WITH THE REQUIREMENTS OF THE MANUFACTURER TO MAINTAIN THE FIRE RATING OF THE PENETRATED WALL OR FLOOR.
- 13. CONTRACTOR SHALL BE RESPONSIBLE FOR ALL CORING AS IT RELATES TO HIS WORK.
- 14. CONTRACTOR SHALL BE RESPONSIBLE FOR ALL BEAM PENETRATIONS AS IT RELATES TO HIS WORK. CONTRACTOR SHALL SUBMIT SIZE AND LOCATION TO THE STRUCTURAL ENGINEER FOR REVIEW AND DETAIL.
- 15. CONTRACTOR TO PROVIDE HYDRAULIC CALCULATIONS, SYSTEM LINE SIZING, PUMP SIZING, AND SHOP DRAWINGS TO ENGINEER OF RECORD FOR APPROVAL PRIOR TO COMMENCEMENT OF WORK.
- 16. CONTRACTOR SHALL SUBMIT (1) SET OF INSTALLATION SHOP DRAWINGS AND EQUIPMENT CUT SHEETS IN ELECTRONIC FORMAT TO THE ENGINEER FOR APPROVAL PRIOR TO STARTING ANY WORK.
- 17. UPON COMPLETION OF CONSTRUCTION CONTRACTOR SHALL SUPPLY THE ENGINEER WITH (1) COMPLETE SET OF MYLAR AS-BUILT DOCUMENTS AND (3)COMPLETE COPIES OF OPERATIONS AND MAINTENANCE MANUALS. MYLARS SHALL BE OBTAINED AT CONTRACTOR'S EXPENSE.
- 18. ALL EXPOSED FIRE SPRINKLER PIPING TO BE PAINTED RED.
- 19. ALL FIRE SPRINKLERS TO BE INSTALLED CENTERED IN TILE.
- 20. ACCEPTANCE AND HYDROSTATIC TESTS SHALL BE PERFORMED IN ACCORDANCE WITH CHAPTER 10 OF NFPA 13.
- 21. DO NOT SCALE DRAWINGS FOR EXACT DIMENSIONS. VERIFY ALL CONDITIONS AT THE JOB SITE AND COORDINATE WITH ALL TRADES PRIOR TO COMMENCEMENT. THE SPRINKLER DRAWINGS ARE INTENDED TO BE DIAGRAMMATIC.
- 22. MATERIALS, EQUIPMENT AND INSTALLATION SHALL BE GUARANTEED FOR A PERIOD OF ONE (1) YEAR FROM THE DATE OF ACCEPTANCE. DEFECTS WHICH APPEAR DURING THAT PERIOD SHALL BE CORRECTED AT THE SPRINKLER CONTRACTOR'S EXPENSE.

#### GENERAL NOTES - OFFICES


- 1. FIRE SPRINKLER SPACING TO BE: LIGHT HAZARD: MULTI-PURPOSE ROOM
- DENSITY: 0.15GPM/SF @ 13'X10' MAX
- 2. ALL FIRE SPRINKLER DEVICES TO BE UL AND/OR FM APPROVED.
- 3. SPRINKLER PIPING SHALL BE STEEL PIPE (ASTM 53, 120, OR 135) WITH 150 PSI MALLEABLE IRON FITTINGS WITH THREADED CONNECTIONS OR TYPE "L" HARD DRAWN COPPER TUBING WITH COPPER OR BRASS FITTINGS AND 125 PSI SOLDER JOINTS ("NO-LEAD SOLDER").
- A. SCH. 40, ALLIED XL OR AMERICAN BLT FOR 1" THRU 2"
- B. SCH. 10 FOR 2-1/2" AND LARGER C. SCH. 80 IF 1/2" OR 3/4" NIPPLE IS USED.
- NOTE: NIPPLE CANNOT EXCEED 4" IN LENGTH AND SUPPLY ONLY ONE HEAD PER NFPA 13.
- 4. FITTINGS
- A. BLACK CIS CLASS 125 FOR 1" THRU 2". B. GROOVED TYPE FOR 2-1/2" AND LARGER.
- 5. HANGERS TO BE IN ACCORDANCE WITH NFPA 13 AND LOCAL AUTHORITIES. SPRINKLER PIPING IS NOT TO BE SUPPORTED FROM ANY MECHANICAL OR ELECTRICAL DEVICES.
- MAXIMUM DISTANCE BETWEEN PIPE SUPPORTS:
- \* 12'-0" FOR 1 1/4" DIAMETER PIPE AND SMALLER \* 15'-0" FOR 1 1/2" DIAMETER PIPE AND LARGER

FIRE	SPRINKLER DRAWING LIST		HVAC PLUMBI
ORAWING NUMBER	DRAWING NAME		ELECTR
FS-0.1	FIRE SPRINKLER NOTES, LEGEND, AND SCHEDULE	THOMPSON & `	
FS-1.1	FIRST FLOOR FIRE SPRINKLER PLAN		
FS-1.2	SECOND FLOOR FIRE SPRINKLER PLAN	C.o.A NO.	25996
		112 SOUTHEAST 10th STREET	TEL: 561-

BING RICAL oss

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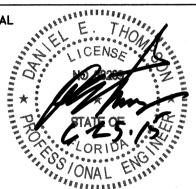
ISSUED FOR:

02/13/2015 06/25/2015

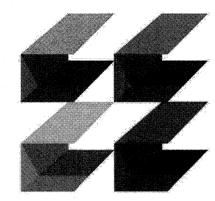06/25/2015

PERMIT

CONSTRUCTION



PROJECT TITLE Art Warehouse

313 NE 3rd Street Delray Bch, Florida, 33444

NUM. DESCRIPTION DATE

REVISIONS

THESE DRAWINGS ARE PREPARED PER ESTABLISHED INDUSTRY STANDARDS AND REPRESENT THE ARCHITECT AND ENGINEERS DESIGN CONCEPT. THEY ARE NOT INTENDED TO PROVIDE EVERY DETAIL OR CONDITION REQUIRED TO CONSTRUCT THE BUILDING. THE CONTRACTOR THROUGH SUBMITTALS AND OTHER COORDINATION EFFORTS IS FULLY RESPONSIBLE FOR PROVIDING A COMPLETE AND OPERATIONAL BUILDING WHETHER INDICATED ON THE PLANS OR NOT.

FILE NUMBER

> DRAWING TITLE ☐ FIRE SPRINKLER ✓ NOTES, LEGEND, % AND SCHEDULE

0 **☆** DATE DRAWN BY O6/25/2015 AA/MT/HL LL JOB NUMBER





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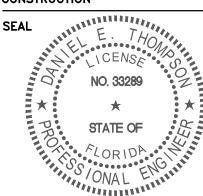
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1 Bldg. Dept. comments 08.21.15

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DRAWING TITLE ☐ FIRST FLOOR FIRE SPRINKLER o PLAN


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06/25/2015 AA/MT/HL

JOB NUMBER 100701/15009

DRAWING NUMBER

FAX: 561-274-0222 E-MAIL: tec**©**tecfla.com

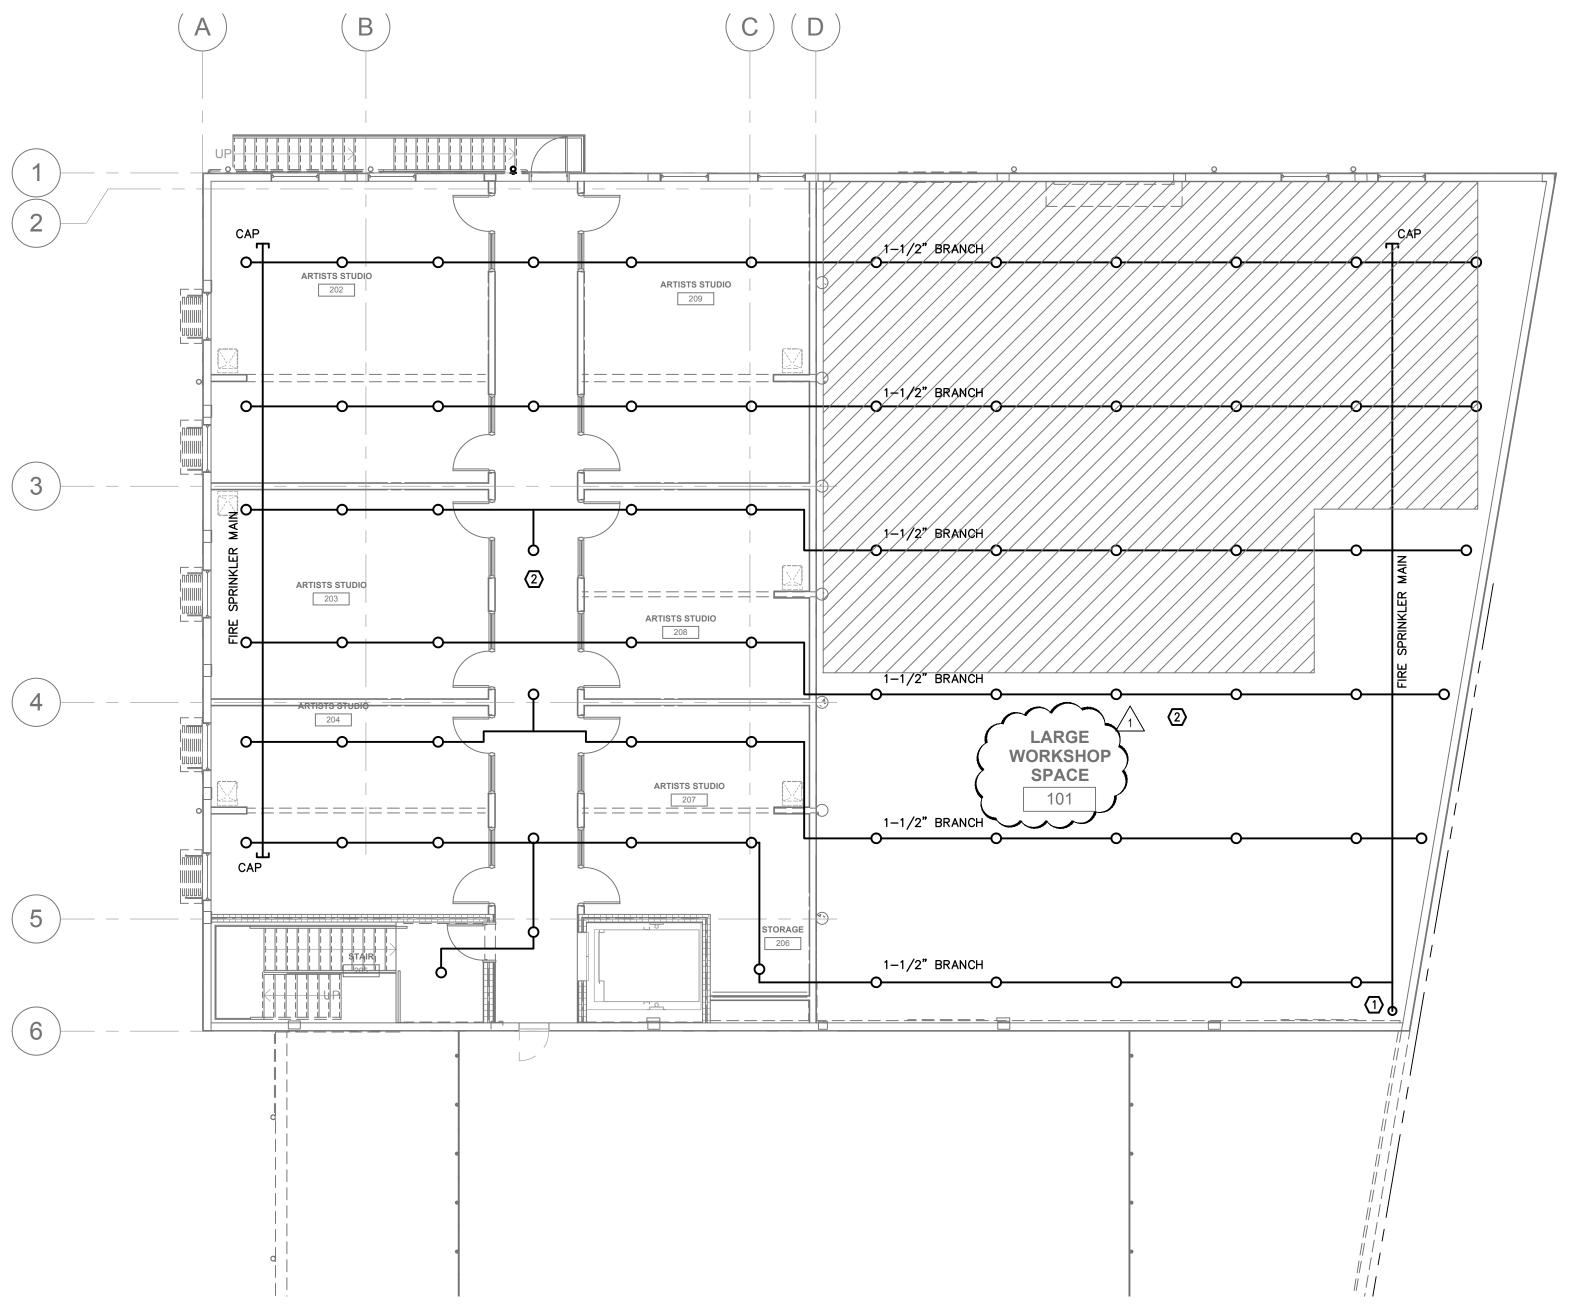

SECOND FLOOR FIRE SPRINKLER PLAN



AREA OF COVERAGE: CLASSROOMS	
AREA OF SPRINKLER OPERATION:	1500SF.
OCCUPANCY:	ORDINARY HAZARD GROUP 1
DENSITY:	0.15 GPM/SQ FT
SPRINKLER:	K=5.6 SIZE=1/2"
HOSE ALLOWANCE:	250
MAXIMUM SPACING:	13'X10'

	PLAN KEY NOTES
1	FROM 1ST FLOOR FIRE SPRINKLER SYSTEM. PROVIDE WALL MOUNTED RISER CLAMPS.
2	STRUCTURE IS EXPOSED TO THE UNDERNEATH. ALL LIGHTS AND MECHANICAL EQUIPMENT WILL BE EXPOSED. COORDINATE LOCATION OF FIRE SPRINKLERS WITH ALL OBSTRUCTIONS.

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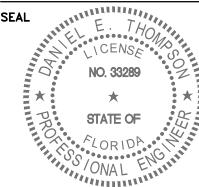
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DRAWING TITLE ∟ SECOND FLOOR FIRE SPRINKLER o PLAN

06/25/2015 AA/MT/HL

JOB NUMBER

0

DRAWING NUMBER

THOMPSON & YOUNGROSS

ENGINEERING CONSULTANTS, LLC C.o.A NO. 25996

112 SOUTHEAST 10th STREET DELRAY BEACH, FL 33483 www.tecfla.com

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UNIT DESIGNATION	EF-1,2	EF-3,4
MANUFACTURER	GREENHECK	GREENHECK
MODEL	SP-A90	SP-A290
TYPE	PREMIUM CEILING	PREMIUM CEILING
AREA SERVED	BATHROOM	BATHROOMS
CONSTRUCTION	INSULATED HOUSING	INSULATED HOUSING
DIMENSIONS	L-	
WIDTH (IN.)	13-1/4	14
LENGTH (IN.)	10-5/8	11-7/8
HEIGHT (IN.)	11-5/8	11-1/4
INLET & OUTLET SIZE (IN.)	6(W) x 6(H)	8(W) x 8(H)
WEIGHT (LBS.)	12	24
CONDITION OF SERVIC	E	
CFM	70	280
STATIC PRESSURE (W.G.)	0.25	0.15
RPM (MAX.)	900	1,050
TIP SPEED (MAX.)	1,296	•
SONES	1.0	2.5
DRIVE		
DIRECT	X	Х
V-BELT	•	•
FAN MOTORS		
HP (AMPS OR WATTS)	29 WATTS	81 WATTS
VOLTS	120	120
PHASE	1	1
CYCLE	60	60
MOTOR SPEEDS	•	•
TYPE OF MOTOR	•	•
SPECIAL FEATURES		
BIRD SCREEN	X	X
OPTIONS GAGE	•	•
GAGE	•	•
MATERIAL(AI)(FIBR.GL.)(STEEL)	STEEL	STEEL
DAMPER	X	X
BUILT IN DISCONNECT	X	X
NOTES:	1)23	1)2(4)

(2) PROVIDE AND INSTALL ROOF CAP.

(3) FAN SHALL BE INTERLOCKED WITH RTU-1.

(4) FAN SHALL BE INTERLOCKED WITH RTU-4.

			CALCUL 5-1, OUTDOOR AIR			
ZONE NAME / SPACE NAME	MULT.	FLOOR AREA (SQ. FT.)	MAXIMUM	REQUIRED OUTDOOR AIR	REQUIRED OUTDOOR AIR (CFM/SQ, FT.)	REQUIRED OUTDOOR AIR (CFM)
RTU-1			41			
1ST FLR STUDIOS & MAKERS SPACE	1	2,731	11	7.5	0.06	246.4
CORRIDORS 1 & 2	1	767	10	0	0.06	46
TOILET	1	67	1	O	0	<u>O</u>
TOTAL REQUIRED (INCLUDES SPACE	L : MULTIPI	L LIERS)				292.4
TOTAL PROVIDED (MAXIMUM)						300
RTU-2						
2ND FLR STUDIOS	1	2,838	12	7.5	0.06	260.3
2ND FLR CORRIDOR & LOBBY	1	602	10	O	0.06	36.1
2ND FLR STAIRS	1	225	5	<u>O</u>	<u>O</u>	O
TOTAL REQUIRED (INCLUDES SPACE	MUI TIPI	IFRS)				296.4
TOTAL PROVIDED (MAXIMUM)	· WOLTH					
RTU-3.4						300
MULTI-PURPOSE ROOM	1	3,972	92	5.0	0.06	698.3
TOTAL REQUIRED (INCLUDES SPACE	··········		92	5.0	0.06	
TOTAL PROVIDED (MAXIMUM)	MOLTIFI	LICINO)				698.3
RTU-5		78.74				700
MENS AND WOMENS BATHROOM	1	700	10		0	600.7
STORAGE ROOM	1 1	398 465	10 5	O O	0 0.12	698.3 55.8
BREAK ROOM	1 1	411	5	5.0	0.12	49.7
INCUBATOR & CLASSROOM	1	825	18	5.0	0.06	139.5
TOTAL REQUIRED (INCLUDES SPACE	MULTIPL		10	3.0	0.00	254.3
TOTAL PROVIDED (MAXIMUM)	,					255
RTU-6,7						
DISPLAY AREA	1	3350	65	5.0	0.06	476
RECEPTION	1	482	10	5.0	0.06	78.9
OFFICES	1	346	2	5.0	0.06	30.7
STORAGE AND JANITOR	11	164	0	0	0.06	9.8
TOTAL REQUIRED (INCLUDI SPACE	MULTIPL	JERS)				595.5
TOTAL PROVIDED (MAXIMUM)						600

NEED TO BE RE-EVALUATED IF, AT A LATER TIME, SPACE USE CHANGES OCCUR OR IF UNUSUAL CONTAMINANTS OR UNUSUALLY STRONG SOURCES OF SPECIFIC CONTAMINANTS ARE TO BE INTRODUCED INTO THE SPACE INCLUDING ENVIRONMENTAL CIGARETTES, PIPE OR CIGAR SMOKE. CHANGES IN SPACE USE, CONTAMINANTS, OR OPERATION MAY REQUIRE A RE-EVALUATION OF THE DESIGN AND IMPLEMENTATION OF NEEDED CHANGES.

	PAUNA	AGE A/O U	INIT SCHEE	JULE	
UNIT DESIGNATION	RTU-1	RTU-2	RTU-3,4	RTU-5	RTU-6,7
MANUFACTURER	CARRIER	CARRIER	CARRIER	CARRIER	CARRIER
MODEL NO.	50LC0007C2C5-0A0A0	50LC0008G2C5-0B0A0	50LC0008G2C5-0B0A0	50LC0006G2C5-0B0A0	50LC0007C2C5-0A0A0
SYSTEM TYPE	3-STAGE W/HUMIDIMIZER	3-STAGE W/HUMIDIMIZER	3-STAGE W/HUMIDIMIZER	2-STAGE W/HUMIDIMIZER	3-STAGE W/HUMIDIMIZE
SEER/EER/IPLV	13.1 EER/20.7 IEER	13.1 EER/19.9 IEER	13.1 EER/19.9 IEER	16.2 SEER	13.1 EER/20.7 IEER
NOMINAL TONS	6.0	7.5	7.5	5.0	6.0
TOTAL COOLING (MBH)	72,800	89,940	89,940	59,910	72,130
NET SENSIBLE (MBH)	50,870	61,660	61,660	42,950	47,310
WEIGHT (LBS)	1,379	1,947	1,947	855	1,379
DIMENSIONS(LxWxH)	88.1x59.5x42.5	115.9x63.4x58.8	115.9x63.4x58.8	74.4×46.8×41.4	88.1x59.5x42.5
AREA SERVED	1ST FLOOR STUDIOS	2ND FLOOR STUDIOS	MULTI-PURPOSE	SOUTHEAST	DISPLAY AREA
FAN / COIL SE	CTION				
TYPE	VERTICAL S/A	HORIZONTAL	HORIZONTAL	VERTICAL S/A	VERTICAL S/A
	& HORIZONTAL R/A	S/A & R/A	S/A & R/A		& HORIZONTAL R/A
TOTAL CFM	2,400	3,000	2,625	2,000	2,100
OUTSIDE AIR CFM	300	300	300 MAX/100 MIN(9)	255	300
ENT. AIR DB/WB(°F)	76.0/65.8	75.6/65.1	76.3/66.1	76.1/65.3	76.4/66.2
EXT. SP. (IN WG)	0.75	0.75	0.75	0.75	0.75
FAN MOTOR H.P.	5.8 FLA	5.8 FLA	5.8 FLA	7.1 FLA	5.8 FLA
DRIVE	BELT	BELT	BELT	BELT	BELT
VOLTAGE/PHASE	208/3	208/3	208/3	208/3	208/3
HEATING CAPA	CITIES				
CAPACITY BTUH	41,000	42,300	42,300	17,000	41,000
TYPE	ELECTRIC	ELECTRIC	ELECTRIC	ELECTRIC	ELECTRIC
KW/VOLTAGE/PHASE	12/208/3	12.4/208/3	12.4/208/3	4.9/208/3	12/208/3
STAGES/KW EACH	1/12	1/12.4	1/12.4	1/4.9	1/12
CONTROL VOLT	24	24	24	24	24
FILTER SPECIFI	CATIONS				
TYPE	MERV 8	MERV 8	MERV 8	MERV 8	MERV 8
SIZE (2")				16X16	
QUANTITY				4	
CONDENSING SI	ECTION				
TYPE	AIR COOLED	AIR COOLED	AIR COOLED	AIR COOLED	AIR COOLED
REFRIGERANT	R410A	R410A	R410A	R410A	R410A
COMPR. NO. TYPE	2/SCROLL	2/SCROLL	2/SCROLL	1/SCROLL	2/SCROLL
COMPRESSOR RLA	8.3 & 13.2	13.2 & 13.7	13.2 & 13.7	16.2	8.3 & 13.2
VOLT/PHASE	208/3	208/3	208/3	208/3	208/3
FAN: #/AMPS/VOLTS/Ø	2/1.8/208/3	3/1.8/208/3	3/1.8/208/3	1/3.5/208/3	2/1.8/208/3
MOCP *	50	60	60	50	50
MCA **	49	51	51	36	49
NOTES:	ALL	ALL	ALL		
NOTES.		ALL		ALL	ALL

\*\* MOTOR CIRCUIT AMPS PROVIDE WITH FULL UNIT CURB, 14" HIGH, CARRIER MODEL # CRRFCURB004A01.

(2) PROVIDE AND INSTALL PROGRAMMABLE 3-STAGE ELECTRONIC THERMOSTAT WITH HUMIDIMIZER CONTROL, CARRIER MODEL # CRSTAT3C001A00--HL--38MG-029 FOR RTU-1,2,3,4,6,7 AND 2-STAGE T-STAT 33CS2PP2S-03--HL--38MG-029 FOR RTU-5.

(3) PROVIDE AND INSTALL SUPPLY AIR PHOTOELECTRIC SMOKE DETECTOR, IN SUPPLY WITH REMOTE TEST. 4 MODULATING MOTORIZED DAMPER OPTION SHALL BE PROVIDED FOR OUTSIDE AIR INTAKE,

INTERLOCK WITH CO2 SENSOR.

(5) UNIT SHALL BE PROVIDED WITH FACTORY APPLIED E-COAT AL/CU.

(6) UNIT SHALL BE SET ON MEDIUM STATIC MODE. 7 PROVIDE FACTORY INSTALLED HOT GAS REHEAT HUMIDIMIZER— DEHUMIDIFICATION PACKAGE.

(8) UNITS SHALL BE PROVIDED WITH CO2 SENSOR (NO CO2 FOR RTU-1,2&5), MODULATING MOTORIZED OUTSIDE AIR DAMPER, S/A SMOKE DETECTOR AND SHALL BE INSTALLED BY MECHANICAL CONTRACTOR IN THE FIELD.

(9) MAXIMUM OUTSIDE AIR SHOWN BASED ON ASHRAE REQUIREMENTS, MINIMUM SHOWN TO MAINTAIN BUILDING PRESSURIZED DURING UNOCCUPIED MODE AND LOW CO2 LEVELS.

NOTE: AIR CONDITIONING PACKAGE UNITS MANUFACTURED BY YORK(PREDATOR SERIES, MULTI-STAGE WITH HOT GAS REHEAT) WITH SAME VOLUME AND CAPACITIES ARE CONSIDERED EQUAL. SUBMIT ALL CUT-SHEETS FOR SUBSTITUTED EQUIPMENT.

BUILDING ENVELOPE								
TYPE	DESCRIPTION	R-VALUE (ASSEMBLY)	SUMMER U-VALUE	SOLAR HEAT GAIN COEFFICIENT				
ROOF	BUILT UP WITH R-19 TAPER INSULATION	R-20	0.049					
WALL(ALL EXCEPT MULTI-PURPOSE)	STUCCO/8"CMU/R-7 BOARD INSULATION/ GYP.	R-11	0.094	***************************************				
WALL(MULTI-PURPOSE ROOM)	STUCCO/8"CMU	R-3	0.309	•				
GROUND SLAB	VAPOR RETARDER SLAB ON GRADE	***************************************	0.100	·				
GLASS WINDOWS	•	***************************************	1.212	0.657				
SLIDING GARAGE DOOR	INSULATED		0.30					

**KEY NOTES:** THE VALUES SHOWN ABOVE ARE AS PER SPECIFICATIONS GIVEN BY ARCHITECT OR OWNER.

THE VALUES SHOWN ABOVE WERE USED TO SIZE THE HVAC EQUIPMENT AND INPUTTED IN THE ENERGY CALCULATIONS. NO CHANGES SHALL BE MADE WITHOUT THE WRITTEN APPROVAL OF OWNER, ARCHITECT, AND ENGINEER.

	AIR	BALAN	ICE S	CHEDU	LE	
MARK	SUPPLY AIR		OUTSIDE AIR MAX/MIN	EXHAUST AIR	RELIEF AIR	RESULTING PRESSURE MAX/MIN
RTU-1	2,400	2,100	300	140(EF-1,2)		+160
RTU-2	3,000	2,700	300	•		+300
RTU-3	2,625	2,525/2,325	300/100	•		+300/+100
RTU-4	2,625	2,525/2,325	300/100	•		+300/+100
RTU-5	2,000	1,745	255	560(EF-2,3)		-305
RTU-6	2,100	1,950/1,800	300/150	•		+300/+150
RTU-7	2,100	1,950/1,800	300/150	•		+300/+150
TOTAL	15,600	13,395	+2,205	-630		+1,355/+655

AIR DISTRIBUTION SCHEDULE											
TYPE	MFG	MODEL	CFM	PATTERN	DAMPER	MOUNTING	SIZE	MAX N.C.			
Α	TITUS	300FS	SEE PLANS	DOUBLE DEF.	AG-15-AA	SURFACE	SEE PLANS	25			
В	TITUS	TMS-AA	SEE PLANS	SEE PLANS	AG-15-AA	SURFACE	24X24	25			
R	TITUS	350FL	SEE PLANS	SEE PLANS	_	SURFACE	SEE PLANS	25			

### MECHANICAL LEGEND

SYMBOL	DESCRIPTION
O.A.	OUTSIDE AIR
O.A.L.	OUTSIDE AIR LOUVER
R.A.	RETURN AIR
C.F.M.	CUBIC FEET PER MINUTE
	THERMOSTAT/HUMIDISTAT COMBO
<b>©</b>	CARBON DIOXIDE SENSOR
®	REMOTE SMOKE DETECTOR TEST STATION
<del></del> \$D	SMOKE DETECTOR
CFM	A= DIFFUSER TYPE CFM= DIFFUSER AIR FLOW
—— <b>▼</b> FD	UL LISTED FIRE DAMPER
VD	VOLUME DAMPER
———□MOD	MOTOR OPERATED DAMPER
	TWIST-IN COLLAR WITH DAMPER
	CEILING DIFFUSER — SUPPLY AIR
EE	TURNING VANES
<i>\\\\\\\\\\\\\\\\\\\\\\\\\\\\\\\\\\\\\</i>	SHEET METAL DUCTWORK
	METAL LINED
	CEILING DIFFUSER — RETURN AIR
	CEILING DIFFUSER — EXHAUST AIR
፟፟፟	SIDE-WALL DIFFUSER - RETURN AIR
— RL —— RL ——	REFRIGERANT LIQUID LINE

#### DUCT MATERIAL LEGEND

SYMBOL MATERIAL		LINER	SMACNA PRESSURE CLASS	SMACNA SEAL CLASS					
	SEE	NOTES	1"WG	SEE NOTES					
<i>₹///////</i>	METAL NONE		1"WG	D					

### HVAC DESIGN CRITERIA

OUTDOOR DESIGN:	91°db/78°wb
INDOOR DESIGN:	73°db 50% R.H
OUTSIDE AIR MINIMUM:	PER ASHRAE
MAXIMUM SENSIBLE LOAD:	SEE PLANS
MAXIMUM LATENT LOAD:	SEE PLANS
TOTAL COOLING REQUIRED:	SEE PLANS
CONDITIONED AREA:	SEE PLANS
TOTAL HEATING REQUIRED WITH O/A:	SEE PLANS
SIZING METHOD:	CARRIER HAP 4.8

#### HVAC DESIGN REQUIREMENTS

	A11001 A	
	YES	NO
DUCT SMOKE DETECTOR	X	
FIRE DAMPERS	X	
SMOKE DAMPER(S)		×
FIRE RATED ENCLOSURE	X	
FIRE RATED ROOF/FLOOR CEILING ASSEMBLY	X	
FIRE STOPPING	X	
SMOKE CONTROL		×

#### MECHANICAL NOTES

- DO NOT SCALE THE DRAWINGS. REFER TO ARCHITECTURAL PLANS FOR
- COORDINATE EXACT LOCATION OF ALL DIFFUSERS AND RETURNS WITH ARCHITECTURAL REFLECTED CEILING PLAN. ALL WORK SHALL COMPLY WITH THE 2010 EDITION OF THE FLORIDA
- MECHANICAL, ENERGY CONSERVATION, ACCESSIBILITY CODES, AND AND ALL LOCAL CODE AMENDMENTS.
- ALL PENETRATIONS OF REQUIRED FIRE RATED WALLS AND CEILINGS SHALL BE WITH AN ACCESSIBLE U.L. LABELED FIRE DAMPER.
- ALL DAMPER CONTROLS SHALL BE ACCESSIBLE.
- ALL OUTSIDE AIR DUCTS OR INTAKES SHALL HAVE DAMPERS.
- THE LICENSED CONTRACTOR SHALL PROVIDE A COMPLETE MECHANICAL SYSTEM(S) AS DETAILED ON THE DRAWINGS AND SPECIFICATIONS. WORK CONSISTS OF PROVIDING ALL MATERIALS, EQUIPMENT, APPURTENANCES, ETC. REQUIRED FOR A COMPLETE SYSTEM(S). INCLUDE ANY INCIDENTAL APPARATUS. APPLIANCES, MATERIALS, LABOR, PERMITS, SERVICES, ETC. NECESSARY TO MAKE WORK COMPLETE AND READY FOR OPERATION. IT IS THE INTENT OF THE DRAWINGS AND SPECIFICATIONS TO CALL FOR COMPLETE, FINISHED WORK, TESTED, AND READY FOR OPERATION.
- THE CONTRACTOR SHALL PERFORM ALL WORK IN A FIRST CLASS WORKMAN-LIKE MANNER.
- THE CONTRACTOR IS RESPONSIBLE FOR IDENTIFYING CONFLICTS IN THE DRAWINGS AND SPECIFICATIONS PRIOR TO BIDDING AND REPORTING CONFLICTS TO THE ENGINEER BEFORE BIDDING. ANY CHANGES RESULTING FROM CONFLICTS IN THE FIELD, WHICH WERE NOT BROUGHT TO THE ENGINEERS ATTENTION, ARE TO BE MADE BY THE CONTRACTOR AT NO ADDITIONAL COST TO THE OWNER.
- 10. THE WORK INDICATED ON THE DRAWINGS IS DIAGRAMMATIC AND IS INTENDED TO CONVEY THE SCOPE OF WORK AND INDICATE THE GENERAL ARRANGEMENT OF PIPING, DUCTWORK, EQUIPMENT, ETC. DO NOT SCALE THE DRAWINGS FOR THE EXACT LOCATION OF DUCTWORK, PIPING, EQUIMENT, ETC. PROVIDE OFFSETS AND DEVIATIONS FROM WORK SHOWN ON THE DRAWINGS AS MAY BE NECESSARY TO FIT ACTUAL SPACE CONDITIONS AT NO ADDITIONAL COST TO THE OWNER.
- AIR CONDITIONING SUPPLY & RETURN DUCTS INSIDE BUILDING SHALL BE DOUBLE WALLED INTERNALLY INSULATED WITH 1 (ONE) INCH THICK INTERIOR INSULATION, CERTAINTEED TOUGHGARD "ULTRA" OR JOHNS-MANVILLE "SPIRACOUSTIC" DUCT LINER 1 (ONE) INCH THICK. ALL DROPS AND FITTINGS SHALL ALSO BE LINED. EXCEPT FOR THE FOLLOWING ROOMS:
- OFFICE 110, OFFICE 111, CLASSROOM 112, INCUBATOR 113, BREAKROOM 114, CORRIDOR 118, WOMEN'S 115 AND MEN'S 117, WHERE IT SHALL BE: FIBERGLASS TYPE 475 EI INSTALLED, SEALED AND REINFORCED IN ACCORDANCE WITH THE LATEST EDITION OF "NAIMA" FIBROUS GLASS DUCT CONSTRUCTION STANDARDS AND DETAILS ON THESE PLANS. 0-1" STATIC PRESSURE CLASS, (+/-), UNLESS OTHERWISE NOTED. AND FLEXIBLE DUCT SIMILIAR TO HART & COOLEY F214, UL 181, CLASS 1 AIR DUCT WHICH MEETS THE REQUIREMENTS OF NFPA (90A & 90B). INSULATED DUCT, WITH A DOUBLE-PLY POLYESTER CORE AND METALIZED POLYESTER JACKET, INSULATED WITH FIBERGLASS R4.2. DUCT MATERIAL SHALL HAVE A FLAMESPREAD INDEX OF NOT MORE THAN 25 AND A SMOKE DEVELOPED INDEX OF NOT MORE THAN 50 WHEN TESTED IN ACCORDANCE WITH ASTME 84.
- 12. AIR CONDITIONING SUPPLY & RETURN DUCTWORK OUTSIDE ABOVE ROOF SHALL BE DOUBLE WALL (R-8 MINIMUM), PAINTED GALVANIZED EXTERIOR SHEET METAL AND SHEET METAL INTERIOR, ALL SEAMS SEALED.
- ALL EXHAUST DUCTS SHALL BE SHEET METAL, INSTALLED, SEALED AND SUPPORTED IN ACCORDANCE WITH THE LATEST EDITION "SMACNA" LOW VELOCITY DUCT CONSTRUCTION STANDARDS AND DETAILS ON THESE PLANS.
- REFRIGERANT PIPING SHALL BE COPPER, REFRIGERATION GRADE, SOFT TEMPER, SEALED AT THE MILL. INSULATE SUCTION PIPE INDOORS: WITH 3/8" IMCOA POLYOLEFIN INSULATION: OUTDOORS: 3/4" IMCOA POLYOLEFIN INSULATION. CIRCULATE DRY NITROGEN THROUGH PIPING WHEN SOLDERING. TEST FOR LEAKS PRIOR TO CHARGING SYSTEM WITH R-410A REFRIGERANT.
- 15. PROVIDE TEST & BALANCE REPORT AT COMPLETION OF
- PROVIDE SHOP DRAWINGS FOR ALL EQUIPMENT, MECHANICAL CONTRACTOR SHALL NOT ORDER ANY EQUIPMENT WITHOUT A APPROVED SHOP DRAWING FROM THE MECHANICAL ENGINEER.
- PROVIDE "AS BUILT" DUCTWORK DRAWINGS TO OWNER AT COMPLETION OF PROJECT PRIOR TO FINAL INSPECTION.
- AS PER 2010 FLORIDA BUILDING CODE-ENERGY CONSERVATION, SECTION 503.2.5.4 BOTH OUTDOOR AIR SUPPLY AND EXHAUST SYSTEMS SHALL BE EQUIPPED WITH DAMPERS THAT WILL AUTOMATICALLY SHUT WHEN THE SYSTEMS OR SPACES SERVED ARE NOT IN USE. VENTILATION OUTSIDE AIR DAMPERS SHALL BE CAPABLE OF AUTOMATICALLY SHUTTING OFF DURING PREOCCUPANCY BUILDING WARMUP, COOLDOWN, AND SETBACK. EXCEPT WHEN VENTILATION REDUCES ENERGY COSTS (E.G., NIGHT PURGE) OR WHEN VENTILATION MUST BE SUPPLIED TO MEET CODE REQUIREMENTS. MOTORIZED DAMPERS SHALL BE NOT LESS THAN A CLASS I LEAKAGE-RATED DAMPER WITH A MAXIMUM LEAKAGE RATE OF 4 CFM PER S.F. AT 1" W.G. WHEN TESTED IN ACCORDANCE WITH AMCA 500D.
- REFRIGERANT CIRCUIT ACCESS PORTS LOCATED OUTDOORS SHALL BE FITTED WITH LOCKING-TYPE TAMPER-RESISTANT CAPS AS PER 2010 FMC-1101.10.
- CONTRACTOR SHALL PATCH AND REPAIR EXISTING ROOFING MATERIAL AS REQUIRED BY AN APPROVED ROOFING CONTRACTOR FOR ROOFING MEMBRANE ORIGINALLY INSTALLED SO AS NOT TO VOID WARRANTY. CONTRACTOR IS TO PROVIDE REQUIRED STRUCTURAL STEEL FRAMEWORK FOR ADDITIONAL SUPPORT. CONTRACTOR SHALL BE RESPONSIBLE FOR ACQUIRING A STRUCTURAL ENGINEER FOR SIZING OF STRUCTURAL STEEL FRAMEWORK REQUIRED.
- MOUNT THERMOSTAT AND REMOTE SMOKE TEST STATION AT 48"A.F.F.

#### SMOKE DETECTOR OPERATION

SMOKE DETECTORS SHALL AUTOMATICLLY STOP THEIR RESPECTIVE FANS ON THE DETECTION OF SMOKE.

- SMOKE DETECTORS SHALL BE INSTALLED TESTED AND MAINTAINED IN ACCORDANCE WITH NFPA 72, "NATIONAL FIRE ALARM CODE" AND THE FLORIDA FIRE CODE AND BUILDING CODE.
- 3. SMOKE DETECTORS SHALL BE CONNECTED TO THE BUILDING FIRE ALARM SYSTEM IN ACCORDANCE WITH NFPA 72.
- . SMOKE DETECTORS SHALL BE INSTALLED IN ACCORANCE WITH THE MANUFACTURERS INSTRUCTIONS AND SHALL BE ACCESSIBLE FOR CLEANING BY INSTALLING ACCESS DOORS OR PANELS IN ACCORDANCE WITH NFPA 90A.
- . DETECTORS SHALL HAVE A REMOTE TEST AND SUPERVISORY ALARM INSTALLED IN A LOCATION ACCEPTABLE TO THE AUTHORITY HAVING JURISDICTION. GENERALLY IT SHOULD BE NEXT TO THE UNIT THERMOATAT AND LABLED TO INDICATE FUNCTION AND AIR HANDLING UNIT ASSOCIATED WITH EACH DETECTOR.
- . INTERCONNECT SMOKE DIECTORS SERVING AIR HANDLING UNITS THAT SUPPLY AIR INTO THE SAME CONTIGUOUS SPACE SO THAT IF ONE UNIT SHUTS DOWN BECAUSE OF SMOKE ALL UNITS WITHIN THAT SPACE MUST
- . ACTIVATION OF A SMOKE DETECTOR MAY INDICATE A SUPERVISORY TROUBLE SIGNAL IN LIEU OF A GENERAL ALRAM ONLY IF ACCEPTABLE TO THE AUTHORITY HAVING JURISDICTION.


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# MECHANICAL DDAMING LICT

MEC	HANICAL DRAWING LIST
RAWING NUMBER	DRAWING NAME
M0.1	MECHANICAL NOTES, LEGEND, AND SCHEDULE
M1.1	FIRST FLOOR PLAN- MECHANICAL
M1.2	2ND FLOOR PLAN- MECHANICAL
M2.1	MECHANICAL DETAILS



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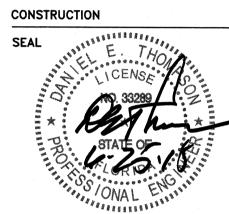
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ISSUED FOR: **SPRAB** 02/13/2015 06/25/2015

PERMIT 06/25/2015

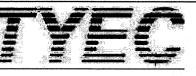

PROJECT TITLE Art Warehouse

313 NE 3rd Street Delray Bch, Florida, 33444 REVISIONS

NUM. DESCRIPTION DATE


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**OPERATIONAL BUILDING WHETHER** 

> INDICATED ON THE PLANS OR NOT. > FILE NUMBER DRAWING TITLE

**MECHANICAL** %

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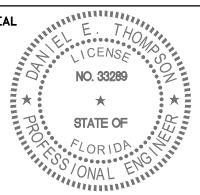
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1 Bldg. Dept. comments 08.21.15

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DRAWING TITLE FIRST FLOOR PLAN

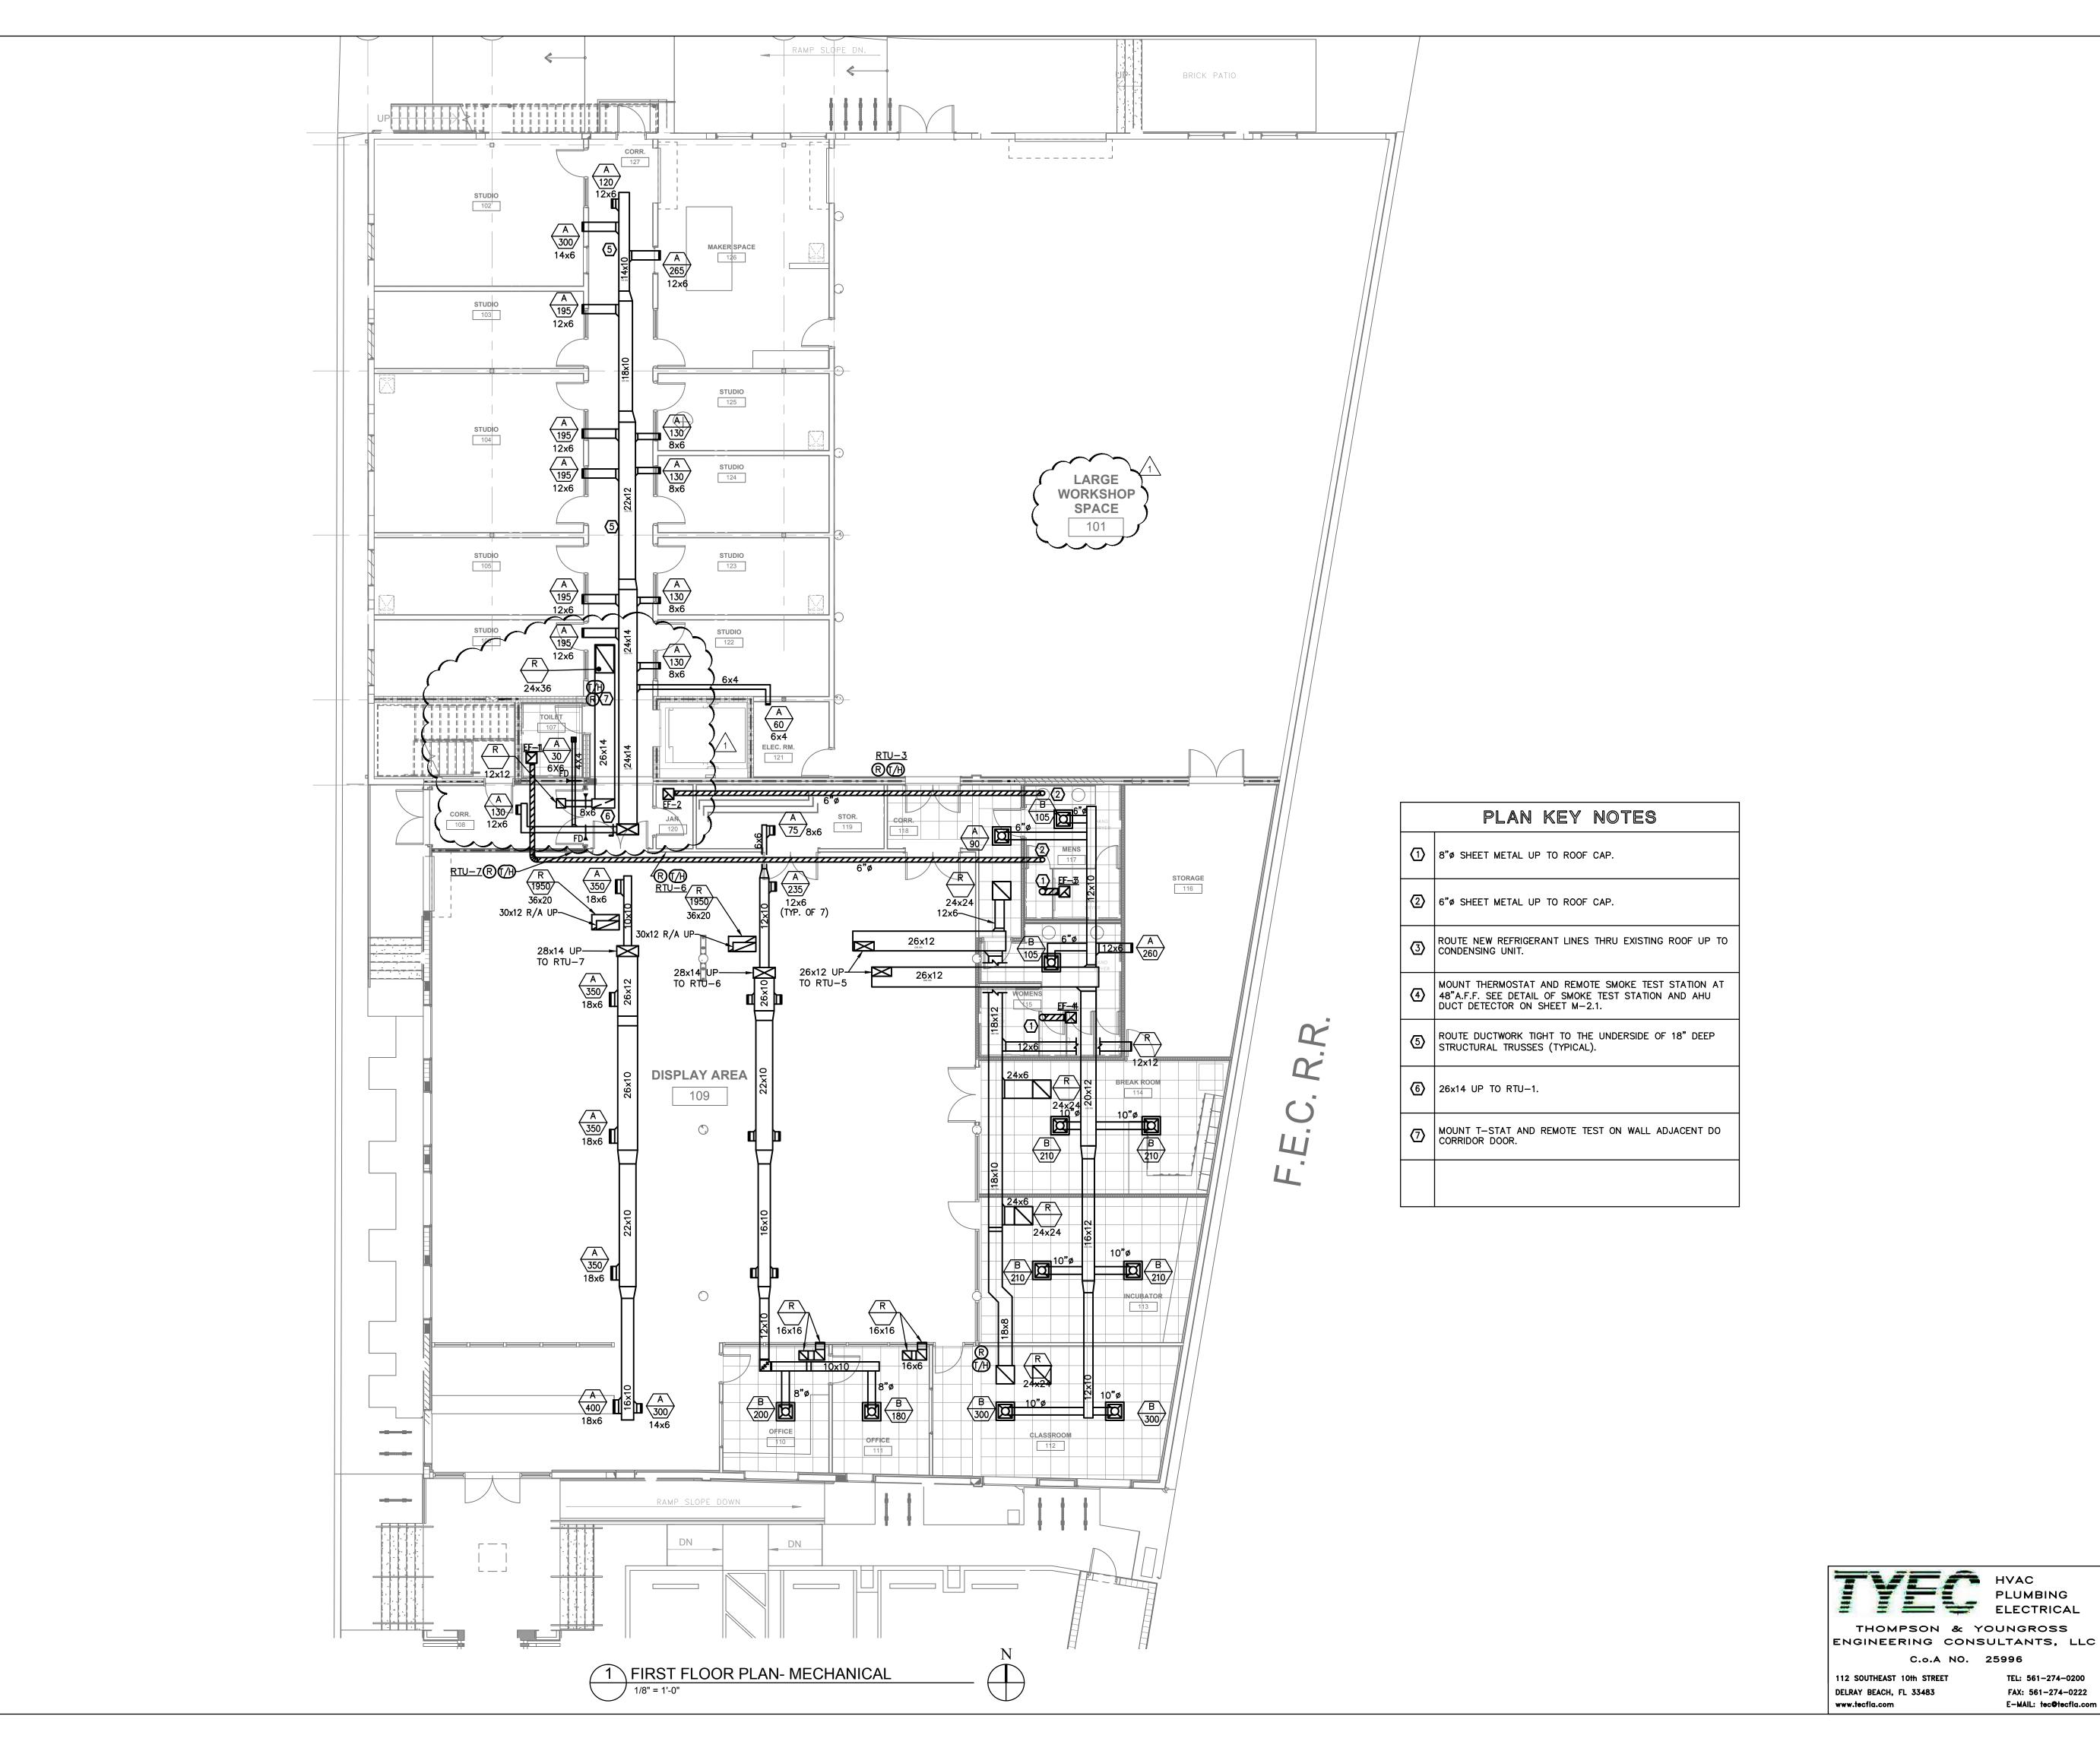→ MECHANICAL


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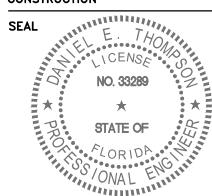
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→ MECHANICAL


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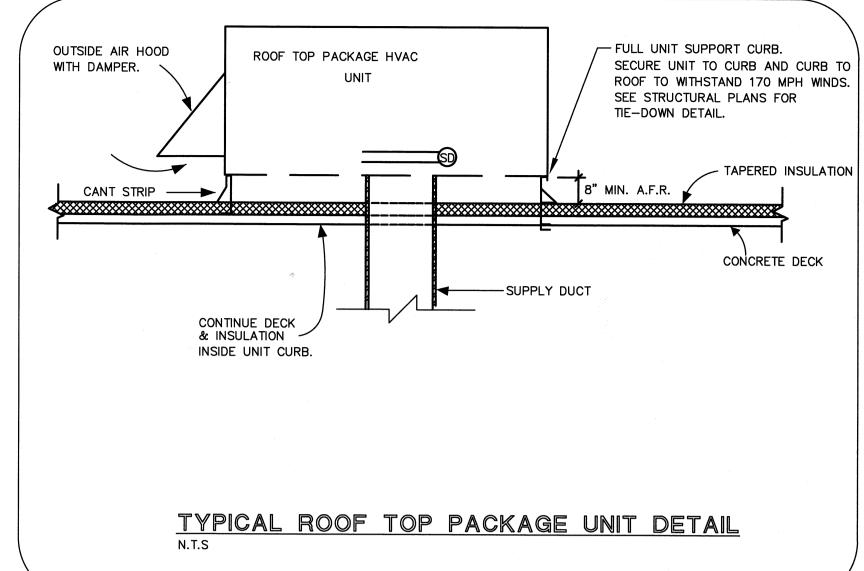
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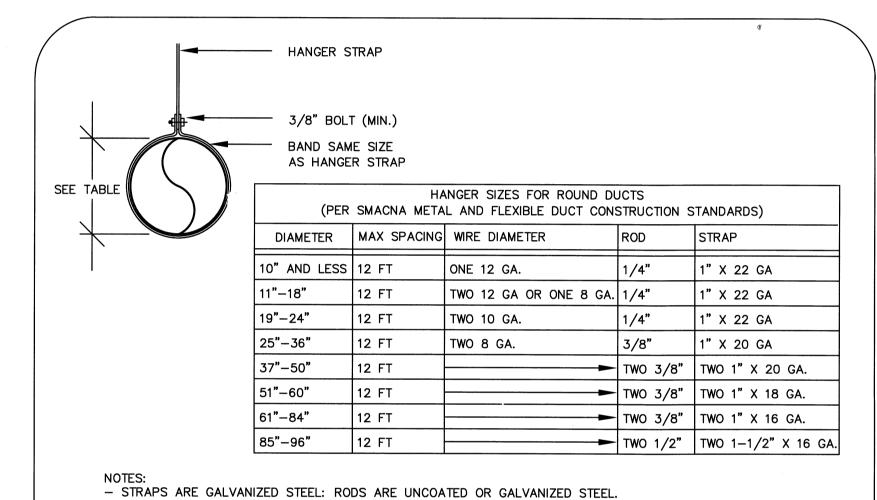
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- DUCT HOUSING AND BASE WITH PHOTOELECTRIC DETECTOR




-ROOF MOUNTED H.V.A.C. EQUIPMENT

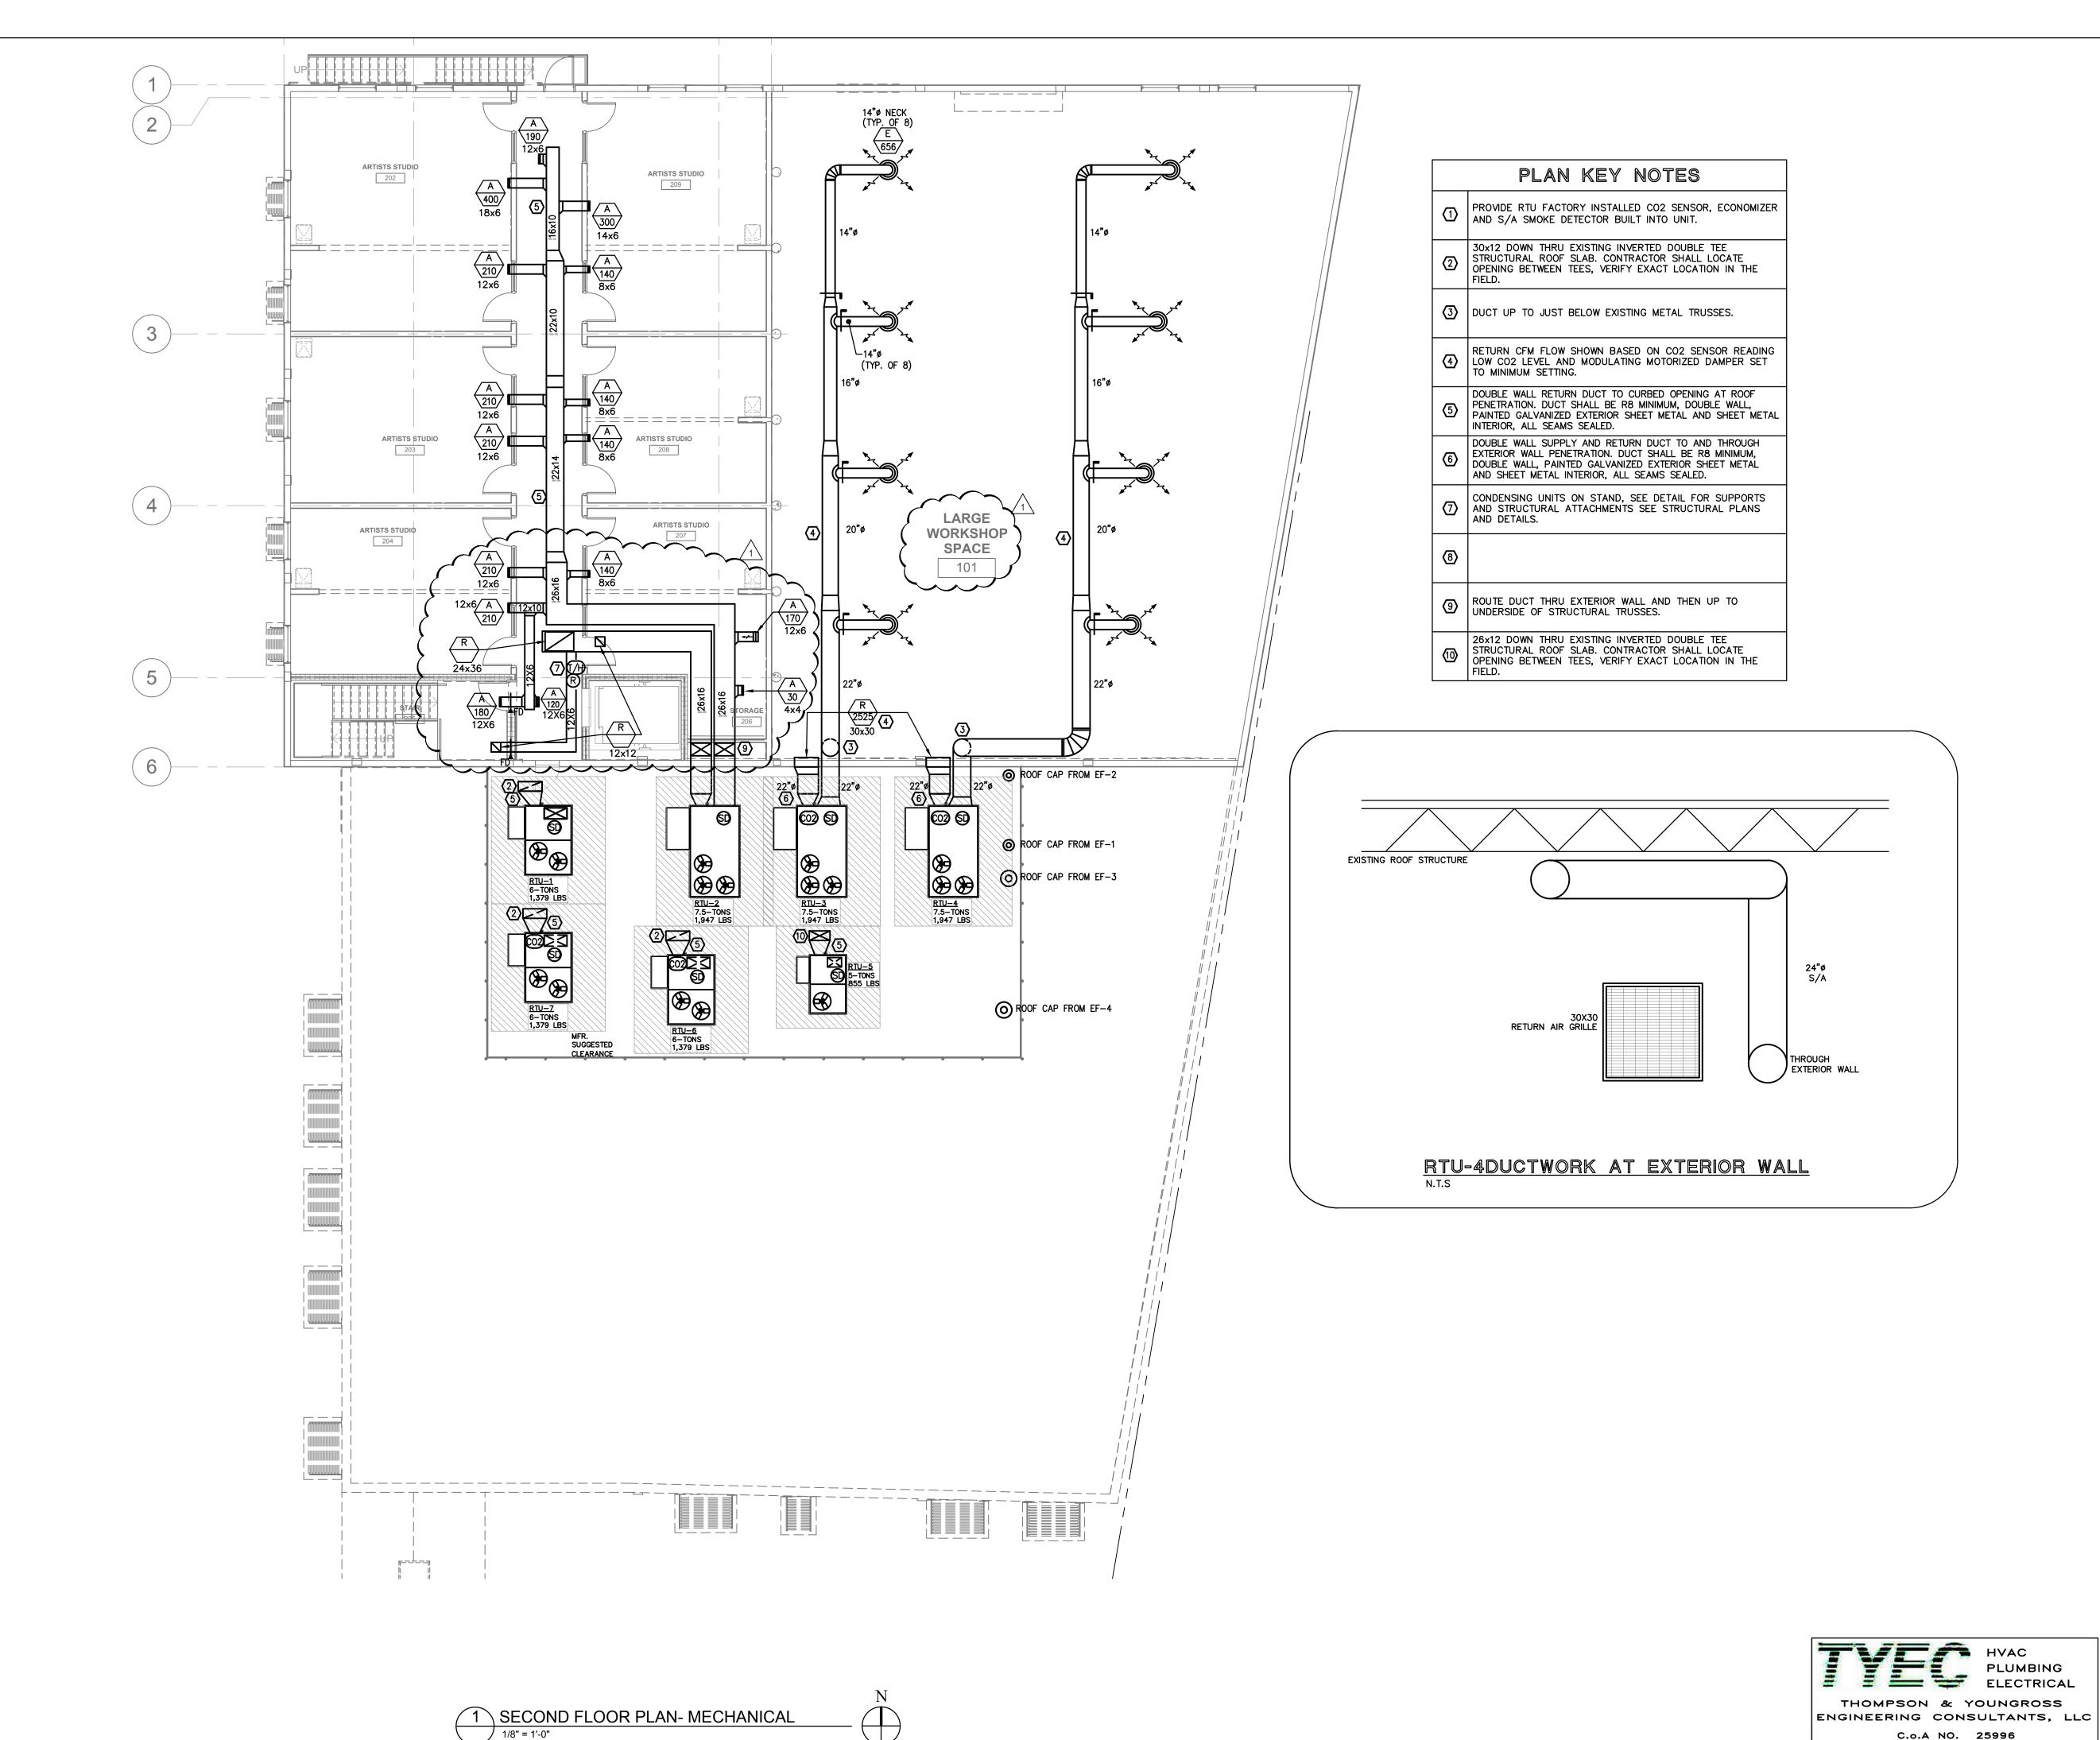

- WIRE IS BLACK ANNEALED, BRIGHT BASIC OR GALVANIZED STEEL. ALL ARE ALTERNATES. - TABLES ALLOW FOR CONVENTIONAL WALL THICKNESS, AND JOINT SYSTEMS PLUS 1 LB/SQ.FT. INSULATION WEIGHT. IF HEAVIER DUCTS ARE TO BE INSTALLED, ADJUST HANGER SIZES TO BE WITHIN THEIR LOAD LIMITS.
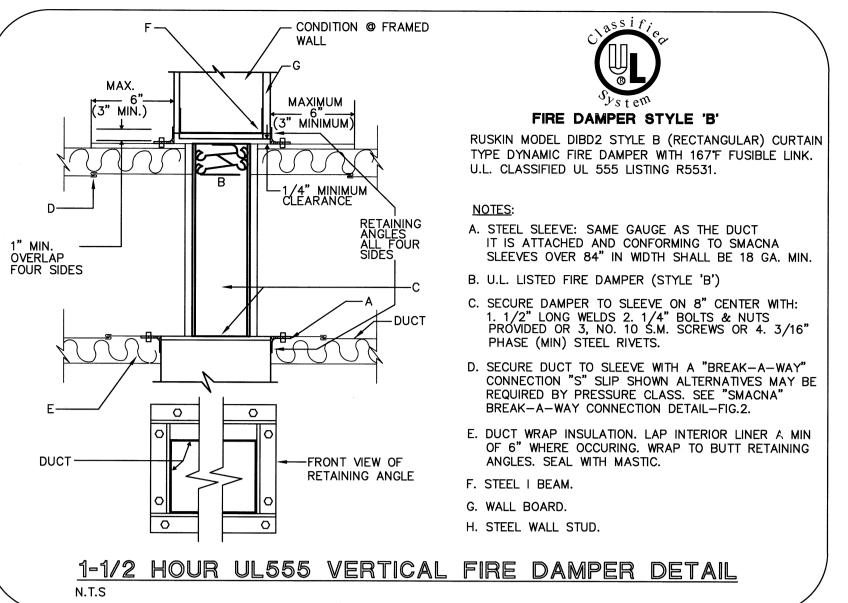
## METAL ROUND DUCT HANGER DETAIL

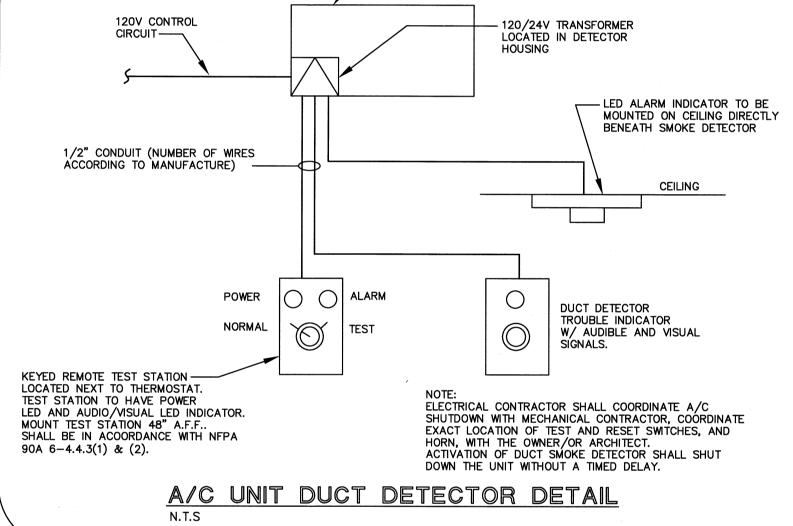

CONTROL SEQUENCE OF OPERATION: THE SYSTEM SHALL BE CONTROLLED THRU A MAIN

NORMAL MODE: WHEN THERE IS A CALL FOR COOLING ONLY, THE

REFRIGERANT CIRCULATES PER A TYPICAL PACKAGE

LIQUID REFRIGERANT LEAVES THE CONDENSER AND IS

THE EVAPORATOR. THE INDOOR AIR STREAM PASSES

OVER THE EVAPORATOR FIRST, THEN OVER THE GAS

EVAPORATOR IS PARTIALLY REHEATED TO PREVENT

WITH THE SUB-COOLED REFRIGERANT LEAVING THE

CONDENSER. THIS 2-PHASE MIXTURE IS ROUTED

THE EVAPORATOR, ADDITIONAL SUBCOOLING OF THE

REFRIGERANT OCCURS IN THE GAS REHEAT COIL, AND

IS THEN REHEATED TO NEUTRAL CONDITIONS BY THE GAS

COLDER COIL SURFACE. THE AIR COOLED AND

OVERCOOLING THE SPACE.


REHEAT COIL.


DEHUMIDIFICATION SYSTEM IS INACTIVE AND THE

SUBCOOLING MODE:
DURING PART LOAD CONDITIONS, WHEN ROOM

ROUTED THROUGH THE HOT GAS REHEAT COIL,

THERMOSTAT/HUMIDISTAT INPUT.

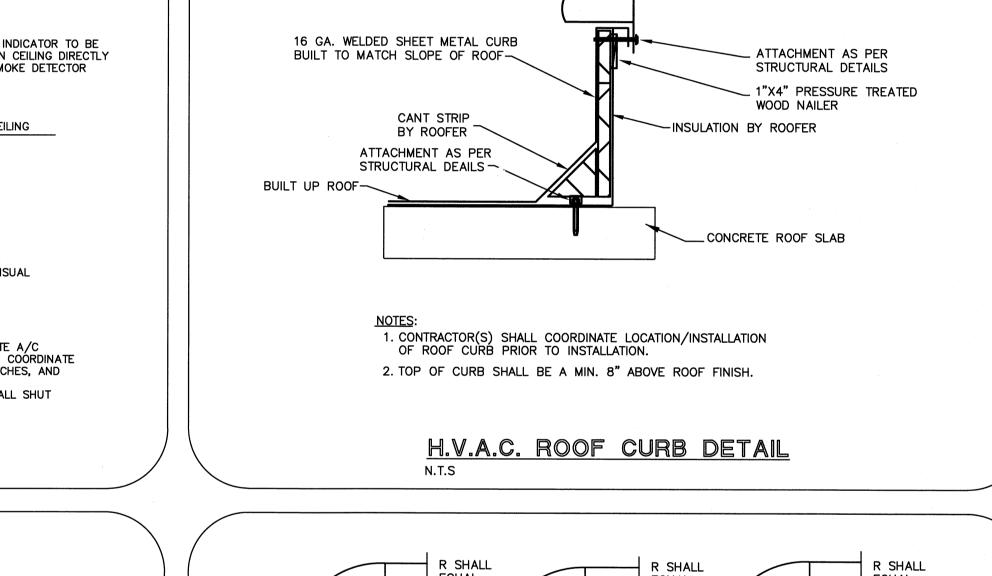

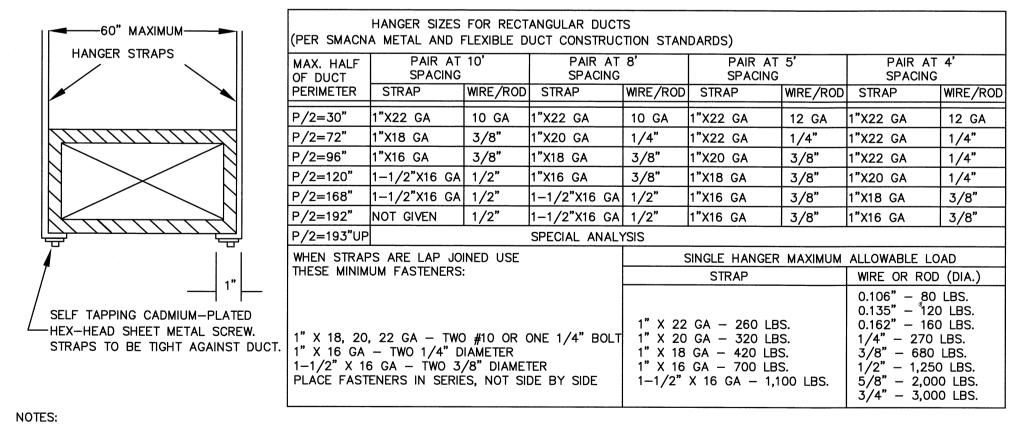


- STRAPS ARE GALVANIZED STEEL: OTHER MATERIALS ARE UNCOATED STEEL. - 12, 10, OR 8 GAGE WIRE IS STEEL OF BLACK ANNEALED, BRIGHT BASIC, OR GALVANIZED TYPE.

- DIMENSIONS OTHER THAN GAGE ARE IN INCHES.


- TABLES ALLOW FOR DUCT WEIGHT, 1 LB/SQ.FT. INSULATION WEIGHT AND NORMAL REINFORCEMENT AND TRAPEZE WEIGHT, BUT NO EXTERNAL LOADS. - ALLOWABLE LOADS FOR P/2 ASSUME THAT DUCTS ARE 16 GA MAX., EXCEPT THAT WHEN MAX. DUCT DIMENSION (W) IS OVER 60", THEN P/2 MAX. IS 1.25W.

METAL DUCT HANGER DETAIL

NTS

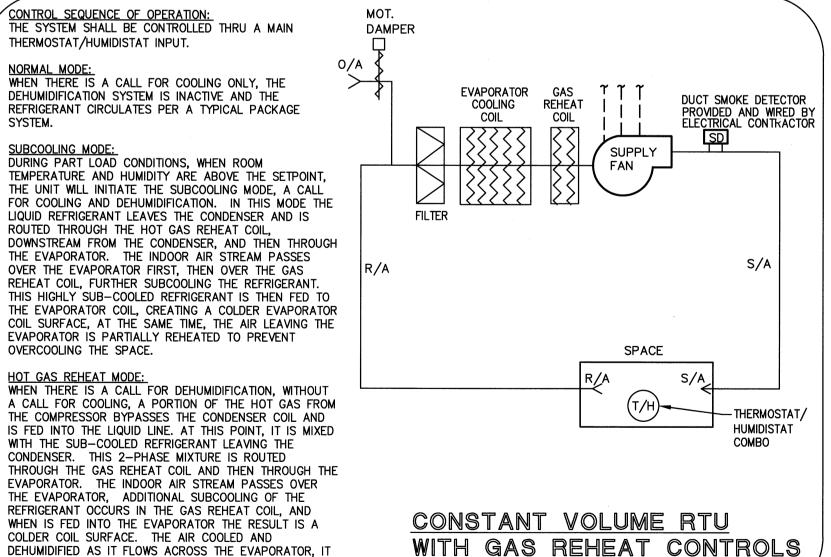

WITH GAS REHEAT CONTROLS N.T.S

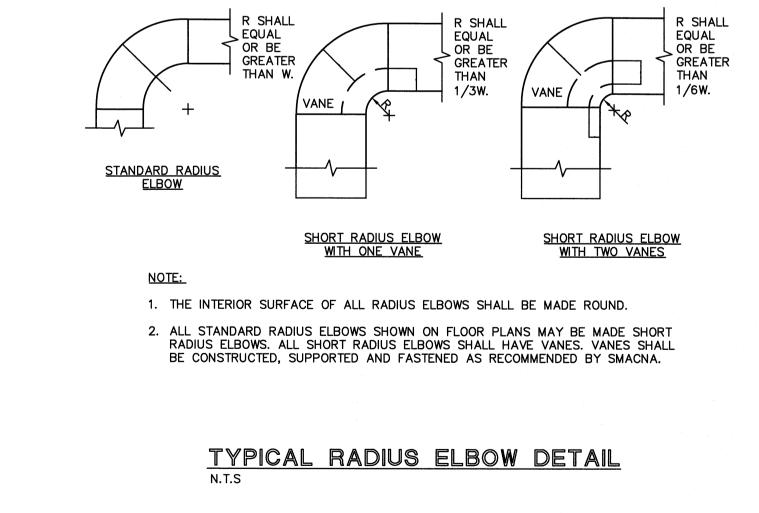



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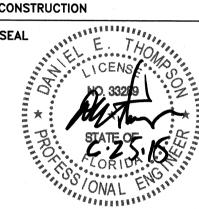
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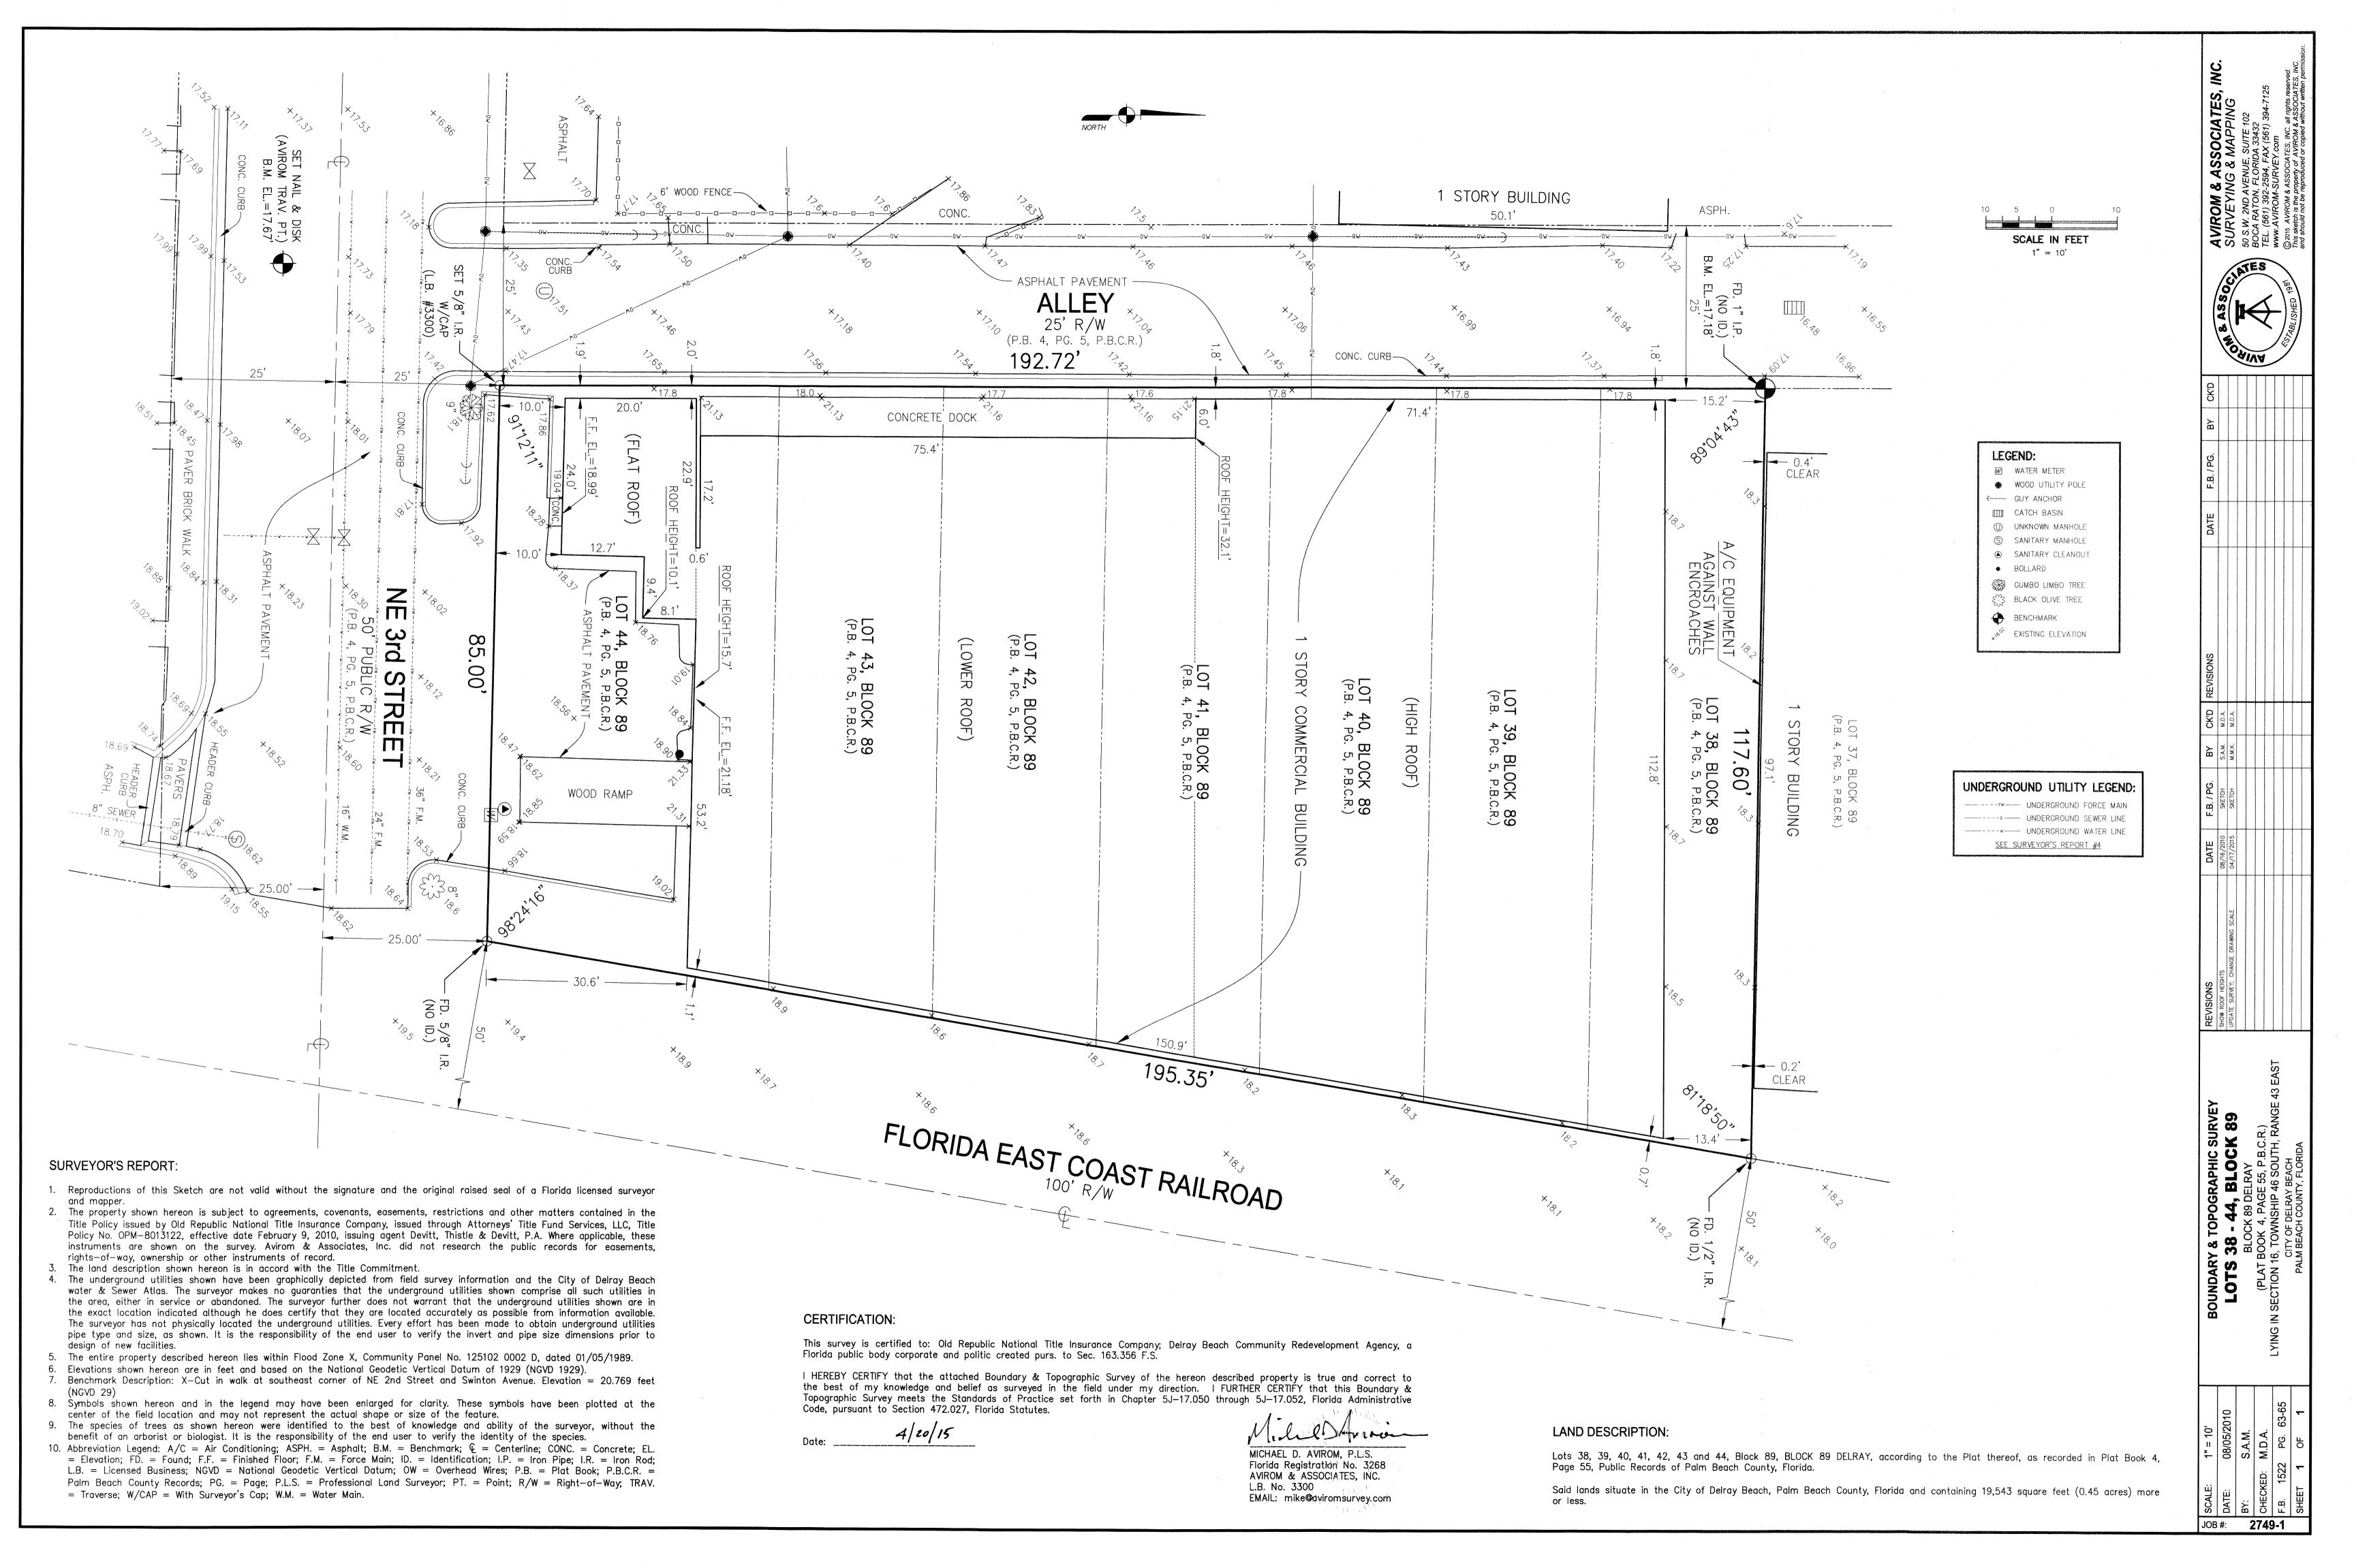
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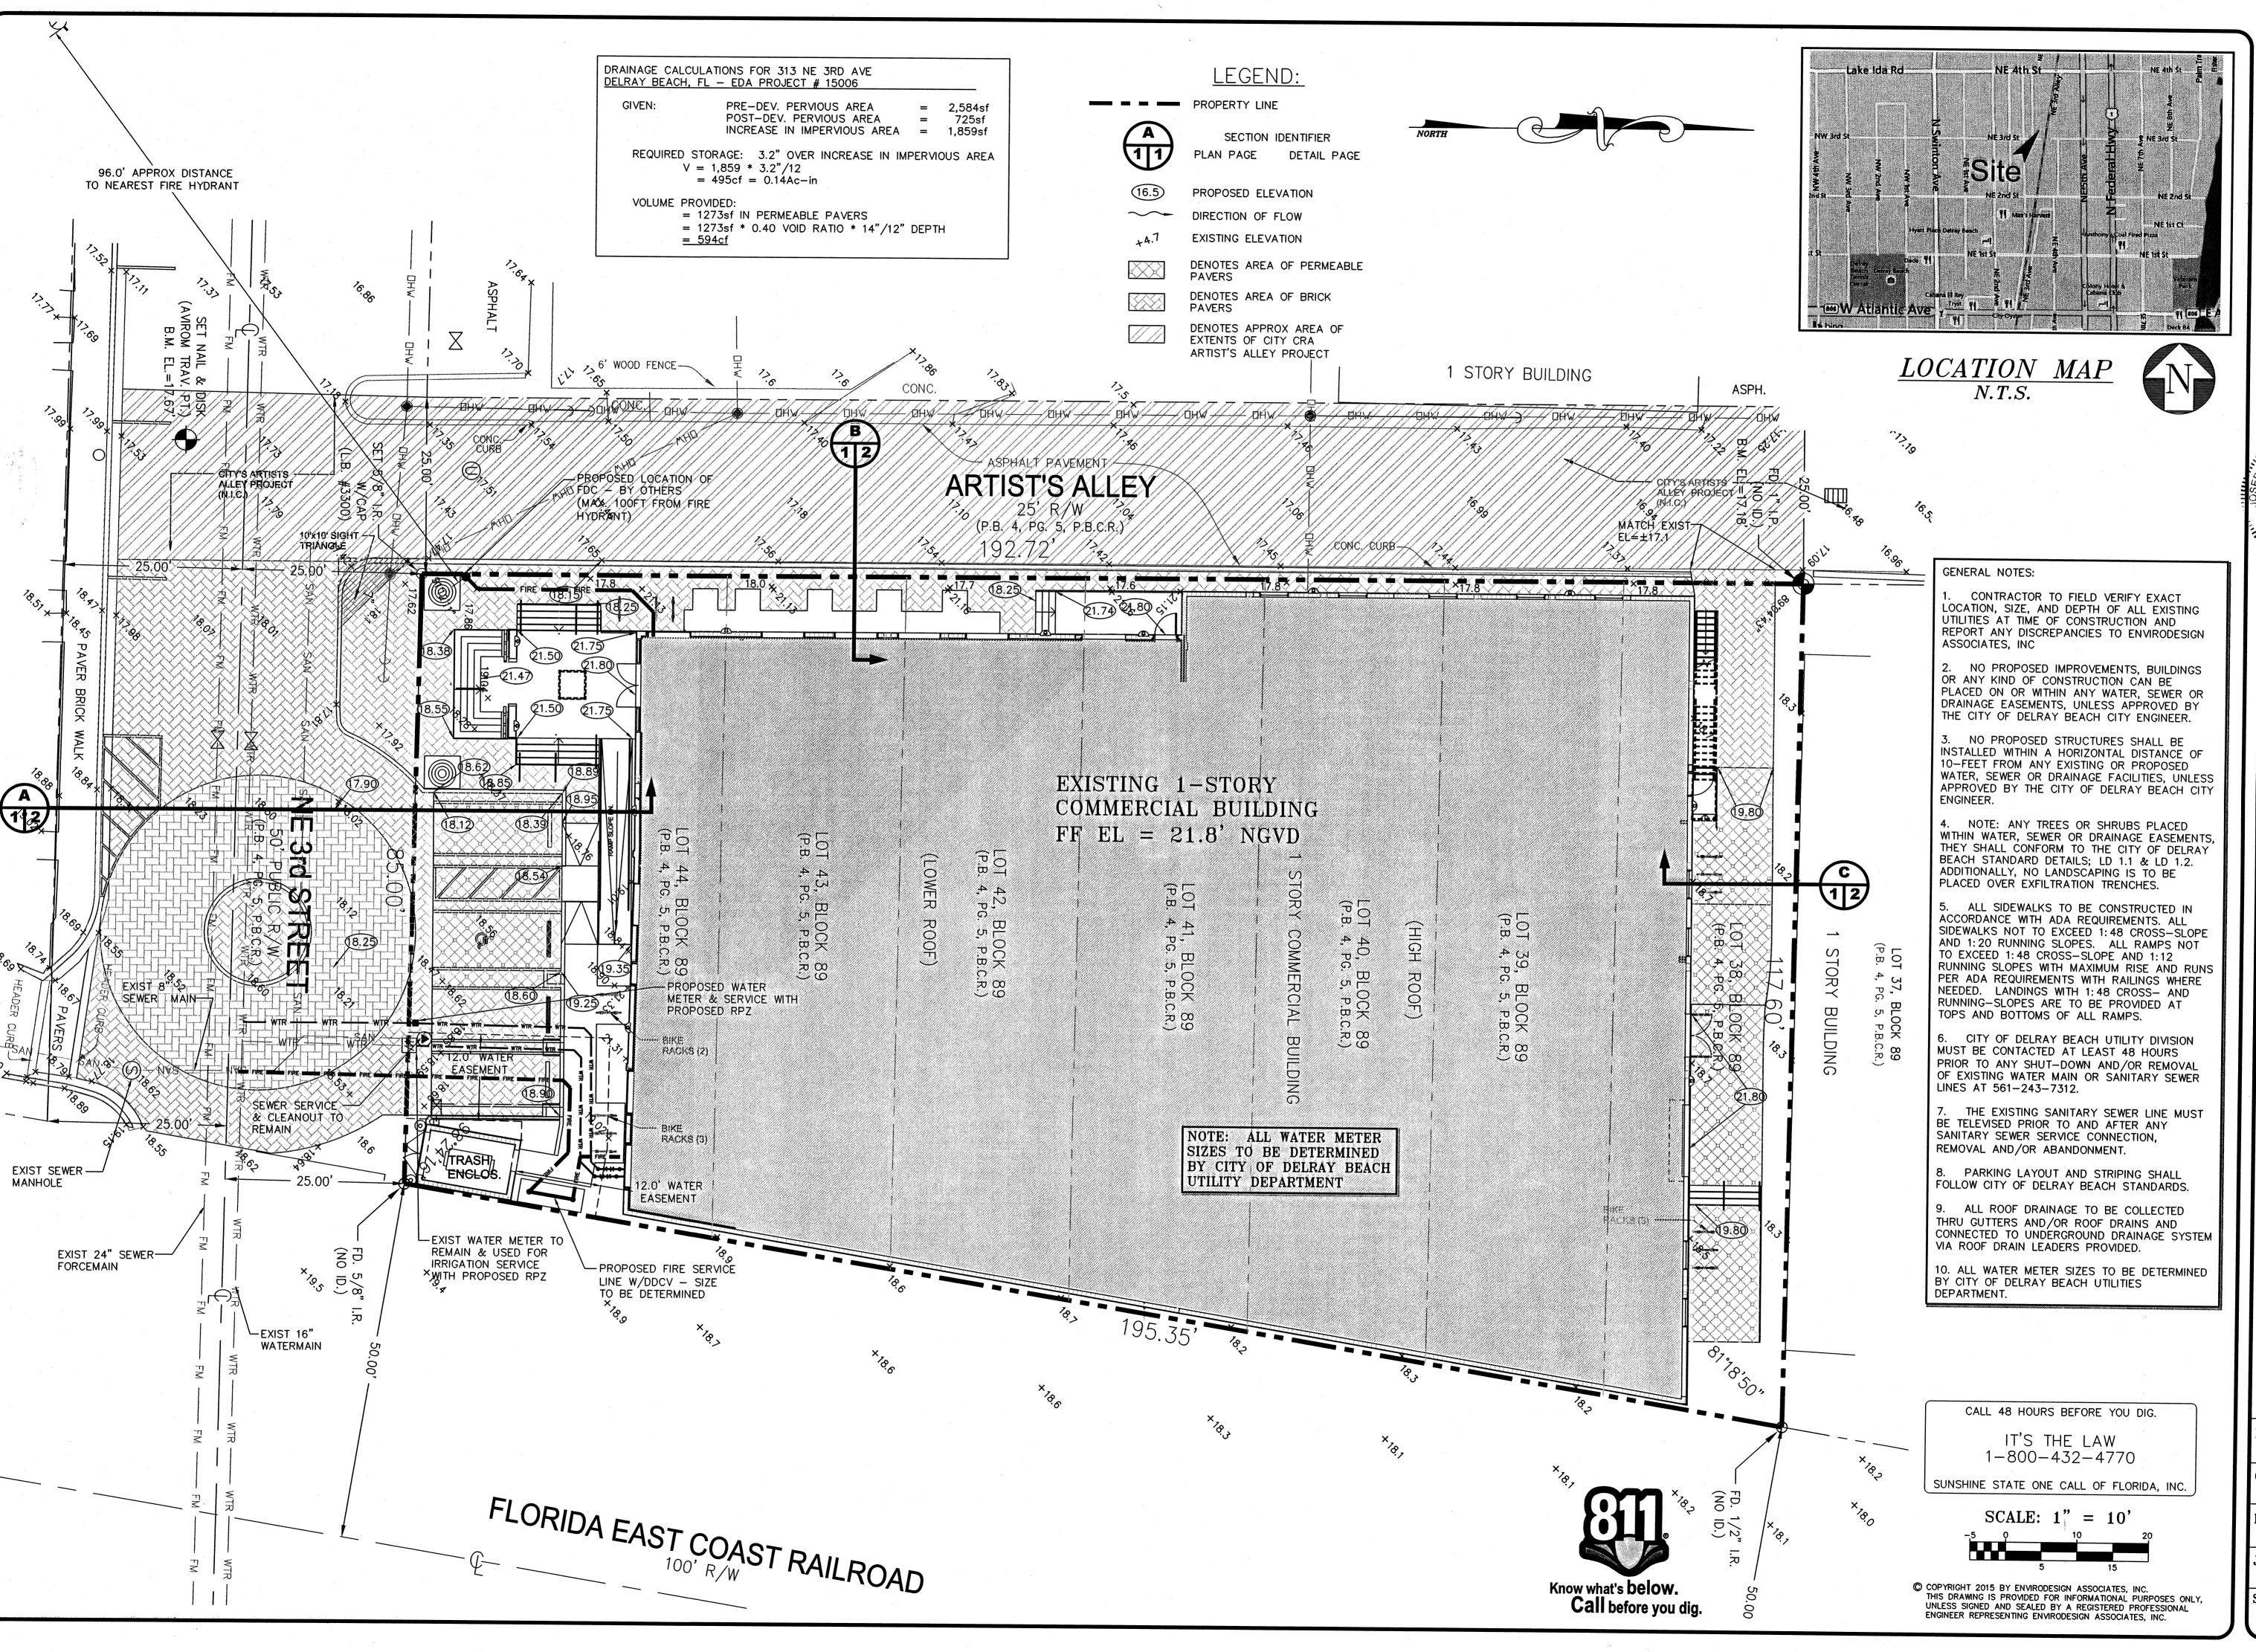
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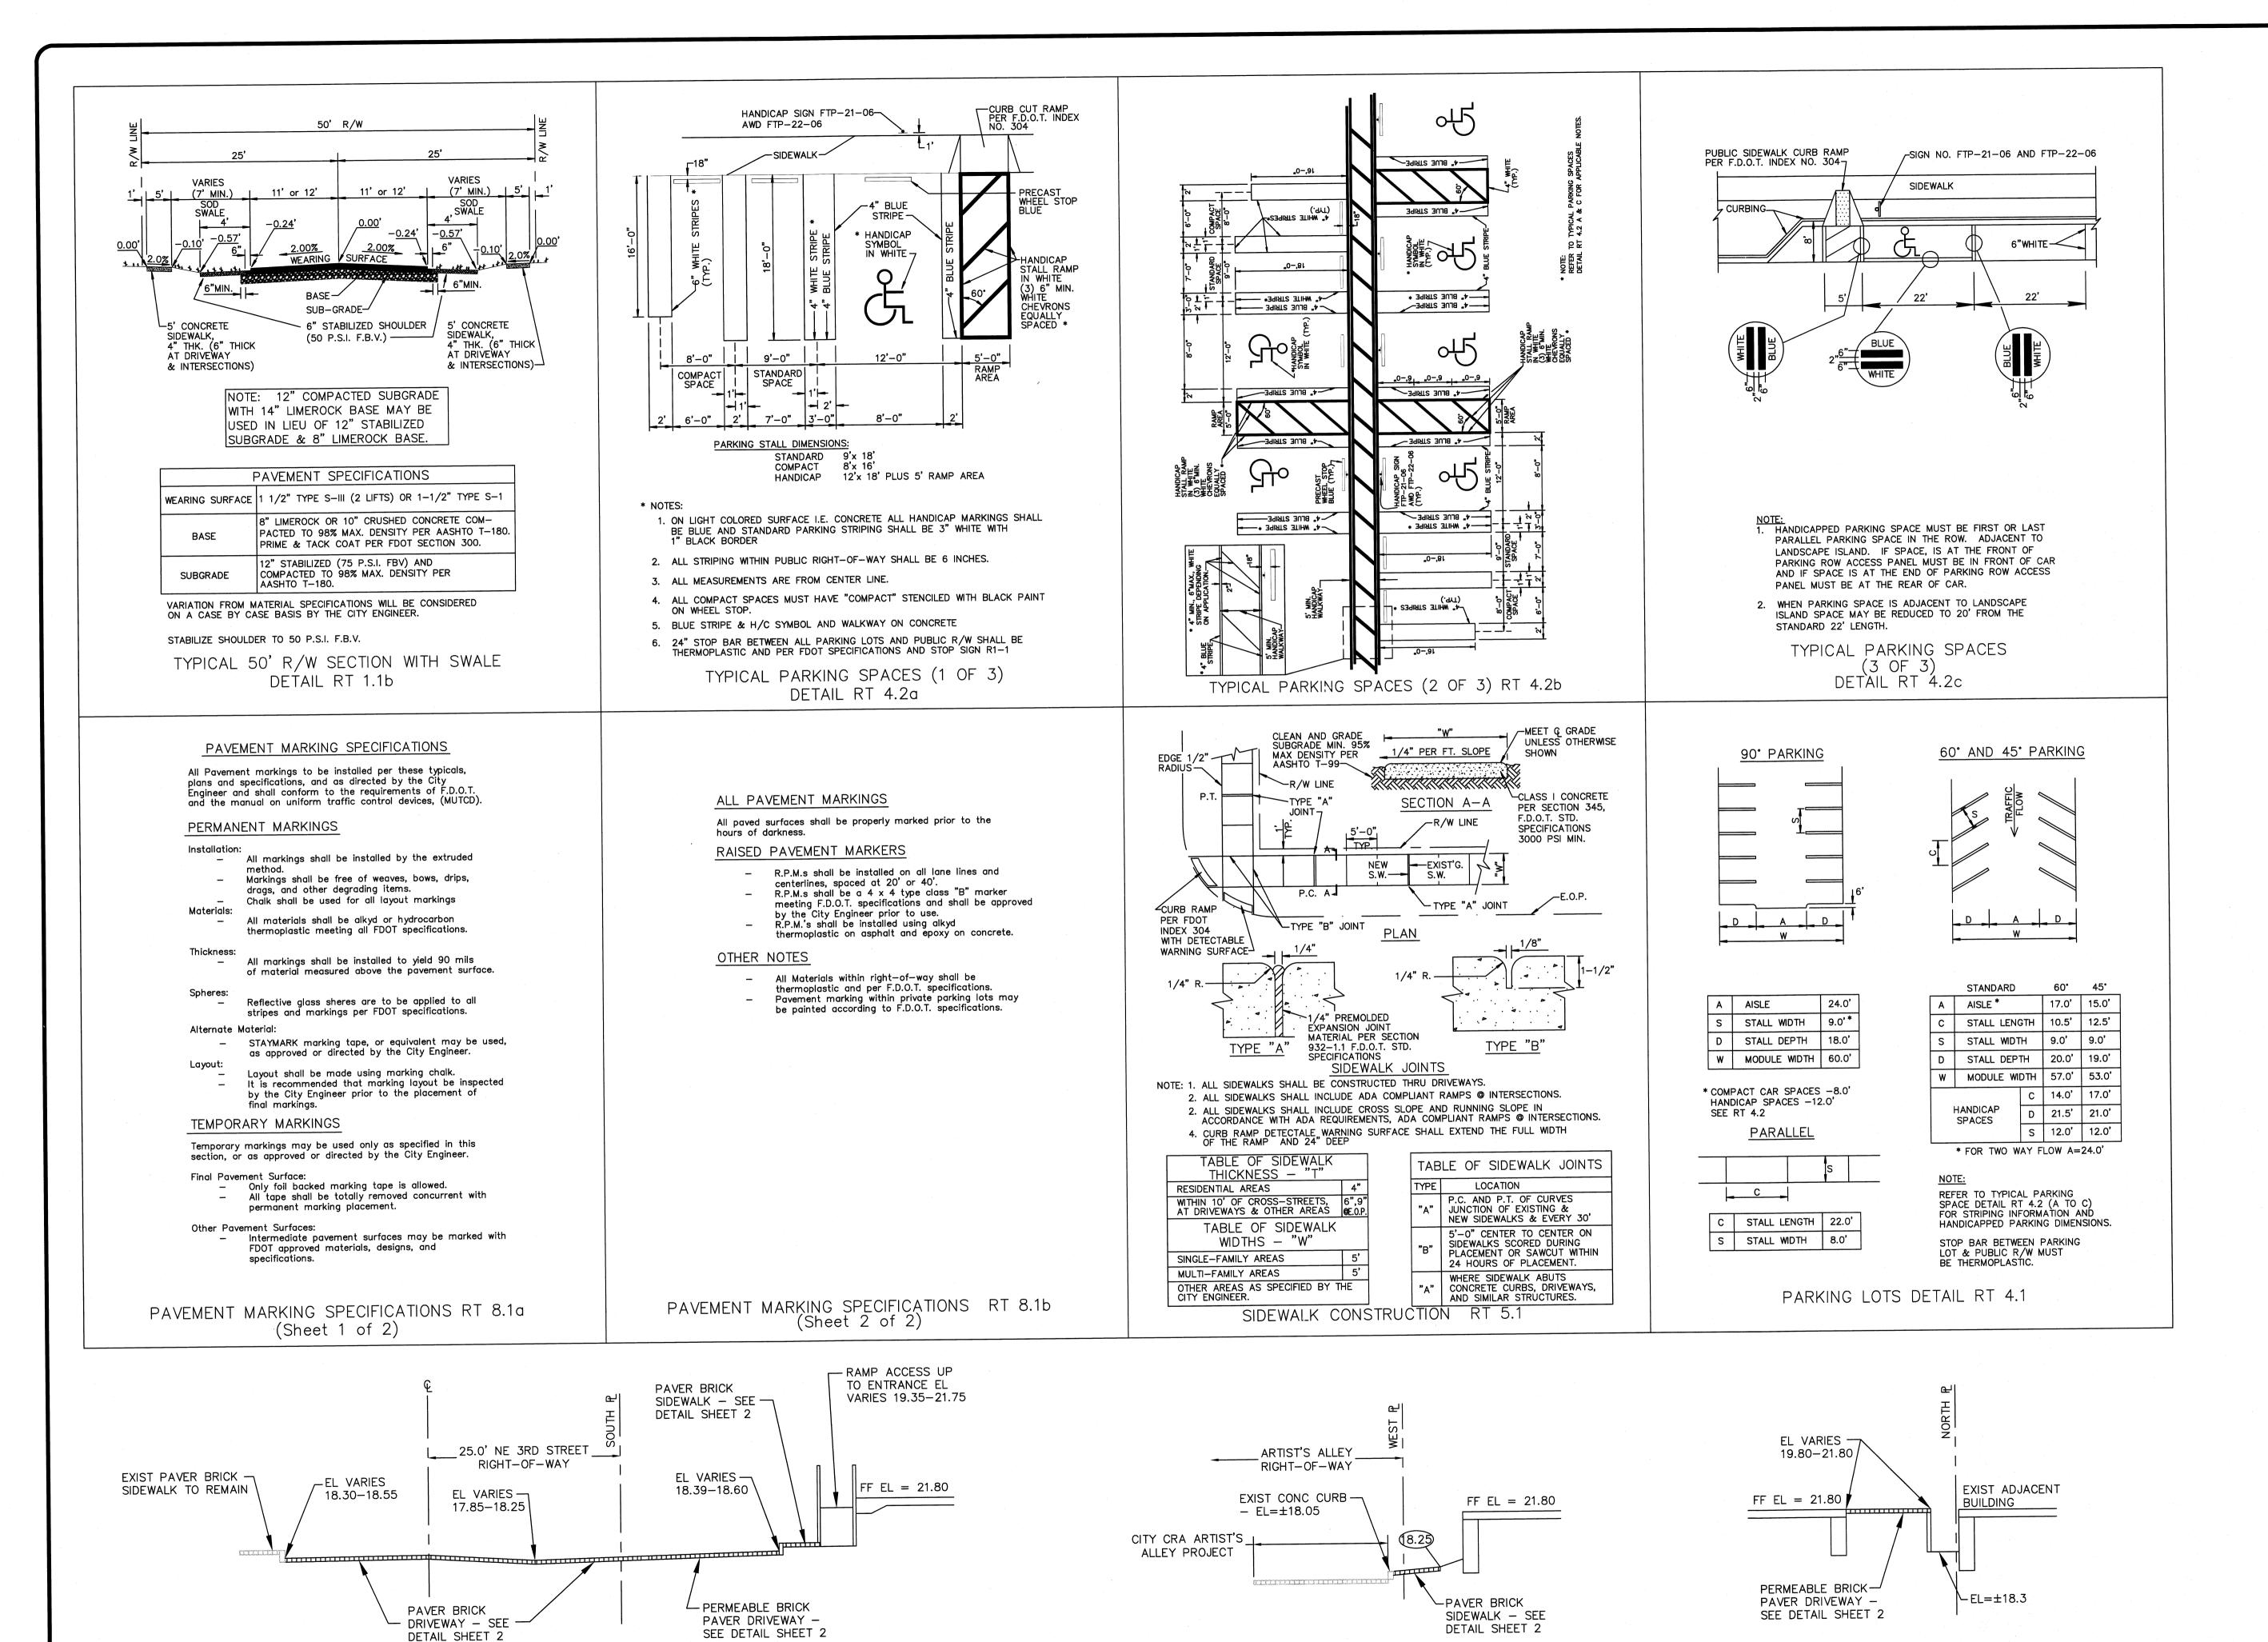
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WEST SECTION

SOUTH SECTION

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#### PAVING, GRADING AND DRAINAGE NOTES

- ALL PAVING AND DRAINAGE WORK IN THE PALM BEACH COUNTY (PBC) RIGHT-OF-WAY SHALL BE CONSTRUCTED IN FULL ACCORDANCE WITH THE PBC LATEST STANDARDS. ALL PAVING AND DRAINAGE WORK IN THE FLORIDA DEPARTMENT OF TRANSPORTATION (FDOT) RIGHT-OF-WAY SHALL BE CONSTRUCTED IN FULL ACCORDANCE WITH THE FDOT LATEST STANDARDS.
- COMPACTED SUBGRADE SHALL BE COMPACTED AND MEET THE DENSITY REQUIREMENTS AS DETERMINED BY THE AASHTO T-180 SPECIFICATIONS. SUBGRADE SHALL EXTEND 12 INCHES BEYOND THE PROPOSED EDGE OF PAVEMENT AND/OR 6" BEYOND VALLEY GUTTER, TYPE "F" CURB & GUTTER, OR TYPE "D" CURB, SUBGRADE SHALL BE 12 INCHES THICK COMPACTED TO 98% ACCORDING TO AASHTO T-180. ALL MUCK, STUMPS, ROOTS OR OTHER DELETERIOUS MATTER ENCOUNTERED IN THE PREPARATION OF THE SUBGRADE SHALL BE REMOVED COMPLETELY FROM THE CENTERLINE OF THE ROADWAY TO A WIDTH OF TEN FEET BEYOND THE EDGE OF PAVEMENT. IF SUBGRADE IS REQUIRED TO BE STABILIZED, THE REQUIRED BEARING VALUE DETERMINATIONS SHALL BE MADE BY THE FLORIDA BEARING TEST, TEST METHOD "C" OF AASHTO T-180 SPECIFICATIONS.
- 3. SHELLROCK BASE SHALL BE CONSTRUCTED IN ACCORDANCE WITH SECTION 250 OF THE FLORIA DEPARTEMENT OF TRANSPORATION STANDARD SPECIFICATIONS FOR ROAD AND BRIDGE CONSTRUCTION. LATEST EDITION. THE THICKNESS OF THE SHELLROCK BASE SHALL BE AS SHOWN ON THE DETAIL DRAWINGS AND SHALL BE COMPACTED TO A DENSITY OF 98% OF THE MAXIMUM DENSITY AS DETERMINED BY AASHTO T-180. THE SHELLROCK SHALL HAVE A MINIMUM OF 40% CARBONATES OF CALCIUM AND MAGNESIUM IN THE MATERIAL.
- 4. LIMEROCK BASE SHALL BE CONSTRUCTED IN ACCORDANCE WITH SECTION 200 OF THE FDOT STANDARD SPECIFICATIONS FOR ROAD AND BRIDGE CONSTRUCTION, LATEST EDITION. THE THICKNESS OF THE LIMEROCK BASE SHALL BE AS SHOWN ON THE DETAILED DRAWINGS AND SHALL BE COMPACTED TO A DENSITY OF 98% OF THE MAXIMUM DENSITY AS DETERMINED BY AASHTO T-180.
- 5. MUCK AND PEAT IF MUCK AND/OR PEAT ARE ENCOUNTERED IN THE ROAD OR PARKING AREA, THEY WILL BE REMOVED COMPLETELY TO A WIDTH OF TEN FEET BEYOND THE EDGE OF PAVEMENT AND SHALL BE BACKFILLED WITH GRANULAR MATERIAL. IF HARDPAN IS ENCOUNTERED IN THE SWALE AREA, IT WILL REMOVED TO A WIDTH OF TWO FEET AT THE SWALE INVERT AND REPLACED WITH GRANULAR MATERIAL.
- 6. WHERE SOD IS DESIRED, LOWER THE GRADE 2 INCHES BELOW THE FINISHED GRADE TO ALLOW FOR THE THICKNESS OF THE SOD.
- 7. CLEARING AND GRUBBING WITHIN THE LIMITS OF CONSTRUCTION ALL VEGETATION AND ROOT MATERIAL SHALL BE REMOVED.
- 8. GUMBO WHERE GUMBO OR OTHER PLASTIC CLAYS ARE ENCOUNTERED, THEY SHALL BE REMOVED WITHIN THE ROADWAY AND PARKING AREAS ONE FOOT BELOW THE SUBGRADE EXTENDING HORIZONTALLY TO THE OUTSIDE EDGE OF THE SHOULDER AREA.
- 9. PRIME COAT SHALL BE IN ACCORDANCE WITH SECTION 300 OF THE FDOT STANDARD SPECIFICATION FOR ROAD AND BRIDGE CONSTRUCTION, LATEST EDITION. PRIME COAT SHALL BE RC-70 OR ASPHALT EMULSION PRIME (AEP). PRIME COAT SHALL BE APPLIED AT A RATE OF APPLICATION NOT LESS THAN 0.10 GALLONS PER SQUARE YARD FOR LIMEROCK BASES AND NOT LESS THAN 0.15 GALLONS PER SQUARE YARD FOR SHELL ROCK OR COQUINA SHELL BASES.
- 10. TACK COAT BITUMINOUS TACK COAT SHALL CONFORM WITH THE REQUIREMENTS OF THE FDOT SPECIFICATIONS, LATEST EDITION AND SHALL BE APPLIED AT THE RATE OF 0.08 GALLONS PER SQUARE YARD, UNLESS A VARIATION IS APPROVED BY THE ENGINEER.

- 11. ASPHALTIC CONCRETE SURFACE COURSE SHALL BE IN ACCORDANCE WITH SECTION 334 OF THE FDOT STANDARD SPECIFICATIONS FOR ROAD AND BRIDGE CONSTRUCTION, LATEST ADDITION. THE THICKNESS OF THE SURFACE COURSE SHALL BE AS SHOWN ON THE DETAILED DRAWINGS.
- 12. ALL CONCRETE SHALL DEVELOP 2500 p.s.i. (MINIMUM) 28 DAY COMPRESSIVE STRENGTH OR GREATER WHERE NOTED ON PLANS. CLASS I CONCRETE SHALL CONFORM WITH THE FDOT SPECIFICATIONS, LATEST EDITION. CLASS I CONCRETE USED AS PAVING SHALL DEVELOP 3000 p.s.i. (MINIMUM) 28 DAYS. COMPRESSIVE STRENGTH.
- 13. PAVEMENT TRAFFIC STRIPES AND MARKINGS SHALL BE IN ACCORDANCE WITH CITY OF DELRAY BEACH CURRENT STANDARDS AND/OR MANUAL ON UNIFORM TRAFFIC CONTOL DEVICES FOR STREETS AND HIGHWAYS, AND/OR PALM BEACH COUNTY TRAFFIC DEPARTMENT TYPICAL T-P-10-001, WHERE APPLICABLE.
- 14. SEQUENCE OF CONSTRUCTION THE SEQUENCE OF CONSTRUCTION SHALL BE SUCH THAT ALL UNDERGROUND INSTALLATIONS OF EVERY KIND THAT ARE BENEATH THE PAVEMENT, SHALL BE IN PLACE AND HAVE PROPER DENSITY PRIOR TO THE CONSTRUCTION AND COMPACTION OF THE SUBGRADE.
- 15. INLETS AND MANHOLES ALL INLETS AND MANHOLES SHALL BE CONSTRUCTED IN ACCORDANCE WITH THE FDOT SPECIFICATIONS. LATEST EDITION, AND ROADWAY AND TRAFFIC DESIGN STANDARDS, LATEST EDITION, AND PBC STANDARDS LATEST EDITION, WHERE APPLICABLE.
- 16. GRATE ELEVATIONS REFER TO THE FLOWLINE OF THE GRATE.
- 17. GRADES SHOWN ARE FINISHED GRADES.
- 18. MINIMUM ROAD CROWN ELEVATION SHALL BE EL. TBD' N.G.V.D.
- 19. REINFORCED CONCRETE PIPE THE PIPE SHALL CONFORM WITH THE REQUIREMENTS OF CLASS III OF ASTM C-76 AND WITH THE FDOT SPECIFICATIONS, LATEST EDITION. THE FIRST JOINT OF PIPE ENTERING OR LEAVING A MANHOLE OR INLET SHALL BE WRAPPED WITH FILTER FABRIC PER FDOT SPECIFICATIONS.
- 20. CORRUGATED ALUMINUM PIPE SHALL MEET THE REQUIREMENTS OF AASHTO M196 AND SECTIONS 125, 430 AND 943 OF THE FDOT STANDARD SPECIFICATIONS FOR ROAD AND BRIDGE CONSTRUCTION. LATEST EDITION.
- 21. MEASUREMENT OF THE LENGTH OF PIPE SHALL BE FROM THE CENTER OF THE STRUCTURE TO THE CENTER OF THE STRUCTURE.
- 22. PIPE BACKFILL REQUIREMENTS FOR PIPE BACKFILL CROSSING ROADS OR PARKING AREAS SHALL BE DEFINED IN THE FDOT SPECIFICATIONS, LATEST EDITION. PIPELINE BACKFILL SHALL BE PLACED IN SIX INCH LIFTS AND COMPACTED TO 100% OF THE STANDARD PROCTOR (AASHTO) T-99 SPECIFICATIONS.
- 23. THE CONTRACTOR SHALL SUBMIT TO THE ENGINEER THREE (3) CERTIFIED COPIES OF A CHEMICAL AND SIEVE ANALYSIS OF THE SHELL ROCK BY A STATE OF FLORIDA CERTIFIED LAB WHEN CONSTRUCTING A SHELL ROCK BASE FOR ROADWAY.
- PRIOR TO CERTIFICATION OF THE DRAINAGE SYSTEM, THE CONTRACTOR MUST PUMP DOWN AND LAMP THE DRAINAGE SYSTEM FOR INSPECTION BY THE ENGINEER AFTER FINISHED ROCK FOR THE ROADWAYS HAS BEEN INSTALLED.

#### GENERAL NOTES

- CONTRACTOR SHALL PROTECT ALL PERMANENT REFERENCE MONUMENTS AND TAKE ALL PRECAUTIONS NECESSARY TO AVOID SURVEY MARKERS DURING CONSTRUCTION. CONTRACTOR SHALL BE RESPONSIBLE FOR REPLACEMENT OF PERMANENT REFERENCE MONUMENTS DISTURBED DURING CONSTRUCTION, AT NO ADDITIONAL COST TO THE OWNER.
- 2. CONTRACTOR SHALL BE RESPONSIBLE FOR THE PROTECTION OF ALL EXISTING UNDERGROUND UTILITIES WHETHER OR NOT SHOWN ON THE PLANS. UTILITIES SHOWN ON THE PLANS ARE FOR REFERENCE ONLY AND MAY NOT DEPICT ACTUAL LOCATIONS. CONTRACTOR SHALL NOTIFY ALL UTILITY COMPANIES FOR LOCATION AND DEPTH OF THEIR LINES PRIOR TO CONSTRUCTION.
- 3. CONTRACTOR SHALL BE RESPONSIBLE TO COORDINATE AND PAY FOR THE DEENERGIZING OF POWER LINES AND/OR HOLDING POWER POLES DURING CONSTRUCTION AT NO ADDITIONAL COST TO THE OWNER.
- CONTRACTOR SHALL BE RESPONSIBLE TO COORDINATE AND PAY FOR THE REPLACEMENT OF TRAFFIC LOOPS IF DAMAGED DURING CONSTRUCTION AT NO ADDITIONAL COAST TO THE OWNER.
- 5. ALL ELEVATIONS REFER TO N.G.V.D. 1929. MINIMUM FINISHED FLOOR ELEVATION FOR ANY RESIDENTIAL STRUCTURE SHALL BE SET AT OR ABOVE ELEVATION TBD' (WHICH IS ABOVE THE 100-YEAR FREQUENCY STORM).
- SHOP DRAWINGS SHALL BE SUBMITTED TO THE ENGINEER FOR REVIEW PRIOR TO CONSTRUCTION OR INSTALLATION AS REQUIRED BY THE ENGINEER OR BY THE APPROPRIATE GOVERNING AGENCIES.
- CONTRACTOR SHALL BE RESPONSIBLE TO SECURE AND PAY FOR, AT NO ADDITIONAL COST TO THE OWNER, ALL NECESSARY PERMITS. FEES AND LICENSES.
- 8. CONTRACTOR SHALL BE RESPONSIBLE FOR GIVING THE REQUIRED NOTICES AND COMPLYING WITH ALL PERMIT(S) CONDITIONS.
- 9. CONTRACTOR SHALL BE RESPONSIBLE TO COORDINATE AND PAY FOR THE HOLDING OF OTHER UTILITY POLES DURING CONSTRUCTION AT NO ADDITIONAL COST TO THE OWNER.
- 10. ALL CONCRETE SHALL DEVELOP 2500 p.s.i. (MINIMUM) 28 DAY COMPRESSIVE STRENGTH OR GREATER WHERE NOTED ON PLANS. CLASS I CONCRETE SHALL CONFORM WITH THE FDOT SPECIFICATIONS, LATEST EDITION. CLASS I CONCRETE USED AS PAVING SHALL DEVELOP 3000 p.s.i. (MINIMUM) 28 DAYS COMPRESSIVE STRENGTH.
- 11. ALL UTILITY CONSTRUCTION SHALL BE IN ACCORDANCE WITH THE REQUIREMENTS OF THE LOCAL UTILITY.

- 12. ENVIRODESIGN ASSOC. INC. SHALL NOT BE RESPONSIBLE FOR THE SAFETY OF THE WORKERS OR THE GENERAL PUBLIC. CONTRACTOR SHALL BE RESPONSIBLE FOR PROVIDING SAFETY TO THE WORKERS IN ACCORDANCE WITH OCCUPATIONAL SAFETY & HEALTH ADMINISTRATIONS (OSHA) REQUIREMENTS AND THE SAFETY OF THE GENERAL PUBLIC.
- 13. ALL MATERIALS AND WORKMANSHIP MUST BE IN ACCORDANCE WITH THE LOCAL UTILITY STANDARDS AND SPECIFICATIONS.
- 14. THE CONTRACTOR SHALL CALL SUNSHINE 1-800-432-4770 48 HOURS BEFORE DIGGING FOR FIELD LOCATIONS OF UNDERGROUND UTILITIES.
- 15. CORRUGATED ALUMINUM PIPE USED BENEATH PAVEMENT SHALL BE IN CONFORMANCE WITH SEC. 8.24.E.5.i
- 16. ALL CONSTRUCTION ACTIVITY, INCLUDING TRENCHING, IS TO BE A MINIMUM OF SIX FEET FROM THE BASE OF ANY TREE THAT IS DESIGNATED TO REMAIN.
- 17. ALL LIMEROCK AND BASE MATERIALS SHALL BE REMOVED FROM THE PLANTER AREAS/ISLANDS AND REPLACED WITH APPROPRIATE PLANTING SOIL PRIOR TOT THE LANDSCAPING OF THE SITE.
- 18. THE REMOVAL OF ANY TREE ON THE SITE IS PROHIBITED WITHOUT THE REQUIRED PERMITS.
- 19. ALL MATERIALS AND CONSTRUCTION WITHIN THE FDOT RIGHT-OF-WAY SHALL CONFORM TO THE FDOT DESIGN STANDARDS FOR DESIGN, CONSTRUCTION, MAINTENANCE AND UTILITY OPERATIONS ON THE STATE HIGHWAY SYSTEM (LATEST ED.).
- 20. LANE CLOSURES WITHIN THE FDOT RIGHT-OF-WAY SHALL BE LIMITED TO THE HOURS OF 9AM-3PM, MONDAY-FRIDAY EXCLUDING GOVERNMENTAL HOLIDAYS. MAINTENANCE OF TRAFFIC SHALL BE PROVIDED IN ACCORDANCE WITH INDEX 613 OF THE FDOT DESIGN STANDARDS (LATEST ED.)

M. & DRAI AREF

I RONMENTAL CONSULT
ATE OF AUTHORIZATION No. 6506

May Delray Beach, Florida 33444


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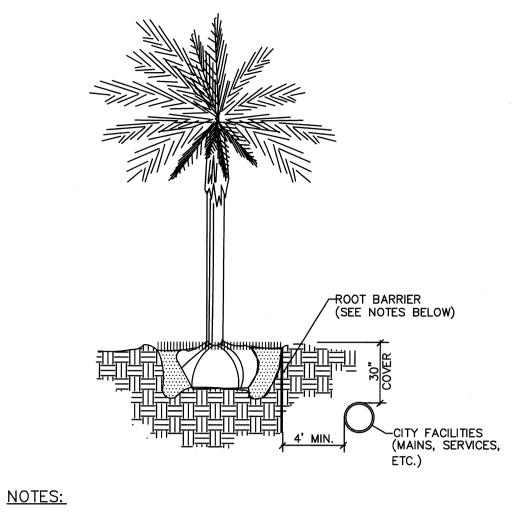
6/25/15

JOB NO. 15006-DTL

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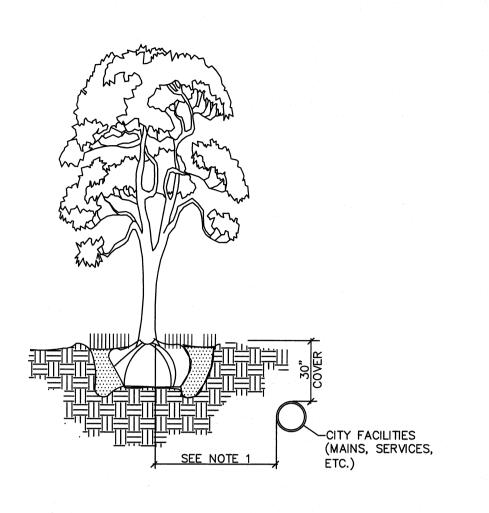




1. ALL ROOT BARRIERS SHALL BE 4' MINIMUM FROM ALL CITY FACILITIES.

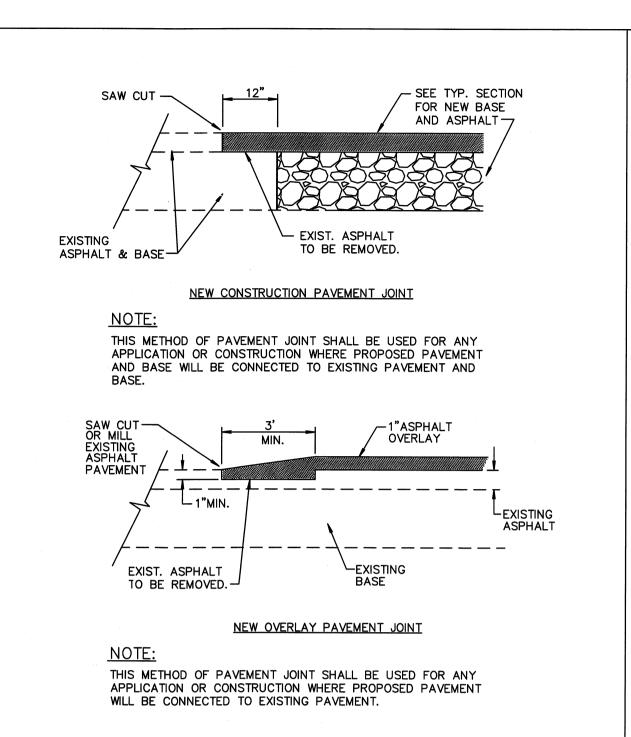- 2. THE INSTALLATION OF ROOT BARRIERS SHALL BE COORDINATED WITH CITY AND INSPECTED BY CITY PRIOR TO BACKFILLING. ALL ROOT BARRIERS SHALL EXTEND UP TO FINISHED GRADE.
- 3. ROOT BARRIERS SHALL BE MINIMUM 36" DEEP. APPROVED PRODUCTS INCLUDE "DEEP ROOT" AND "ROOT SOLUTIONS". FLEXIBLE BARRIERS SHALL BE 36" PANELS MANUFACTURED BY BIOBARRIER.
- 4. ALL ROOT BARRIERS SHALL BE INSTALLED IN ACCORDANCE WITH MANUFACTURERS WRITTEN INSTRUCTIONS.


TYPICAL TREE WITH ROOT BARRIER LD 1.1




NOTES:

1. THIS DISTANCE SHALL BE 10' MINIMUM FROM ALL CITY FACILITIES IF NO ROOT BARRIER IS USED.

TYPICAL TREE WITHOUT ROOT BARRIER LD 1.2

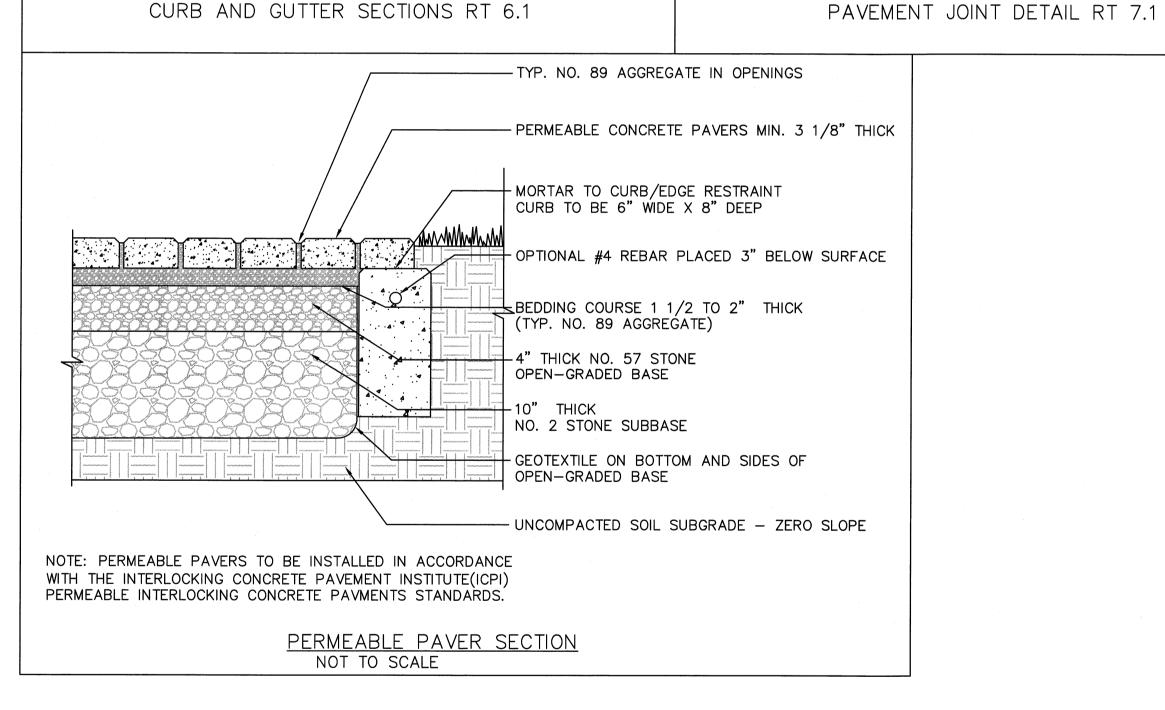

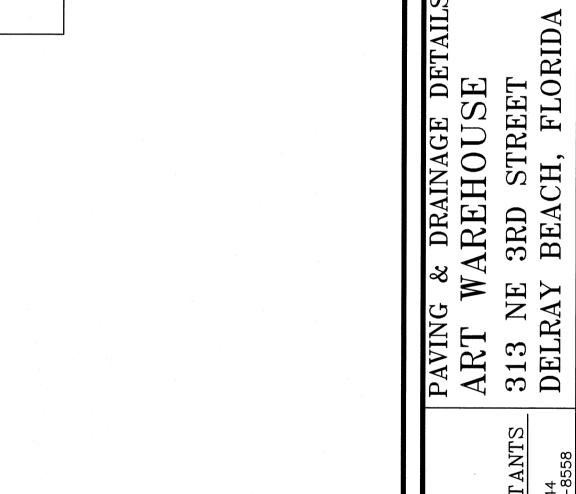

| EnviroDesign | Associates Inc. | Associates Inc. | www.envdesign.com | www.envdesign.com | www.envdesign.com | S - ENVIRONMENTAL CONSULTANTS | NRIDA CERTIFICATE OF AUTHORIZATION No. 6506 | Neapple Grove Way Delray Beach, Florida 33444 | Preparation | Province | Nature | Province | Prov

ENGINEERS FLORIE DRAWN: M.T.J.

CHECKED: J.A.P. DATE: 6/25/15

JOB NO. 15006-DTL


SHEET NO. 4 of 6

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JOB NO. 15006-DTL

SHEET NO.

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SANITARY

SEWER MAIN-

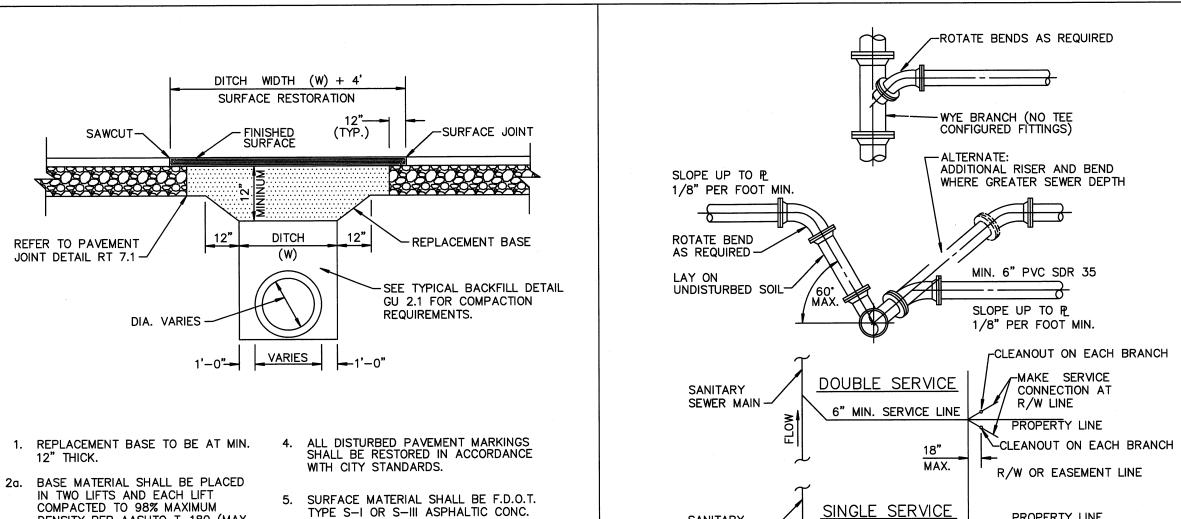(MIN. THICKNESS 1 1/2").

TRAFFIC FLOW.

ANY PAVT. CUTS SHALL BE COLD PATCHED AT END OF EACH WORKING DAY TO FACILITATE UNHINDERED

1. SERVICE LATERALS SHALL TERMINATE INSIDE PROPERTY LINE A DEPTH OF 3 FEET AND MARKED WITH A 2"X 4" TREATED STAKE.

6" MIN. SERVICE LINE

PROPERTY LINE

R/W OR EASEMENT LINE


13' MAXIMUM

CLEANOUT

2. CLEANOUT INSTALLATION SHALL BE PROPERTY OWNERS RESPONSIBILITY AND SHALL BE INSTALLED BY LICENSED PLUMBER.


3. SEE DETAIL PW 2.1 FOR SEPARATION REQUIREMENTS.

SEWER SERVICE CONNECTIONS WW 4.1

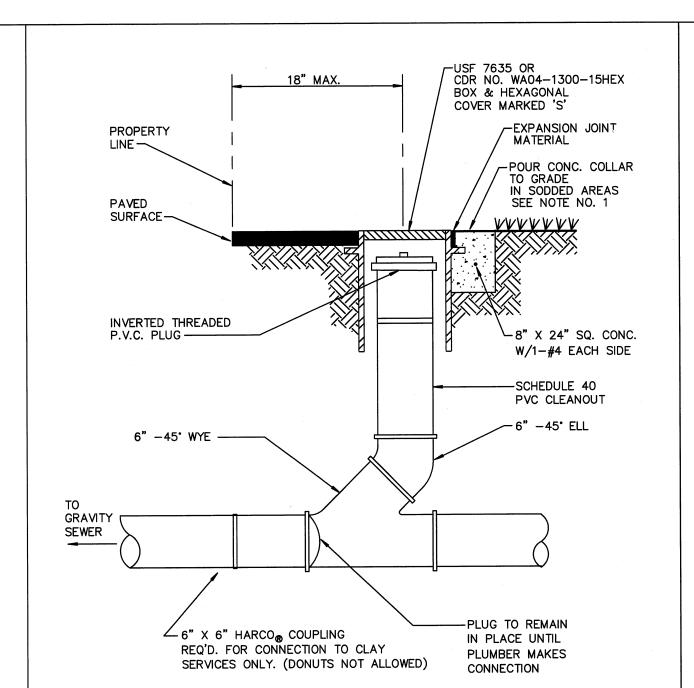

1. INVERTED BRASS CAP SHALL BE USED IN GRASS AREAS IN LIEU OF CASTING AND CONE COLLAR. 2. MINIMUM DEPTH OF SERVICE LATERAL SHALL BE 3 FEET.


TYPICAL COMMERCIAL CLEANOUT WW 5.2

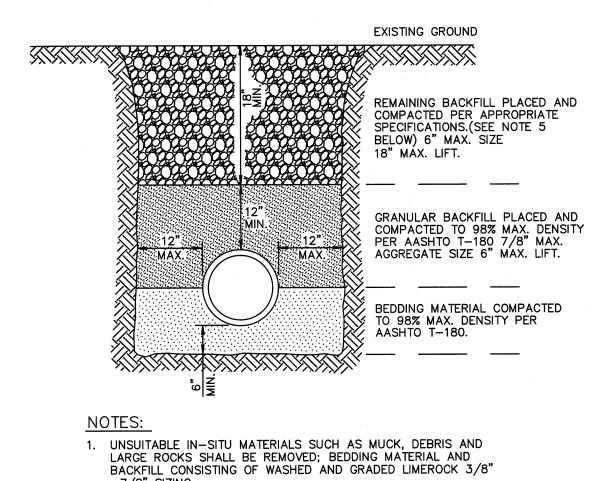

-7/8" SIZING.

- 2. THE PIPE AND/OR STRUCTURE SHALL BE FULLY SUPPORTED FOR ITS ENTIRE LENGTH WITH APPROPRIATE COMPACTION UNDER THE PIPE
- 3. THE PIPE AND/OR STRUCTURE SHALL BE PLACED IN A DRY TRENCH. 4. BACKFILL SHALL BE FREE OF UNSUITABLE MATERIAL SUCH AS
- LARGE ROCK, MUCK, AND DEBRIS.
- 5. COMPACT BACKFILL TO 98% DENSITY UNDER PAVEMENT AND TO 95% DENSITY ELSEWHERE.(AASHTO T-180)
- 6. COMPACTION AND DENSITY TESTS SHALL BE COMPLETED DURING BACKFILL OPERATIONS, CONTRACTORS NOT FOLLOWING THIS PROCEDURE, FOR WHATEVER REASONS, SHALL BE REQUIRED TO RE-EXCAVATE THE AREA IN QUESTION, DOWN TO THE BEDDING MATERIAL, THEN BACKFILL FOLLOWING THE ABOVE PROCEDURES.

TYPICAL BACKFILL DETAIL GU 2.1

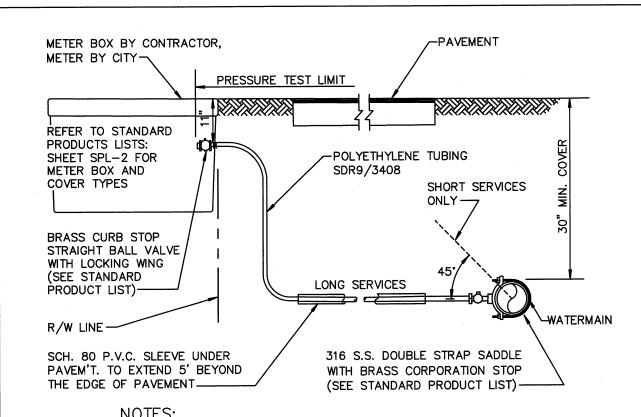

PAVEMENT REPAIR DETAIL GU 1.1

DENSITY PER AASHTO T-180 (MAX.

MIN. 100 P.S.I. MAY BE USED IN LIEU

LIFT THICKNESS = 6").

OF 12" BASE.


2b. 12" EXCAVATABLE FLOWABLE FILL

3. ASPHALT CONCRETE PAVEMENT

JOINTS SHALL BE MECHANICALLY SAWED.


- 1. SUCCESSIVE TAPS INTO THE WATER MAIN SHALL BE SPACED
- A MINIMUM OF 18" ON CENTER. 2. SERVICE LINES SHALL NOT BE PLACED UNDER DRIVEWAYS.
- 3. ALL METERS REQUIRE A LOCKING BRASS CURB STOP WITH LOCK WING (1"MIN.).
- 4. NO FITTINGS BETWEEN CORPORATION STOP AND BRANCH
- 5. MAXIMUM SERVICE LENGTH IS 100' TO METER. 6. CASING PIPE I.D. SHALL BE SERVICE O.D. PLUS 1" MINIMUM.
- 7. MINIMUM BEND RADIUS ON SERVICES SHALL BE 14".
- ON ALL SERVICES BEHIND METER. 8. METER SIZE WILL BE DETERMINED BY PUBLIC UTILITIES DEPT. UPON APPLICATION FOR SERVICE.
- ALL VALVES TO BE BALL VALVES.
- 10. METER BOX SHALL BE PROVIDED AND INSTALLED BY CONTRACTOR.

TYPICAL SERVICE CONNECTION PW 9.1a

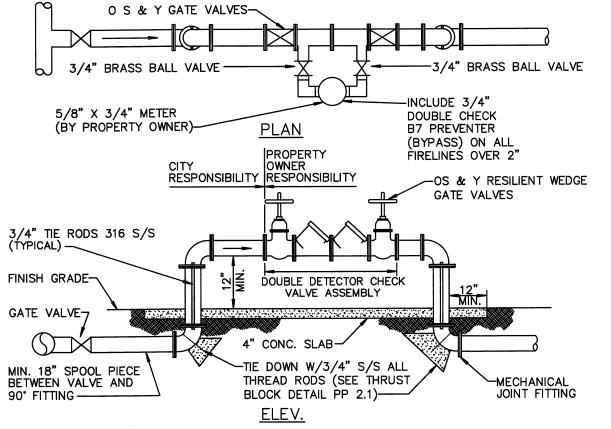


- 1. FOR ALL SERVICES GREATER THAN 2" DIA. 2. ALL PIPE AND FITTINGS SHALL BE CLASS 52 DUCTILE IRON CEMENT LINED WITH CEMENT LINED DUCTILE IRON FLANGE FITTINGS FOR ABOVE GROUND USE. MECHANICAL JOINT SHALL BE USED UNDERGROUND IN ACCORDANCE WITH AWWA STANDARDS.
- THE DOUBLE DETECTOR CHECK VALVE ASSEMBLY SHALL MEET AWWA C511-89, AND APPROVAL OF ENVIRONMENTAL SERVICES DEPARTMENT.
- 4. CERTIFICATION OF PROPER INSTALLATION AND OPERATION WILL BE REQUIRED FROM A CERTIFIED BACKFLOW PREVENTION TECHNICIAN PRIOR TO WATER MAIN ACCEPTANCE BY
- THE PROPERTY OWNER SHALL BE RESPONSIBLE FOR THE PROPER OPERATION, MAINTENANCE AND TESTING OF THE DOUBLE DETECTOR CHECK VALVE ASSEMBLY.
- 6. BOLLARDS TO BE USED IF THE ASSEMBLY IS WITHIN 5' OF THE PAVEMENT, REFER TO BOLLARD DETAIL PW 5.2.
- 7. ALL TWO INCH DOUBLE DETECTOR CHECK VALVE, SHALL BE BRASS OR
- TYPE "L" COPPER TUBING 8. USE OF OTHER PIPE MATERAILS WITH APPROVAL OF WATER SEWER MANAGER.
- 9. CITY MAINTAINS UP TO THE FIRST O S & Y VALVE.

DOUBLE DETECTOR CHECK VALVE PW 10.1

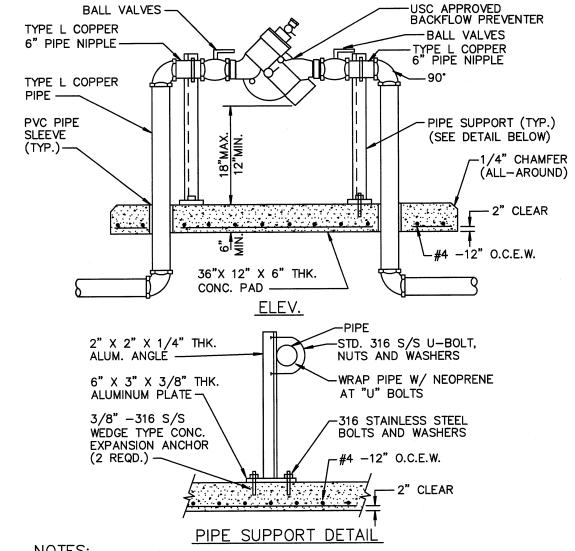

- 1. FOR ALL SERVICES LESS THAN OR EQUAL TO 2" DIA. 2. ABOVE GRADE PIPING SHALL BE BRASS OR TYPE "L" COPPER TUBING.
- 3. ALL COPPER JOINTS SHALL BE MADE WITH 95/5 SOLDER.
- 4. RPZ BACKFLOW PREVENTER IS REQUIRED IN ACCORDANCE WITH CITY OF DELRAY BEACH CODE OF ORDINANCES TITLE V, CHAPTER 52.80.
- 5. USE OF OTHER PIPE MATERIALS WITH APPROVAL OF DEPUTY DIRECTOR OF UTILITIES.
- 4. RPZ BACKFLOW PREVENTER IS REQUIRED FOR ALL COMMERCIAL PROPERTIES AND ALL RESIDENTAL PROPERTIES WITH FIRE SPRINKLER SYSTEMS.
- REDUCED PRESSURE ZONE BACKFLOW PREVENTER PW 10.2

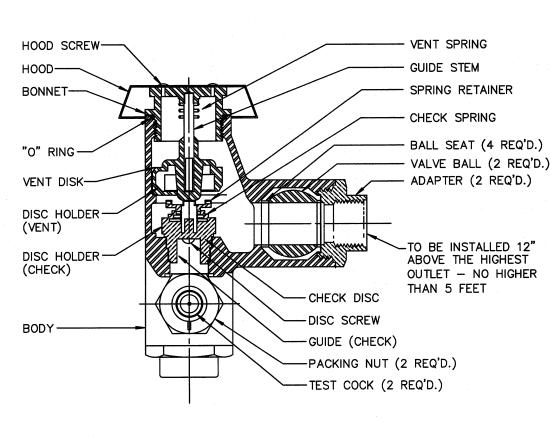

TYPICAL IRRIGATION SYSTEM ANTI-SIPHON PRESSURE TYPE VACUUM BREAKER

NOTES:

- 1. WATTS REGULATOR COMPANY OR EQUIVALENT. 2. VALVE SHALL MEET OR EXCEED THE A.S.S.E., BS&A AND
- U.S.C.F. REQUIREMENTS.
- 3. SHALL ALSO BE LISTED BY IAPMO (UPC).
- 4. USE OF OTHER PIPE MATERIALS WITH APPROVAL OF DEPUTY DIR. OF UTILITIES.

5. ABOVE GRADE PIPING SHALL BE PVC OR COPPER.

ANTI-SIPHON PRESSURE TYPE VACUUM BREAKER PW 10.3


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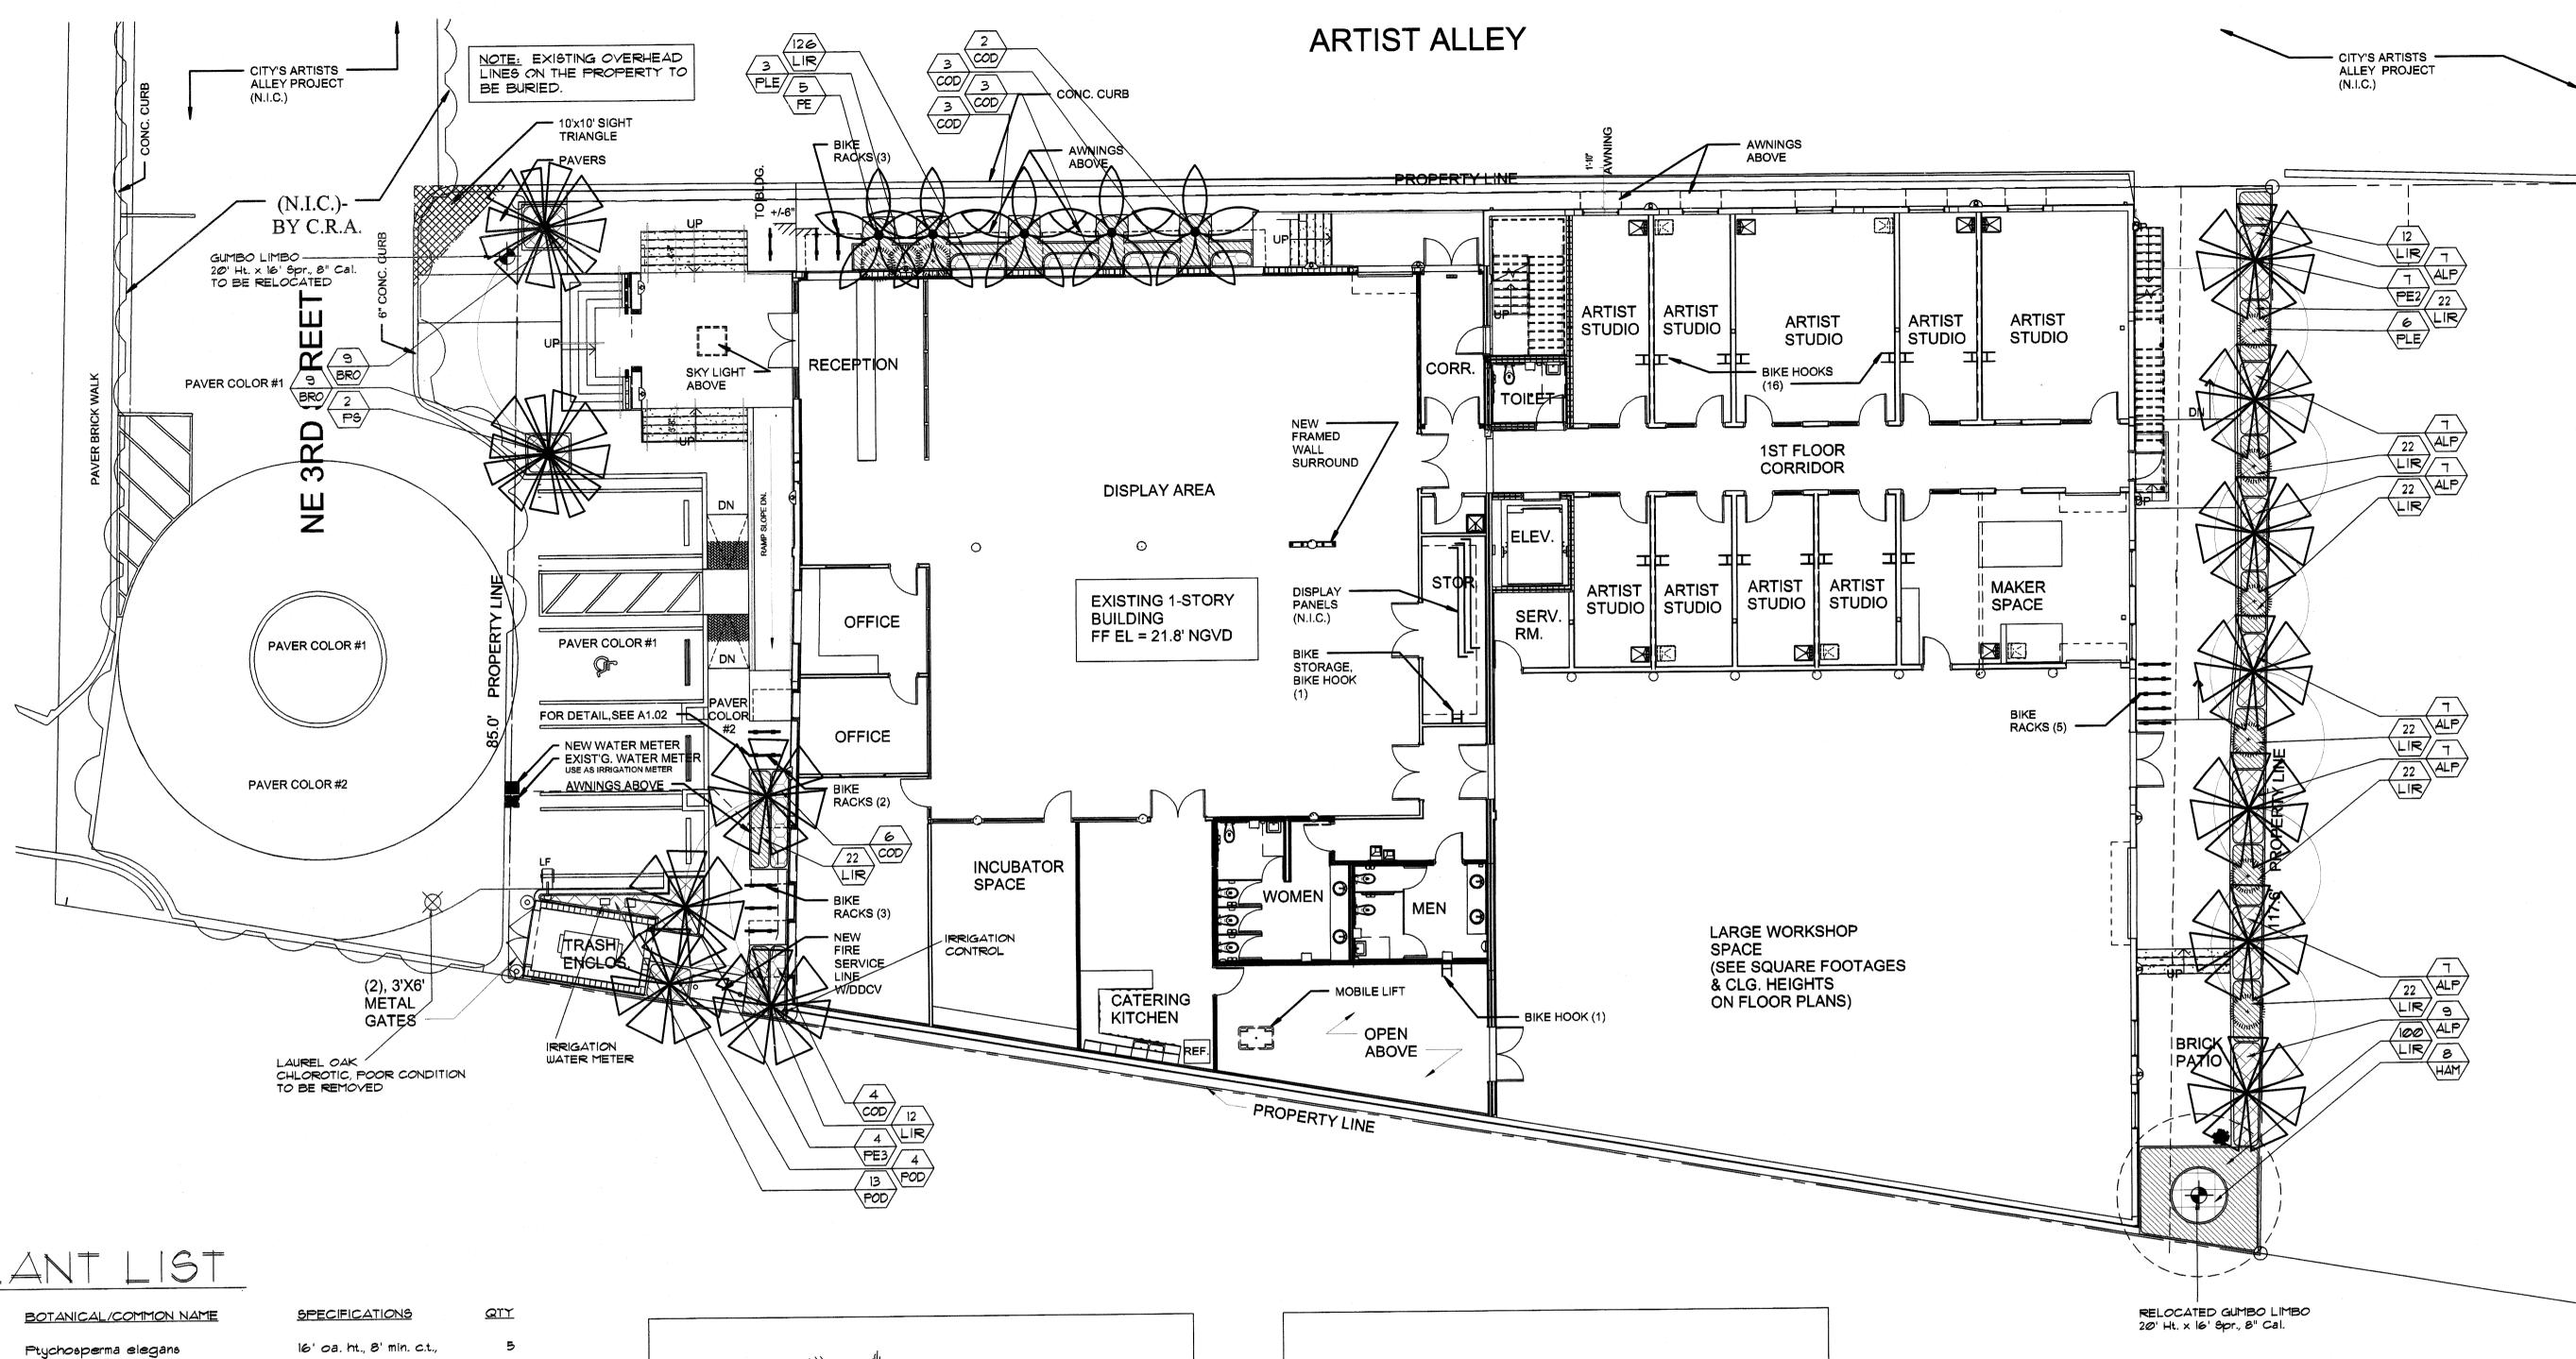
NGINEERS

DRAWN: M.T.J.

CHECKED: J.A.P.


DATE: 6/25/15




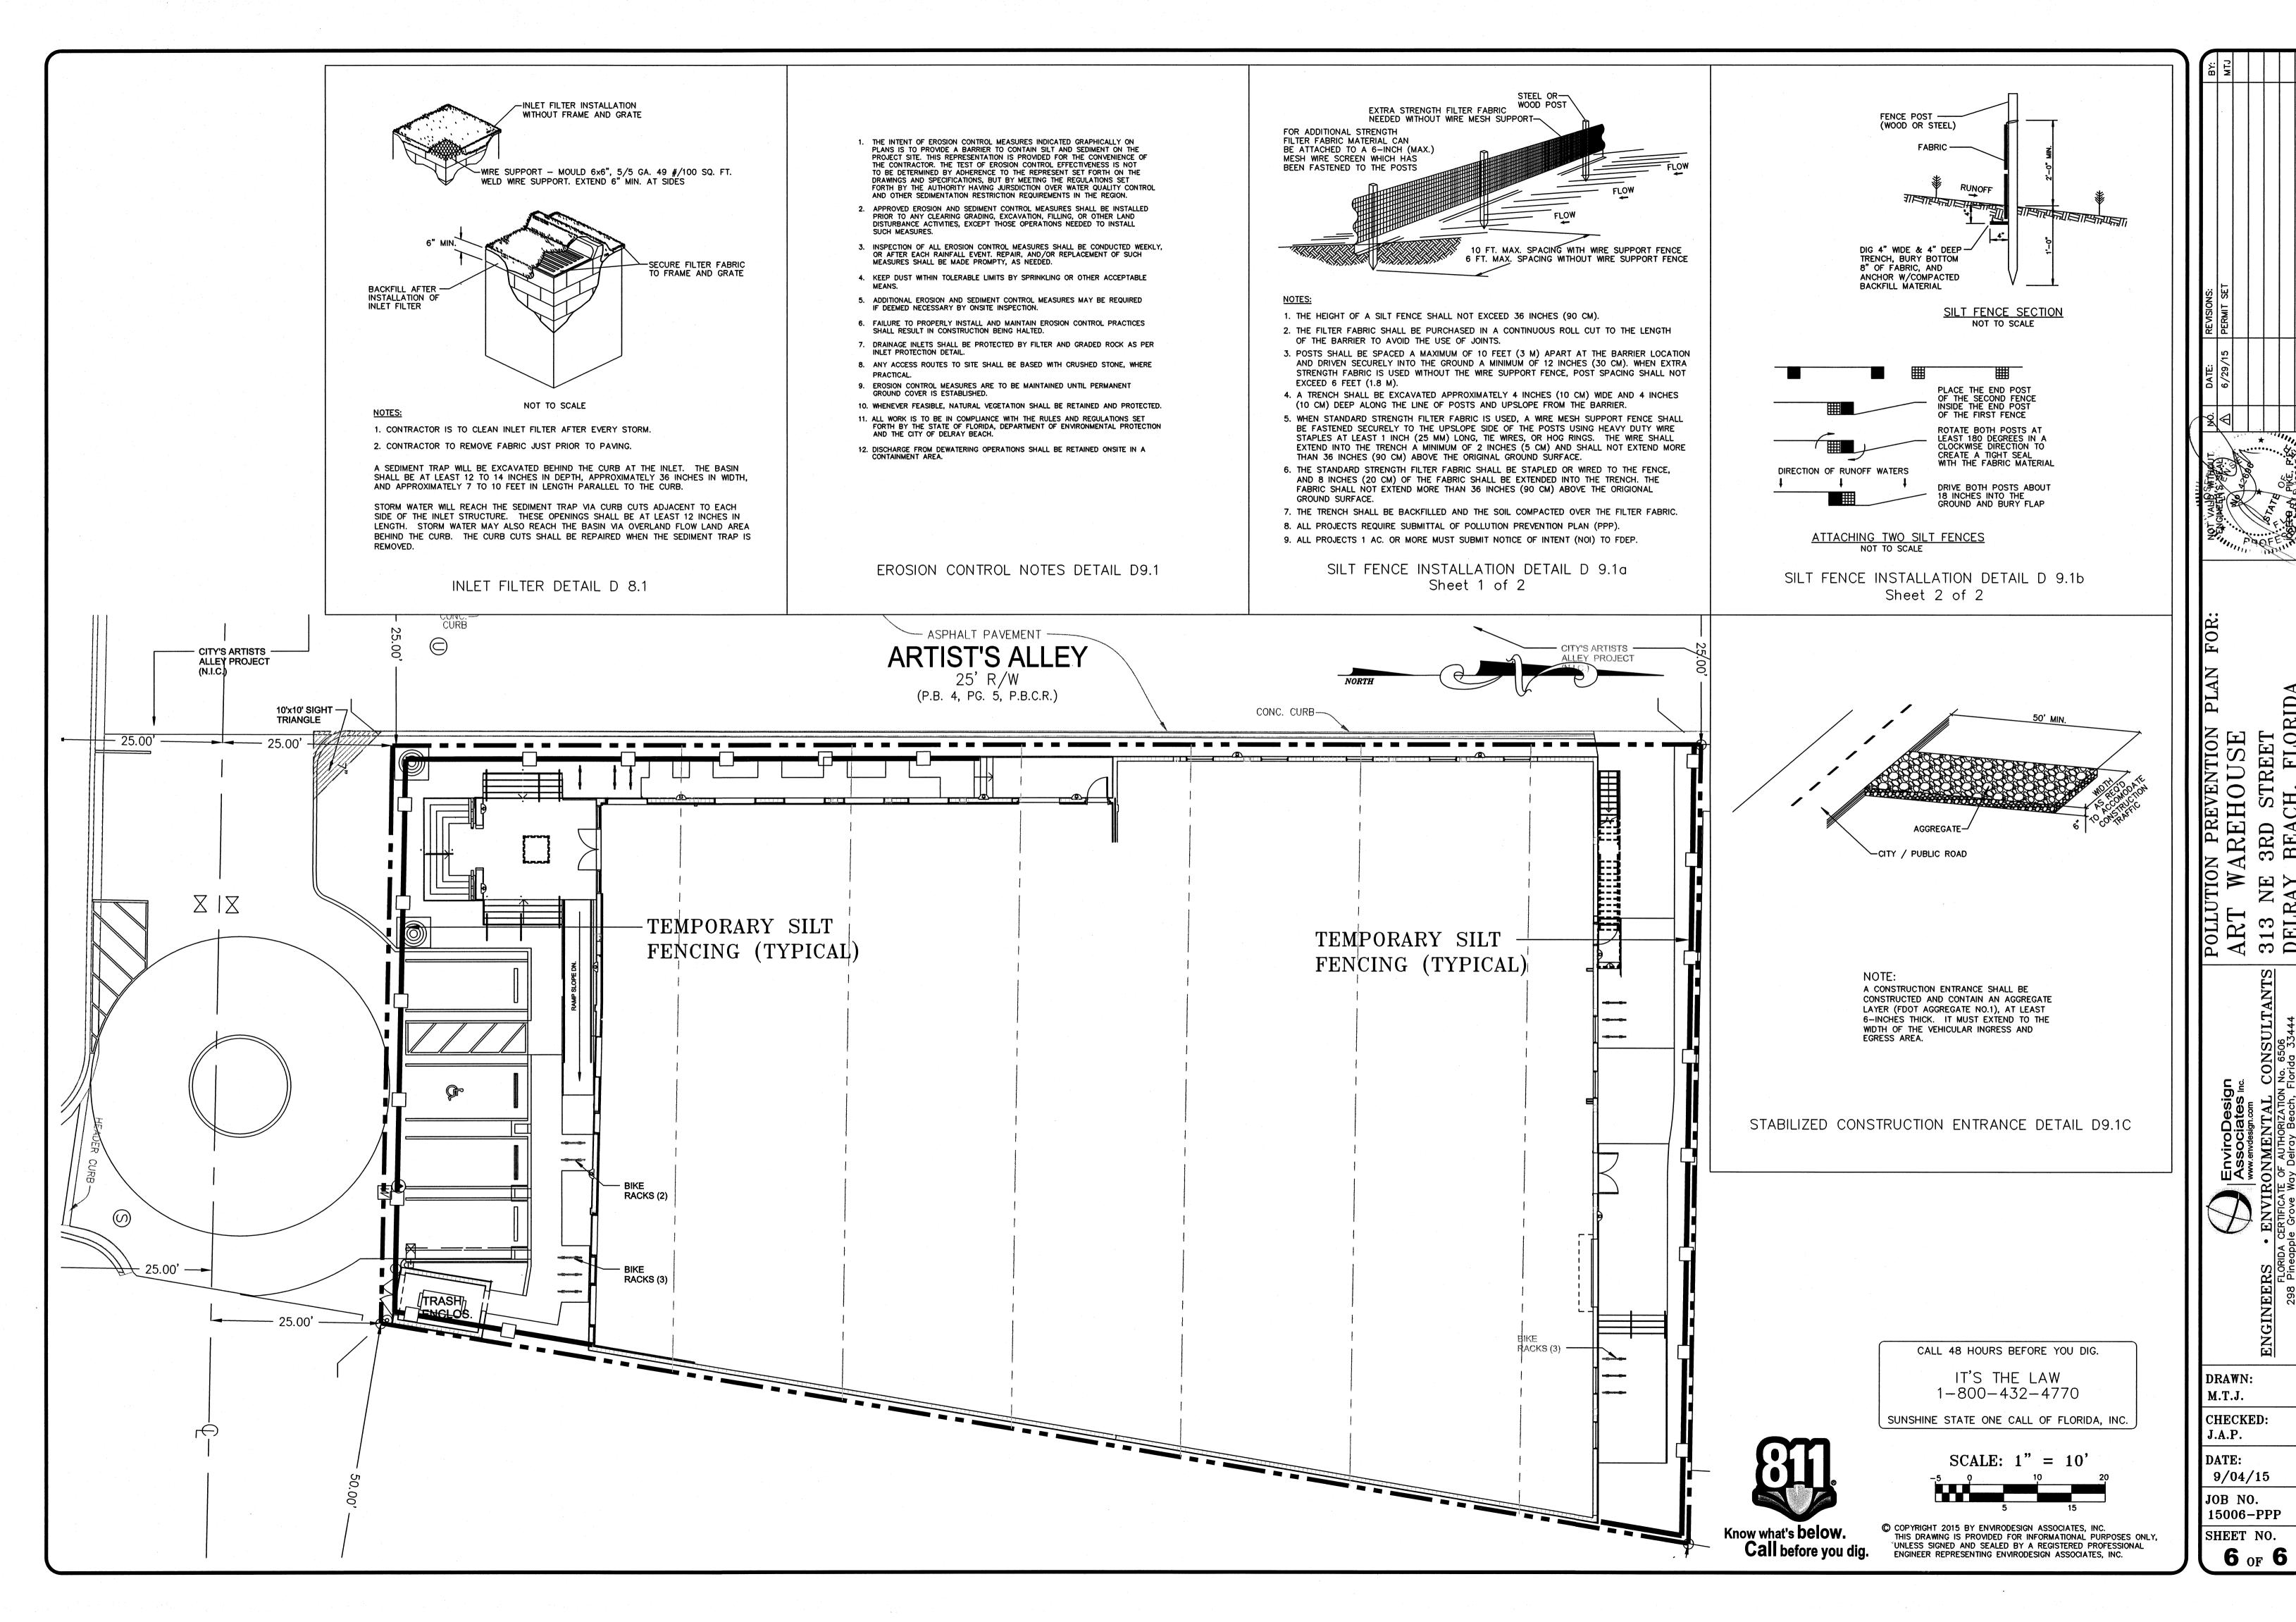


PLANT LIST

SYM	BOTANICAL/COMMON NAME	SPECIFICATIONS	QTY
PE	Ptychosperma elegans Alexander Palm	16' oa. ht., 8' min. c.t.,	5
PE2	Ptychosperma elegans Double Alexander Palm	16' oa. ht., 8' min. c.t., double trunk	ר <b>ד</b> מי
PE3	Ptychosperma elegans Triple Alexander Palm	20' oa. ht., 8' min. c.t., triple trunk	4
<b>P</b> 6	Phoenix sylvestris Silver Date Palm	14' c.t. matched	2
ALP	Alpinia zerumpet 'Variegata' Shell Ginger	24" ht. x 24" spr. 24" o.c.	51
BRO	Bromeliad perfection Perfection Bromeliad	12" ht. x 12" spr. 18" o.c.	18
COD	Codiaeum varigatum Sloppy Painter Crotons	18" ht. x 18" spr., 24" o.c.	21
НДМ	Hamelia patens 'compacta' Dwarf Firebush	24" ht. x 18" epr., 24" o.c.	8
LIR	Liriope evergreen giant Giant Liriope	10" ht. x 10" spr. 12" o.c.	404
PLE	Draceana reflexa Pleomele	4' ht., 3 ppp	9
POD	Podocarpus macrophyllus Podocarpus Hedge	5' ht. x 24" spr., 24" o.c.	IΠ

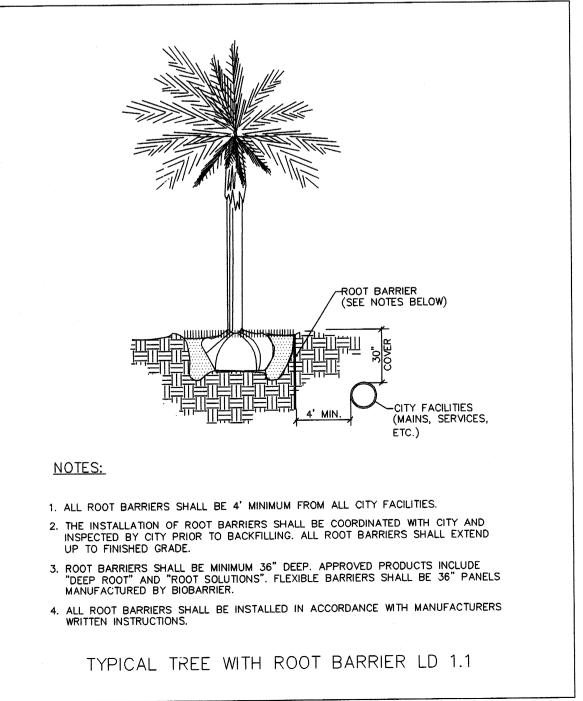

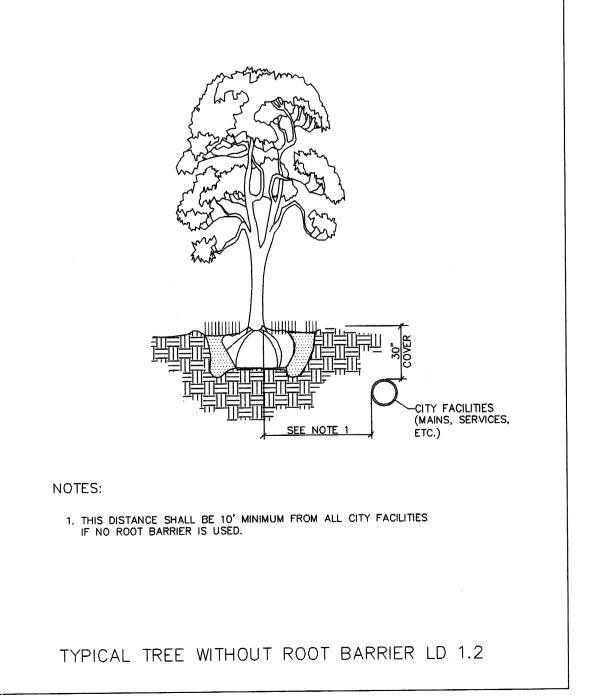

(n) Existing native soil within all landscape islands, interior landscape strips and perimeter landscape strips, adjacent to vehicular use areas, shall be excavated down to a depth of thirty (30) inches below existing grade, except for a 12" buffer from the inside of curb or pavement (see diagram below). A suitable planting soil mixture of fifty/fifty (50/50), sixty/forty (60/40) (sand/topsoil) or as otherwise indicated by the Registered Landscape Architect, shall either be backfilled in place of the native soil or efficiently mixed with the native soil to create an optimum environment for successful root development. If native soil is to be mixed, it shall first be screened to remove rocks and debris larger than one-half (1/2) inch in diameter prior to mixing. All properties under this section shall be required to have an open landscape bed inspection prior to backfilling to insure the thirty (30) inch depth has been met. [Amd. Ord. 6-12 2/21/12]

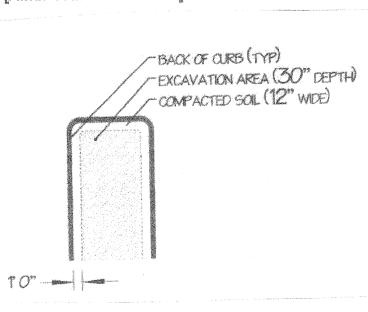

dave bodker landscape architecture/planning inc. 601 n. congress ave., suite 105-a delray beach, florida 33445 561-276-6311

## sheet title: planting plan

#LA0000999

project:

delray beach florida

warehouse

renovation

project number: 7814 03-04-15 1' = 10' drawn by:

revisions: 9-3-15 per comments

sheet:

A. These Specifications and the requirements hereinafter will govern this project during the installation, guarantee and maintenance period.

A. The work specified by this Section of the Specifications and on the Plans consists of furnishing all labor, machinery, tools, apparatus, means of transportation, supplies, equipment, materials, services and incidentals nece complete the work as indicated on the Plans and in the Specifications, as well as all other related

B. The work shall include, but not be limited to, furnishing material, root pruning where required, layout, protection to the public, excavation, installation, backfilling, grading, fertilizing, mulching, staking and guying where required, watering, pruning where required, sod installation, weeding, cleanup, maintenance and guarantee.

responsibilities, including all change and repairs incident

C. Quantities and Location: The Landscape Architect reserves the right to adjust the numbers and locations of the designated tupes and species to be used at any of the locations shown in order to provide for any modifications which might be necessary.

D. Investigation of Subsurface Condition: The Contractor shall be responsible for making site subsurface investigations and with the character of the existing material and the construction conditions under which he or she will work These subsurface investigations and examinations shall be included in the bid. The Contractor shall not receive

E. The Landscape Contractor shall be paid for only those units contractor's unit prices shall be the basis for said payment The final amount of payment may or may not be the total sum of the contract depending on the number of units installed.

F. Ten percent (10%) of the total contract price will be held as retainer for 90 days after final written acceptance.

other trades at the job site.

G. The Landscape Contractor will coordinate his work with all

(2) Paim frond tying shall be as set forth in the latest edition of the Florida Department of Agriculture's "Grades and Standards for Nursery Plants". tying pain shall be at the option of the Contractor. The Landscape Architect may direct the Landscape Contractor to untie Paim fronds to accommodate an owners "grand opening" The Contractor may retie the paim after the event. This untying will not affect the guarantee or represent an additional cost to the owner.

(3) To reduce head volume, Paim fronds may be taper trimmed by not more than one-third

(4) Palms with mechanical damage, such as from cables chains, equipment and nails, shall be rejected.

I. Chlorosis: The allowable level of Chlorosis in foliage shall be set forth in the latest edition of the Florida Department of Agriculture's "Grades and Standards for Nursery Plants". J. Plant material shall not be accepted when the ball of earth

surrounding its roots has been cracked, broken or otherwise K. Root pruning of plant material, when necessary, shall be done a minimum of 4 weeks or for a period as determined by the

A. Sod shall be solid sod and shall be standard quality grade

Note: Quality grade shall be based on the standards of sod quality grades (premium, standard or commercial) as established by the Turi grass Producers Association of Florida inc. The sod shall be well matted with roots and of firm tough texture having a compact top growth and heavy root development. Sod shall be free of objectionable grassy and broad leaf weeds. Sod shall not accepted if it contains Bermuda Grass. Sod sections shall be strong enough to support when suspended vertically from a firm grasp on the upper 10% of the section. Sod shall not be harvested or transplanted when moisture content (excessively dry or wet) may adversely affect its survival. Sod shall be relatively free of thatch up to one half inch allowable (uncompressed).

the soil embedded in the soci shall be a clean, earth, free of stones and debris. The sod shall have been mowed at least three times with a lawn mower with final mowing not more than seven days prior to the sod being cut for placement. The sod shall be provided in commercial pad sizes measuring not less than 12 inches by 24 inches and shall be live, fresh and uninjured at the time of placement. It shall be planted within 48 hours after being cut and shall be shaded and kept

Quality Assurance:

A. The Landscape Architect may inspect trees, shrubs, and groundcover either at the place of growth or at the site before planting for compliance with the requirements for name, variety, size, and quality. The Landscape Architect retains the right to further inspect trees and shrubs for size and condition of balls and root sustem, insects, injuries, and latent defects, and try to reject unsatisfactory or defective material at any time during the progress of work The Landscape Contractor shall remove rejected trees or shrubs within I days from the project site.

B. Responsibility for Assuring Quality Work:

(1) The Contractor's Superintendent shall speak English and be well versed in Florida plant material, planting operations, Plan and Specification interpretat coordination with other contracts or service in the project area and coordination between the nursery and

(2) All employees shall be competent and highly skilled in their particular job in order to properly perform the work assigned to them. The Contractor shall be responsible for maintaining the quality of the material

(3) The Contractor will comply with applicable Federal, State, County and local requirements governing landscape

(1) Plant material shall be Florida #1 or better as set forth in the latest edition of the Florida Department of Agriculture's Grades and Standards for Nursery Plants.

(2) All plant material will be subject to the approval of the Landscape Architect for quality, size and color. Planta lacking the compactness or proper proportions plants which are weak or thin, and plants injured by close planting in nursery rows will not be accepted. Plant materials which have been cut back from large grades to meet certain specification requirements will be

(3) Plant material shall have normal, well developed branches and shall be vigorous plants, free from defects, decay, burns disfiguring roots, sun-scald injuries, abrasion of the bark, plant diseases, insect past aggs, barers, and all forms of infestations or objectionable disfigurements.

A. All plant material, unless indicated otherwise, shall be installed with a planting soil composed of sandy loam (50% sand , and 50% muck) typical of the locality. The soil must be taken from ground that has never been stripped, with a slight acid reaction (5.5 to 6.5 ph) and without an excess of calcium or carbonate. Soil shall be delivered in a loose friable condition.

A. Potable, from municipal water supplies or other sources which are approved by a public health department.

A. Mulch shall be:

(1) "Fioramulch"

4. New and existing Trees and Palms: Fertilize with 8-2-12 palm fertilizer with micronutrients per manufacturer's recommendations.

B. New and existing Shrubs, and Groundcover: Fertilize with 8-2-12 paim fertilizer with micronutrients at a rate of 1/2 lb. per 1000 SF of area.

Annuals: Fertilize with Osmocote - Sierra blend 14-14-14 or approved equal.

D. Composition and Quality: All fertilizer shall be uniform in composition and dry. Granular fertilizer shall be free flowing and delivered in unopened bags. All bags containers or boxes shall be fully labeled with the manufacturer's

E. All fertilizer shall comply with the State of Florida fertilizer laws.

Delivery, Handling and Storage:

(1) Movement of nursery stock shall comply with all Federal, State, and local laws, regulations, ordinances, codes, etc.

(2) Protect during delivery to prevent damage to root ball or desiccation of leaves. Remove unacceptable plant materials immediately from the job site. Maintain and protect while stored at the site.

(3) Transport materials on vehicles large enough to allow plants not to be crowded and damaged. Plats shall be covered to prevent wind damage during transit.

(1) Deliver sod on pallets with root system protected from exposure to wind and sun. Deliver sod in quantities capable of being installed within 48 hours of cutting.

A. Written request for approval to substitute a plant species or

a plants designation (B4B, WB4B, CG etc.), type, grade, quality, size, quantity, etc. due to the non-availability of the material specified. Approval must be given by the and scape Architect before the material is delivered and installed on the project. The Contractor must provide written proof that the specified plant material is

B. Any request for the approval of an equal shall be in writing. proval shall be given by the Landscape Architect before the material is delivered and installed on the project. C. Submit three prints of shop drawings for any special

conditions not covered in the details indicated. This shall

be for approval by the Landscape Architect before they are implemented in the project. D. If requested by the Owner or Landscape Architect submit a schedule of all specimen plant material and collected plant material indicating the sources or suppliers of these materials and their locations for approval by the Landscape Architect before they are delivered and installed on the project. Also, two color photographs of each different item

submitted, if reduested.

E. If requested by the Owner or Landscape Architect, submit a letter indicating the sources or suppliers of all sod and the grade to be supplied for approval by the Landacape Architect before it is delivered and installed on the project.

A. Staking and guying shall be the responsibility of the Landscape Contractors. Staking and guying shall not be attached directly to the plant material with nails. Also,

guying other than those indicated in the details, shall

requirement of staking or guying.

EXECUTION

Inspection

jurisdiction the project is located in.

A. Utilities (Above Ground and Underground):

have been indicated on the Plane.

battens used in staking and guying shall not be attached to the plant material with nails. Any method of staking and

installation. Under no circumstances will approval be given

B. The Contractor is responsible for performing all staking and

C. The decision of whether to stake or guy shall be left to the

according to local regulations, ordinances and code

discretion of the Contractor, provided it is not required

or guy shall not relieve he or she of the responsibility of

material dies as a result of blowing, falling or leaning over.

setting plant material if it blows, falls or leans over.

Also it will not relieve he or she of the duarantee if the

(1) The work area may have existing utilities, such as, bu

not limited to, irrigation, phone, electrical and storm sewer. The location of some of these existing utilities

requirements. However, a Contractors decision not to stake

receive approval from the Landscape Architect prior to their

to allow the plunging, burying, or planting of trees or palms so that the top of the grade, in order to eliminate the need or

guying in accordance with all applicable regulations, ordinances and code requirements from the appropriate local

showing different side views of the item shall be submitted

with the schedule. Additional color photographs shall be

F. If requested by the Owner or Landscape Architect, submit a sample and analysis of all planting soil types for approval

by the Landscape Architect before the material is delivered and installed on the project. sample and analysis of the mulch for approval by the Landscape if requested by the Owner or Landscape Architect, submit a

Architect before the material is delivered and installed on

guying methods to be used if the ones indicated in these specifications and on the Electrications are the Electrications and the Electrications and the Electrications are the Electr Submit three prints of shop drawing for all staking and cifications and on the Plans are not to be implemented staking and guying methods before they are implemented in the The Landscape Architect will approve all shop drawings of

 Submit in writing any hindrance to the owners routine maintenance or lack of, that may affect installed plant materials growth, or survival, that would affect the

quarantee of plant material.

K. Submit in writing any hindrance to the timely completion of

Submit and Certificate of inspection of plant material as may be required by, State, local or Federal Authorities.

A. When the specifies plant designation (B4B, WB4B, CG etc.), type, grade, quality, size, quantity, etc. of a material is not available, the Contractor shall submit a written request, to the Landscape Architect, for a substitution along will written, documented proof that the plant designation (B4B WB4B, CG, etc.), type grade, quality, size, quantity, etc. of material is not available. The Landscape Arc shall approve all substitutions before they are delivered and installed. Do not deliver and install any material, which is anticipated to be a substitute, before it has been submitted in writing and approved as a substitute by the Landscape because of an approved substitute, shall be established in writing between the Owner and the Contractor before the material substitute is delivered and installed on the

However, no guarantee is implied that the Plans are

utilities, structures, etc., by hand excavation or other

could result in damage or injury to persons, utilities,

structures or property. The Contractor shall make a

thorough search of the site for utilities, structures,

etc., before work is commenced in any particular

(2) The Contractor shall take immediate steps to repair,

replace, or restore all services to any utilities or

other facilities which are disrupted due to his or he

additional outside services which may be necessary t

basis until services are restored. He or she shall also

costs involved in the repairs and restoring disrupted

service resulting from negligence on the part of the Contractor shall be nome by the Contractor and he or

she shall be fully responsible for any and all claims

(3) Should utilities, structures, etc., be encountered which

interfere with the work, the Landscape Architect shall

obstruction, if the obstruction cannot be relocated.

obtaining the written permission of the Landscape

Architect. Requests for disconnection must be in

A. Its shall be the responsibility of the Contractor to provide

with relation to walks, paving, drain structures and other site conditions, unless indicated otherwise on the plans.

pavement areas, such as, but not limited to, curbs, roads,

drives, walks, terraces, decks and slabs shall be set so that

the TOP OF THE MULCH IS I INCH BELOW THE TOP OF THE

PAVEMENT AREA or as indicated otherwise on the plans

B. Plant Area Next to Pavement: All planting areas next to

A. Staking Plant Locations: Stake or mark plant material

locations prior to plant hole excavation, based on

(6) Edge and weed all shrubs, groundcover and flower beds

(4) The Contractor shall not purposefully disrupt or

hade on the relocation of the work so it will clear the

disconnect any type of utility whatsoever without first

writing and received by the Landscape Architect at least

72 hours prior to the time of the requested interruption.

the final grading so the final level for planting areas conforms to surrounding grades and is at the proper elevation

provide and operate any supplemental temporary services

prosecute repairs on a continuous "around the clo

to maintain uninterrupted use of the facilities. All

the Contractor to verify the location of all such

accurate or complete. It shall be the responsibility of

A. The guarantee shall not begin until the day final written acceptance is given.

B. All plant material, except sod, trees and paims, shall be quaranteed for a minimum of I year from the time of final cceptance. All sod shall be guaranteed for a minimum of 60 days from the time of final acceptance. All trees and palms are to be guaranteed for one year from the time of final

C. The guarantee shall be null and void for plant material which is damaged or dies as a result of "Acts of God" limited to hall, freeze, lightning, and winds which exceed hurricane force, providing the plant was in a healthy growing condition orior to these "Acts of God".

end of the guarantee period, but prior to the last day of the guarantes period.

A. The guaranteeing of a plant material shall be construes to mean the complete and immediate replacement of plant material within 3 calendar days if it is: (1) Not in a healthy growing condition and thus renders it below the minimum quality indicted in the

D. At the option of the Owner, and inspections may be made at the

(2) There is a question to its ability to survive after the end of the guarantee period that would render it below the minimum quality indicated in the Specifications.

B. The 3 calendar days may be extended due to seasonal conditions, availability, preparation time such as root pruning, etc., only if approved by the Landscape Architect in advance. The extended time shall be negotiated between all

parties concerned, but must receive final approval by the

C. Size, Quality, and Grade:

(1) Replacement plant material shall be one of the same species quality and grade as that of the plant to be replaced. The size of the replacement shall not necessarily be the same size as the original specified plant at its initial planting. The replacement shall be of equal size to the plant to be replaced at the time it has been determined that it must be replaced.

B. Spacing of Groundcover & Shrubs: The location of a

C. The rootballs of B4B plants which cannot be planted

D. Subsurface Conditions: Some or all work areas may be

The Contractor shall be responsible for insuring ade

drainage in these areas and shall remove this existing

be maintained as necessary until planting

planting bed (shrub or groundcover) next to another bed

walkway, structure, etc., shall have the plants along the

perimeter spaced so that the plants can mature properly

immediately shall be covered with moiet soil or mulch to

insure protection from drying winds and sun. All plants shall

compacted and/or contain existing material such as limerock

proper plant survival and growth and therefore removal of

which may interfere with adequate vertical drainage and/o

this material is part of the scope of work for the project

material, as required, by such means as auguring, drilling or rototilling. If necessary, excavate to a depth beyond the

required excavation depth for the plant hole, in order to

insure proper vertical drainage necessary for plant survival

E. Remove undesirable existing vegetation present on the project by use of chemicals and/or mechanical means which are

acceptable to the Landscape Architect. Apply chemicals as

misuse of the chemicals which will cause detrimental residual

which have been established are not altered.

a. Excavation of plant holes shall be roughly

cylindrical in shape with the sides approximately

and the location of the plant in the hole to

compensate for unanticipated structures or

b. The excavated material from the plant holes shall

not be used to backfill around the plant material.

Such material shall be disposed of either on the

project site or off the site, as directed by the

A. General: The Contractor shall lay out on the ground the

locations for the plants and outlines of areas to be planted

and obtain approval of the Landscape Architect before

the location of specifies plant materials prior to planting.

excavation is begun. The Landscape Architect may adjust

unanticipated factors which are a conflict

vertical. The Landscape Architect reserves the

right to adjust the size and shape of the plant hole

F. Excavation of Plant Holes:

Landscape Architect

Groundcovers

(1) General:

conditions. Care shall also be used so that any final grades

ded by the manufacturer. Exercise care to avoid ar

without growing into the other bed, walkway, structure, etc.

B. Setting of Plants:

(i) All plants shall be set at the proper level so that after settlement, a normal or natural relationship between the crown of the plant and the surrounding ground surface exists. The plants shall be set vertically. After excavation of planting pits and prior to placement of the plant material, fill the planting pits with water. The plant hole shall be backfilled wit lopsoil mixture placed in layers around the roots or ball. Each layer shall be carefully tapped in place When partially backfilled and compacted, the hole shall be filled with water and the soil allowed to settle around the roots: the ball ties shall be cut and at the ourlab beel down 1/3 from the top of the rootball and cut or adjusted to prevent the formation of air pockets before applying the water. After the water has been absorbed the plant hole shall be filled with topsoil mixture as tapped to grade. Subsoil removed from tree pit shall not be mixed or used in any way with the topsoil

However, if for some reason, the plant to be replaced is

replacement shall be at least equal to the originally

(2) Replacements shall be guaranteed for a period equal to the originally specifies guarantee. This guarantee period shall begin at time of acceptable replacement.

(3) Final payment to the Contractor shall not relieve he or

A. On the Plans, figured dimensions shall govern over scaled

dimensions. If any error or discrepancy is found in the Plans and Specifications, the Contractor shall refer the same

in resolving conflicts between the Plans and Specifications, THE PLANS SHALL GOVERN over the Specifications. The

apparent errors or omissions in the Plans and Specifications

and to make such interpretations as he or she may deem

A. The Contractor shall procure all necessary permits to

B. The Contractor is responsible for performing all work in

and/or Federal jurisdiction the project is located in.

A. The Contractor shall not start on any changes or additional

4. The words "job site", "project site", "job", "project" and

"site" shall be synonymous with one another when used in

4. In performing the scope of work, all safety on of off the job

site shall be the sole responsibility of the Contractor. The Landscape Architect shall not be responsible for safety on or

work in the project until a written agreement setting forth

the adjusted contract amount has been executed by the Owner

and the Contractor. Any work performed on any changes or

additional work prior to the execution of a written agreement

accordance with all applicable regulations, ordinances and

code requirements from the appropriate city, county, state

ecessary for the proper fulfillment of the Intent of the

o the Landscape Architect for an interpretation and decision.

smaller than the size originally specifies, the

she of the guarantee obligations.

Plane and Specifications.

accomplish all of the work

Changes and Additional Work:

"Job Site, "Project Site Etc.":

Safety On and Off the Job Site:

may or may not be compensated for.

(2) All sabal and queen paims shall be backfilled with clean thoroughly washed in during the planting operation.

(3) Water Saucer: A 4-inch high water saucer shall be formed around the rim of each individual tree or paim pit and maintained in place.

(4) Plant material of the shrub category and smaller must be handled by the ball only. Plant material too large for hand handling, if moved by winch or crane, must be thoroughly protected from chain, rope, or cable marks Girdling, bark elippage, limb breakage and any other damage that might occur by improper handling or

(5) All trees and palms shall be handled by both the trunk


and rootball at the same time and not by the trunk only. Trunks shall be thoroughly protected. (6) Container grown plant material shall be carefully removed from the container so as not to disturb the


root system. (1) Soil Preparation: Within 24 hours prior to placing sod,

prepare the soil in the following manner:


a. Uniformly apply formula 8-8-8 fertilizer over the area at a rate of 25 pounds per 1,000 square feet. b. Remove stones and foreign matter over two inches in

diameter from the top two inches of soil. c. Grade the sod areas so that the top of the sod will be at finished grade after rolling and tamping.

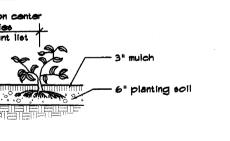

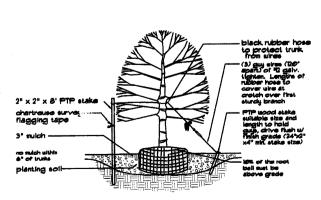

Shrubs

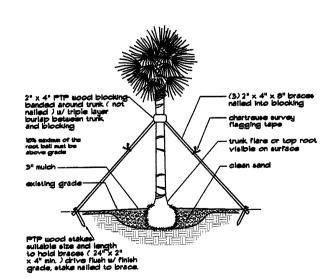

Straight Trunk Palms

The Landscape Architect's on site observations or inspections shall be only for the purpose of verifying that the Plans and Specifications are being implemented properly. The Landscape Architect's on site observations or inspections are not for eafety on or off the job site.

On Site Observations and inspections

A. The Contractor shall make requests for on site observations or inspections 48 hours in advance and they shall be in writing, if directed by the Landscape Architect.

B. If an inspection is related to completion and final

acceptance, the request shall be made in writing 48 hours in C. An inspections at the growing site does not preclude the right of rejection at the project site.

D. The fact that the Landscape Architect has not made an early on site observation or inspections to discover faulty work or work omitted, or work performed which is not in accordance with the contract requirements, shall not bar the Landscape Architect from subsequently rejecting such work at a later

shall be only for the purpose of verifying that the Plans and Specifications are being implemented properly. The Landscape Architect's on site observations or inspections are nor intended to take charge, direct, run or manage the implementation o the Plans and Specifications or take charge, organize or manage the Contractor while performing the scope of work indicated in these Specifications.

E. The Landscape Architect's on site observations or inspection

Plant Material

A. Plant material shall be nursery grown except:

(2) Where approved by the Landscape Architect for such plant material which is only available as a collected item

B. Except where another grade is specifically called for in the Plans, all plant material, including collected material if specified, shall be no less than Florida 4, or better, at the time of installation and final acceptance. Existing plant material to remain or to be relocated shall be excluded from this requirement.

C. Habit of Growth: All plant material shall have a habit of growth that is normal for that species and shall be sound, healthy, vigorous and free from insects, plant diseases and

a. Place sod with staggered joints closely butted, tamped or rolled to an even surface to the required finished grade. Avoid continuous seams along lines of water flow in swales. Place sod in rows at right angles to slope.

b. Water sod every day for a period of three weeks. c. Fertilize sod three weeks after planting with 12 pounds of 8-8-8 formula fertilizer per 1,000 square feet of laun.

d. No sod shall be used which is not certified as being free of the imported fire ant. Before any sod is brought to the site, furnish a written certification of clearance from pest control officials of either State or Federal Department of Agriculture.

a. It shall be the responsibility of the Contractor to replace any areas of soci that are not in healthy

b. The Contractor shall completely maintain the sod until final acceptance by mowing or epraying as

D. Planting Beds:

(1) Spread six inches of topsoil mixture uniformly over the entire planting area. (2) Spread 50% organic fertilizer at a rate of 4 pounds per 1000 square feet uniformly over the groundcover area.

(3) Rotor mix, or by other approved method, to a depth of (4) Fine grade to remove all trash, rocks, and debris to

depth indicated. (5) Regrade to finish grade before adding two inches mulch. (6) Thoroughly water and firm the plants into the soil mixture.

(1) Areas to be mulched shall have existing weeds and vegetation removed, including root systems, before

(2) Grades are to be uniform. Grade areas which are rough and uneven. Fill in voids and holes with planting soil or other approved fill material.

D. Measurement of Trees, Palms, Shrubs, and Groundcover: (1) Trees, Shrubs, and Groundcove

a. Rootball: Requirements for the measurement of minimum rootball diameter and depth shall comply with the Florida Department of Agriculture's "Grades and Standards for Nursery Plants, Part I and Part

CALIPER MIN. BALL DIA. MIN. BALL DEPTH 35 - 4" 60% of dia. 60% of dia. 5.5" or more increase in up to 48", proportion then decrease in proportion for larger size diameter.

 b. Height: The height of plant material shall be measured from finish grade and continue up to where the main mass of the plant uniformly ends. The height shall not include any singular or isolated parts of the plant, such as leaves, shoots oranches, limbs or fronds, which extend out beyond the main mass of the plant E. Die-Back and Leaf Drop: plant material showing signs of die-

back of leaf-drop will not be accepted and must be removed from the project immediately if so directed by the Landscape Architect. Therefore, any plant material with tendencies toward leaf-drop or die-back must be root pruned early enough F. Mechanical Destruction of Foliage: Mechanical destruction of

foliage resulting from root pruning shall not effect more than 10% of the total foliage prior to planting on the project. Loss of foliage caused by seasonal change will be

. Spanish Moss: If Spanish Moss (Tillandsia usneoides) exists on plant material, it shall be completely removed prior to planting on the project

(1) Remove a minimum of fronds from the crown of the palme to facilitate transporting and handling.

(3) The mulch shall be uniformly applied to a depth of approximately 2 inches, or other depth as indicated otherwise, over all strub and groundcover areas, around trees and palms in sod areas and any other areas as ndicated on the plans.

(1) Initially, water the plant material to develop uniform coverage and deep water penetration to the full depth of the root zone. Avoid erosion, puddling, and washing

(2) Provide continuous watering of plant material after planting in order to achieve optimum growth conditions to establish plants. Water shall be applied as necessary and the amount of water and frequency watering shall be based on the specific needs of each plant type, the time of year, amount of rainfall and other environmental conditions it is exposed to. This watering shall begin after the plant is planted and continue until final acceptance. All trees and palms shall be watered, only during this period. Do not rely on the irrigation system, if there is one, to achieve this task it cannot deliver the volume of water required, without flooding areas beyond where water is eded and/or over watering other landscape material. shrubs, groundcover and sod may be watered by using the irrigation sustem, if there is one hand we during this period.

(3) If there is no source for water available at the project, such as a hose bib (s) or fire hydrant (s) if approved for use, then the Contractor shall be onsible for supplying water for watering, by such means as a water truck or tank

G. Pruning and Thinning:

(1) The amount of general pruning and thinning shall be limited to the minimum necessary to remove dead or injured twigs and branches and to compensate for the loss of roots as a result of transplanting operations Pruning and thinning shall be done in such a manner as not to change the natural habit or shape of a plant.

(2) The Landscape Architect shall be contacted prior to

performing any major pruning and thinning. The Landscape Architect may elect to be present during any pruning and thinning.

(1) In the event that weeds or other undesirable vegetation becomes prevalent to such an extent that they threaten plant material, they shall be removed as directed by the Landscape Architect. This condition shall apply until final acceptance.

I. ALL PLANTS TO BE FLORIDA NO. 1 OR BETTER 2. NO SUBSTITUTIONS WILL BE ACCEPTED WITHOUT PRIOR WRITTEN APPROVAL BY THE LANDSCAPE ARCHITECT.

RAIN SENSOR

CONTRACTOR IS RESPONSIBLE FOR LOCATING ALL UNDERGROUND UTILITITES TO AVOID DAMAGE.

6. CONTRACTOR IS RESPONSIBLE FOR PURNISHING ALL MATERIALS, TOOLS, EQUIPMENT, LABOR, AND PLANTS NECESSARY FOR THE PROPER PLANTING OF ALL TREES, SHRUBS GROUNDCOVERS, AND GRASS AS SHOWN ON LANDSCAPE ARCHITECT'S PLANTING PLANS.

8. ALL TREES AND PALMS TO BE STAKED AND GUYED.

9. ALL PLANTED AREAS ARE TO BE MULCHED WITH "FLORAMULCH", TO A DEPTH OF 3".

12. THE CONTRACTOR SHALL LAY OUT ON THE GROUND THE LOCATIONS FOR THE PLANTS AND OUTLINES OF AREAS TO BE PLANTED. THE CONTRACTOR SHALL OBTAIN APPROVAL FROM THE LANDSCAPE ARCHITECT BEFORE EXCAVATION BEGINS. THE LANDSCAPE ARCHITECT MAY ADJUST THE LOCATION OF SPECIFIED PLANT MATERIALS PRIOR TO PLANTING. 3. TREES AND PALMS TO BE GUARANTEED FOR ONE (1) YEAR, SHRUBS AND GROUNDCOVERS TO BE GUARANTEED FOR NINETY (90) DAYS AFTER FINAL WRITTEN ACCEPTANCE IS GIVEN BY OWNER OR LANDSCAPE CONTRACTOR IS RESPONSIBLE FOR PLANT MAINTENANCE UNTIL THE TIME OF WRITTEN ACCEPTANCE.

LANDSCAPING IN SAFE DISTANCE TRIANGLES SHALL BE MAINTANED TO IDE UNOBSTRUCTED VISIBILITY AT A LEVEL BETWEEN 2' AND 8'

IB. ALL PROHIBITED PLANT SPECIES (AS IDENTIFIED BY THE CITY, COUNTY, STATE) SHALL BE ERADICATED FROM THE SITE. THIS INCLUDES BUT IS NOT LIMITED TO MELALEUCA, BRAZILIAN PEPPER ALL EXISTING AND NEWLY CREATED PLANTING BEDS TO SE CLEANED

AND FREE OF WEEDS AND DEBRIS AND EXCAVATED AS REQUIRED TO PULFILL PLANTING SOIL REQUIREMENTS OF THE PLANTING DETAILS. IB FILL HOLES WHERE EXISTING TREES OR PLANT MATERIAL HAVE BEEN

SOD OVER IF NEW PLANT BEDS ARE NOT TO BE INSTALLED. 19. ALL PLANTING BEDS THAT ARE ADJACENT TO PAVING ARE TO BE LOUER THAN THE ADJACENT PAVING, SO THAT RUNOTF (MULCH, SOIL) FROM THE BED DOES NOT RUN ONTO THE ADJACENT PAVING.

REMOVED TO PROVIDE LEVEL SURFACE WITH SURROUNDING AREA AND

20. ALL EXISTING SOIL WITHIN LANDSCAPE AREAS ADJACENT TO YEHICULAR USE AREAS IS REQUIRED TO BE REMOVED (TO 30" BELOW GRADE.)
INSPECTED AND THEN REPLACED WITH A SIXTY TO FORTY (60/40) MIX OF SAND TO TOPSOIL, NATIVE SOIL THAT HAS BEEN SCREENED OF ROCK OR ANOTHER MIXTURE SUGGESTED BY LANDSCAPE ARCHITECT.

<u>planting soil mix</u> mix back fil -6" curb \_\_\_ asphalt

Florida

Art Warehouse

Renovation

Delray Beach

project:

dave bodker landscape architecture/planning inc.

601 n. congress ave., suite 105-a

delray beach. florida 33445 561-276-6311 #LA0000999

sheet title:

specifications details, notes

project number: 7814 date: 03-04-15 scale: n.t.s. drawn by:

revisions:

^ ^

PLANTING CURB SECTION THRU - DETAIL (A)

(4) A mixture of good organic fertilizer and planting soil (5) Plant material which is in soil of a loose texture which does not readily adhere to the root system, especially in the case of large plants or trees, shall

have the rootball wrapped in burlap and then wire, if

(3) Root pruning shall be accomplished by digging a trench completely around the plant about 18 inches deep. All

ed roots shall be cut off smoothly.

MIN. BALL DIA.

Increase in

proportion

1 - 15"

1.5 - 1.75" 1.75 - 2"

3.5 - 4" 4 - 4.5"

5 - 55"

55" or more

directed by the Landscape Architect. For wire, hod wire shall be used and it shall be blaced around the rootball before before the plant is removed from the hole for relocation. The wire shall be looped and tensioned until the buriapped ball is substantially packaged by the tightened wire netting formed by the hog wire, so as to prevent disturbance of the loose soil around the roots during handling.

I. Removal of Plant Material: A. Disposal of Trash: All debrie and other objectionable (1) All plant material to be removed shall be removed material created through planting operation and landscape completely, including the rootball, from the job or as directed by the Landscape Architect. The remaining construction shall be removed completely on a daily basis hole shall be filled with suitable material or planting so ron the job or as directed by the Landscape Architect. Any as directed by the Landscape Architect. paved areas including curbs and sidewalks which have been streum with soil sod waste, fertilizer or other debris shall

MIN. BALL DEPTH

75% of dia

65% of dia

65% of dia

65% of dia

60% of dia.

60% of dia

60% of dia.

size diameter.

proportion for large

up to 48", then decrease in

65% of dia.

J. Existing Plant Material to be Relocated: be thoroughly swept. B. Excess Fill: All excess fill which results from the (1) All existing plant material to be relocated shall be root pruned a minimum of 4 weeks or for a period as inetallation of the project shall remain the property of the Owner and remain on the project at the option of the Owner. determined by the Landscape Architect prior to All excess fill which the Owner does not want shall be removed and disposed of from the project at no additional (2) Rootball: Requirements for the measurement of minimum cost. No excess fill shall be removed or disposed of from the site until approved by the Owner or Landscape Architect. rootball diameter and depth shall comply with requirements as set forth in the latest edition of Excess fill shall be disposed of as directed. the Florida Department of Agriculture's "Grades and Standards for Nursery Plants, Part I and Part 2", as

A. Responsibility for Protection and Restoration of Property The Contractor shall be responsible for all damage or injury B. Protection Against Mechanical Damage: The Contractor's responsibility for protection against mechanical damage shall include providing protection from vehicles and providing warning signs and barricades as might be necessary and he or

she shall repair, restore and replace all property which

becomes damaged as a result of any negligence of the Contractor or his or her employees in complying with these

on this final inspection.

Completion and Final Acceptance notified in writing of final acceptance as of the date of the final inspection.

Upon written notice from the Contractor of the presumptive completion as defined below, of the entire project, the Landscape Architect, along with other appropriate parties will make an inspection within 48 hours after the written notice. If all construction provided for and compensated the contract is found to be completed in accordance with the contract Plans and Specifications, such inspection shall constitute the final inspection. The Contractor shall be

B. if, however, the inspection mentioned in paragraph A, above, discloses any work, in whole or in part, as being unsatisfactory, final acceptance shall not be given and the (4) All plant material shall be weeded once a week. In the event that weeds or other undestrable vegetation becomes Owner and/or Landacape Architect will give the Contractor the prevalent to such as extent that they threaten plant necessary instructions or "punch lists". Upon correction material, the weeds shall be removed as directed bu the of work, another inspection will be made which shall Landscape Architect. If necessary, the plant material, constitute the final inspection, provided the work has been mulch, sand and/or planting soil shall be replaced as satisfactorily completed. In such event, the Owner or their needed to eliminate weeds or undesirable vegetation at representative shall make the final acceptance and notify the the expense of the Contractor. Contractor in writing of this final acceptance as of the sate

growth of the plants.

C. Completion of the work shall mean the full and exact compliance and conformity with the provisions expressed or implied in the Plans and Specifications including any and all "bunch lists" which may be issued outlining certain items of work which were found unsatisfactory or required completion or

Final acceptance shall not be given until all construction provided for and contemplated by the contract is inspected found to be completed in accordance with contract Plans

writing by the Owner or their representative.

C. Maintenance Prior to Final Acceptance:

The guarantee shall not begin until the day final acceptance ertain responsibilities prior to Final Acceptance: The following is a partial list of certain responsibilities. It is not a

complete list, but only a summary of certain responsibilities. A. The Contractor is responsible for the entire project prior to written acceptance. B. The Contractor is responsible for safety on and off the job

(1) Maintenance shall begin immediately after each plant is planted and continue until final acceptance. (2) Plant maintenance shall include watering, mowing edging, pruning, weeding, cultivating, repair of erosion, mulching, tightening and repairing of guys, stakes, braces, etc., replacement of sick or dead plants, replacement of sod areas which do not become established, resetting plants to proper grades or upright position, maintenance of the watering saucer,

(3) immediately after planting, each plant shall be watered and the watering period shall continue until final acceptance. Refer to the heading "Watering", which is in Part 3 of these Specifications, for additional

litter removal, and all other care needed for proper

(7) Remove all litter once a week

(8) Spraying and Dusting: Contractor shall do all seasonal spraying and/or dusting of all planting, as needed, for complete control of pests and diseases. The materials and methods shall be in accordance with the highest standard horticultural practices and as recommended by the County Agent, and approved by the Landscape Final acceptance shall not be official until acknowledged in Architect, prior to implementation

information from the plans.

(5) Edge and mow sod once a week

once a week

dressed, all areas and parts of area which fail to show uniform growth and health, shall be resodded, repeatedly if necessary, until all sodded areas are covered with a satisfactory lawn. Damage resulting from erosion, guilles, washouts, or other causes shall be repaired by filling with topsoil, tamping, refertilizing, and resolding by the Contractor at his or her expense (10) Protection: Plant material shall be protected against trespassing and damage. If any plants become damaged or

(9) Sod: After the sod has been laid, tamped and top

injured, they shall be treated or replaced as directed and in compliance with the Specifications at no additional cost. No work shall be done within or over planting areas or adjacent to plants without proper (11) Keep sidewalks, curbs and gutters, driveways, parking areas, streets, terraces, decks, and pavers free of

plant cuttings, debris and stains.

D. Material rejected during the course of construction shall be removed within 3 working days and replaced before an inspection for completion will be scheduled. Survival and Conditions: The Contractor shall be responsible for the proper maintenance and the survival and condition of all landscape items from the time a landscape item is

Replacement: Replacement of plant material shall be the

responsibility of the Contractor including the possible

replacement of plant material resulting from removal by thef


or vandalism or acts of negligence on the part of others. All plant material shall be alive and in good growing

condition for each specific kind of plant at the time of


. Rating: The rating of plant material according to Florida Grades and Standards shall be equal to or better than called for on the Plans and in these Specifications at the time of


PLANTING DETAILS



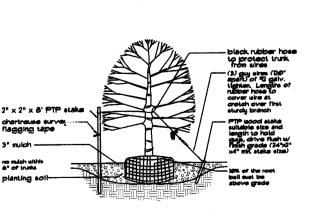

NOTE: Stake all trees up to 2" cal. ● 2 per tree. Guy all trees larger than 2" cal. Trees

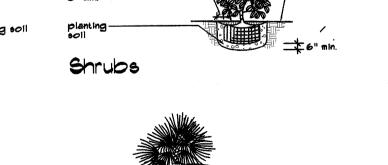

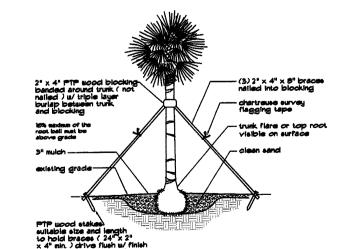

GENERAL NOTES


S. ALL LANDSCAPED AREAS TO RECEIVE 150% IRRIGATION COVERAGE BY AUTOMATIC, UNDERGROUND SPRINKLER SYSTEM EQUIPPED WITH A 4. QUANTITIES ON PLANT MATERIALS ARE FOR CONVENIENCE ONLY.
LANDSCAPE CONTRACTOR IS RESPONSIBLE FOR ALL PLANTS SHOWN
ON PLANTING PLANS, WHEN DISCREPANCIES OCCUR BETWEEN PLANT
LIST AND PLANTING PLANS, THE PLANS ARE TO OVERRIDE THE PLANT
LIST IN ALL CASES, SOD QUANTITY IS TO BE DETERMINED BY

ALL GROUNDCOVER BEDS TO ABUT PARKING, BUILDING, SIDEWALKS, ETC., IN A PERPENDICULAR LINE.

IO. ALL PLANT MATERIAL TO BE BACKFILLED WITH 50% CLEAN MICK AND 50% SAND AND BE FERTILE, AND FRIABLE. 11. GROUNDCOVER AND SHRUBS TO BE LAID OUT IN A UNIFORM AND

NOT TO SCALE

sheet:

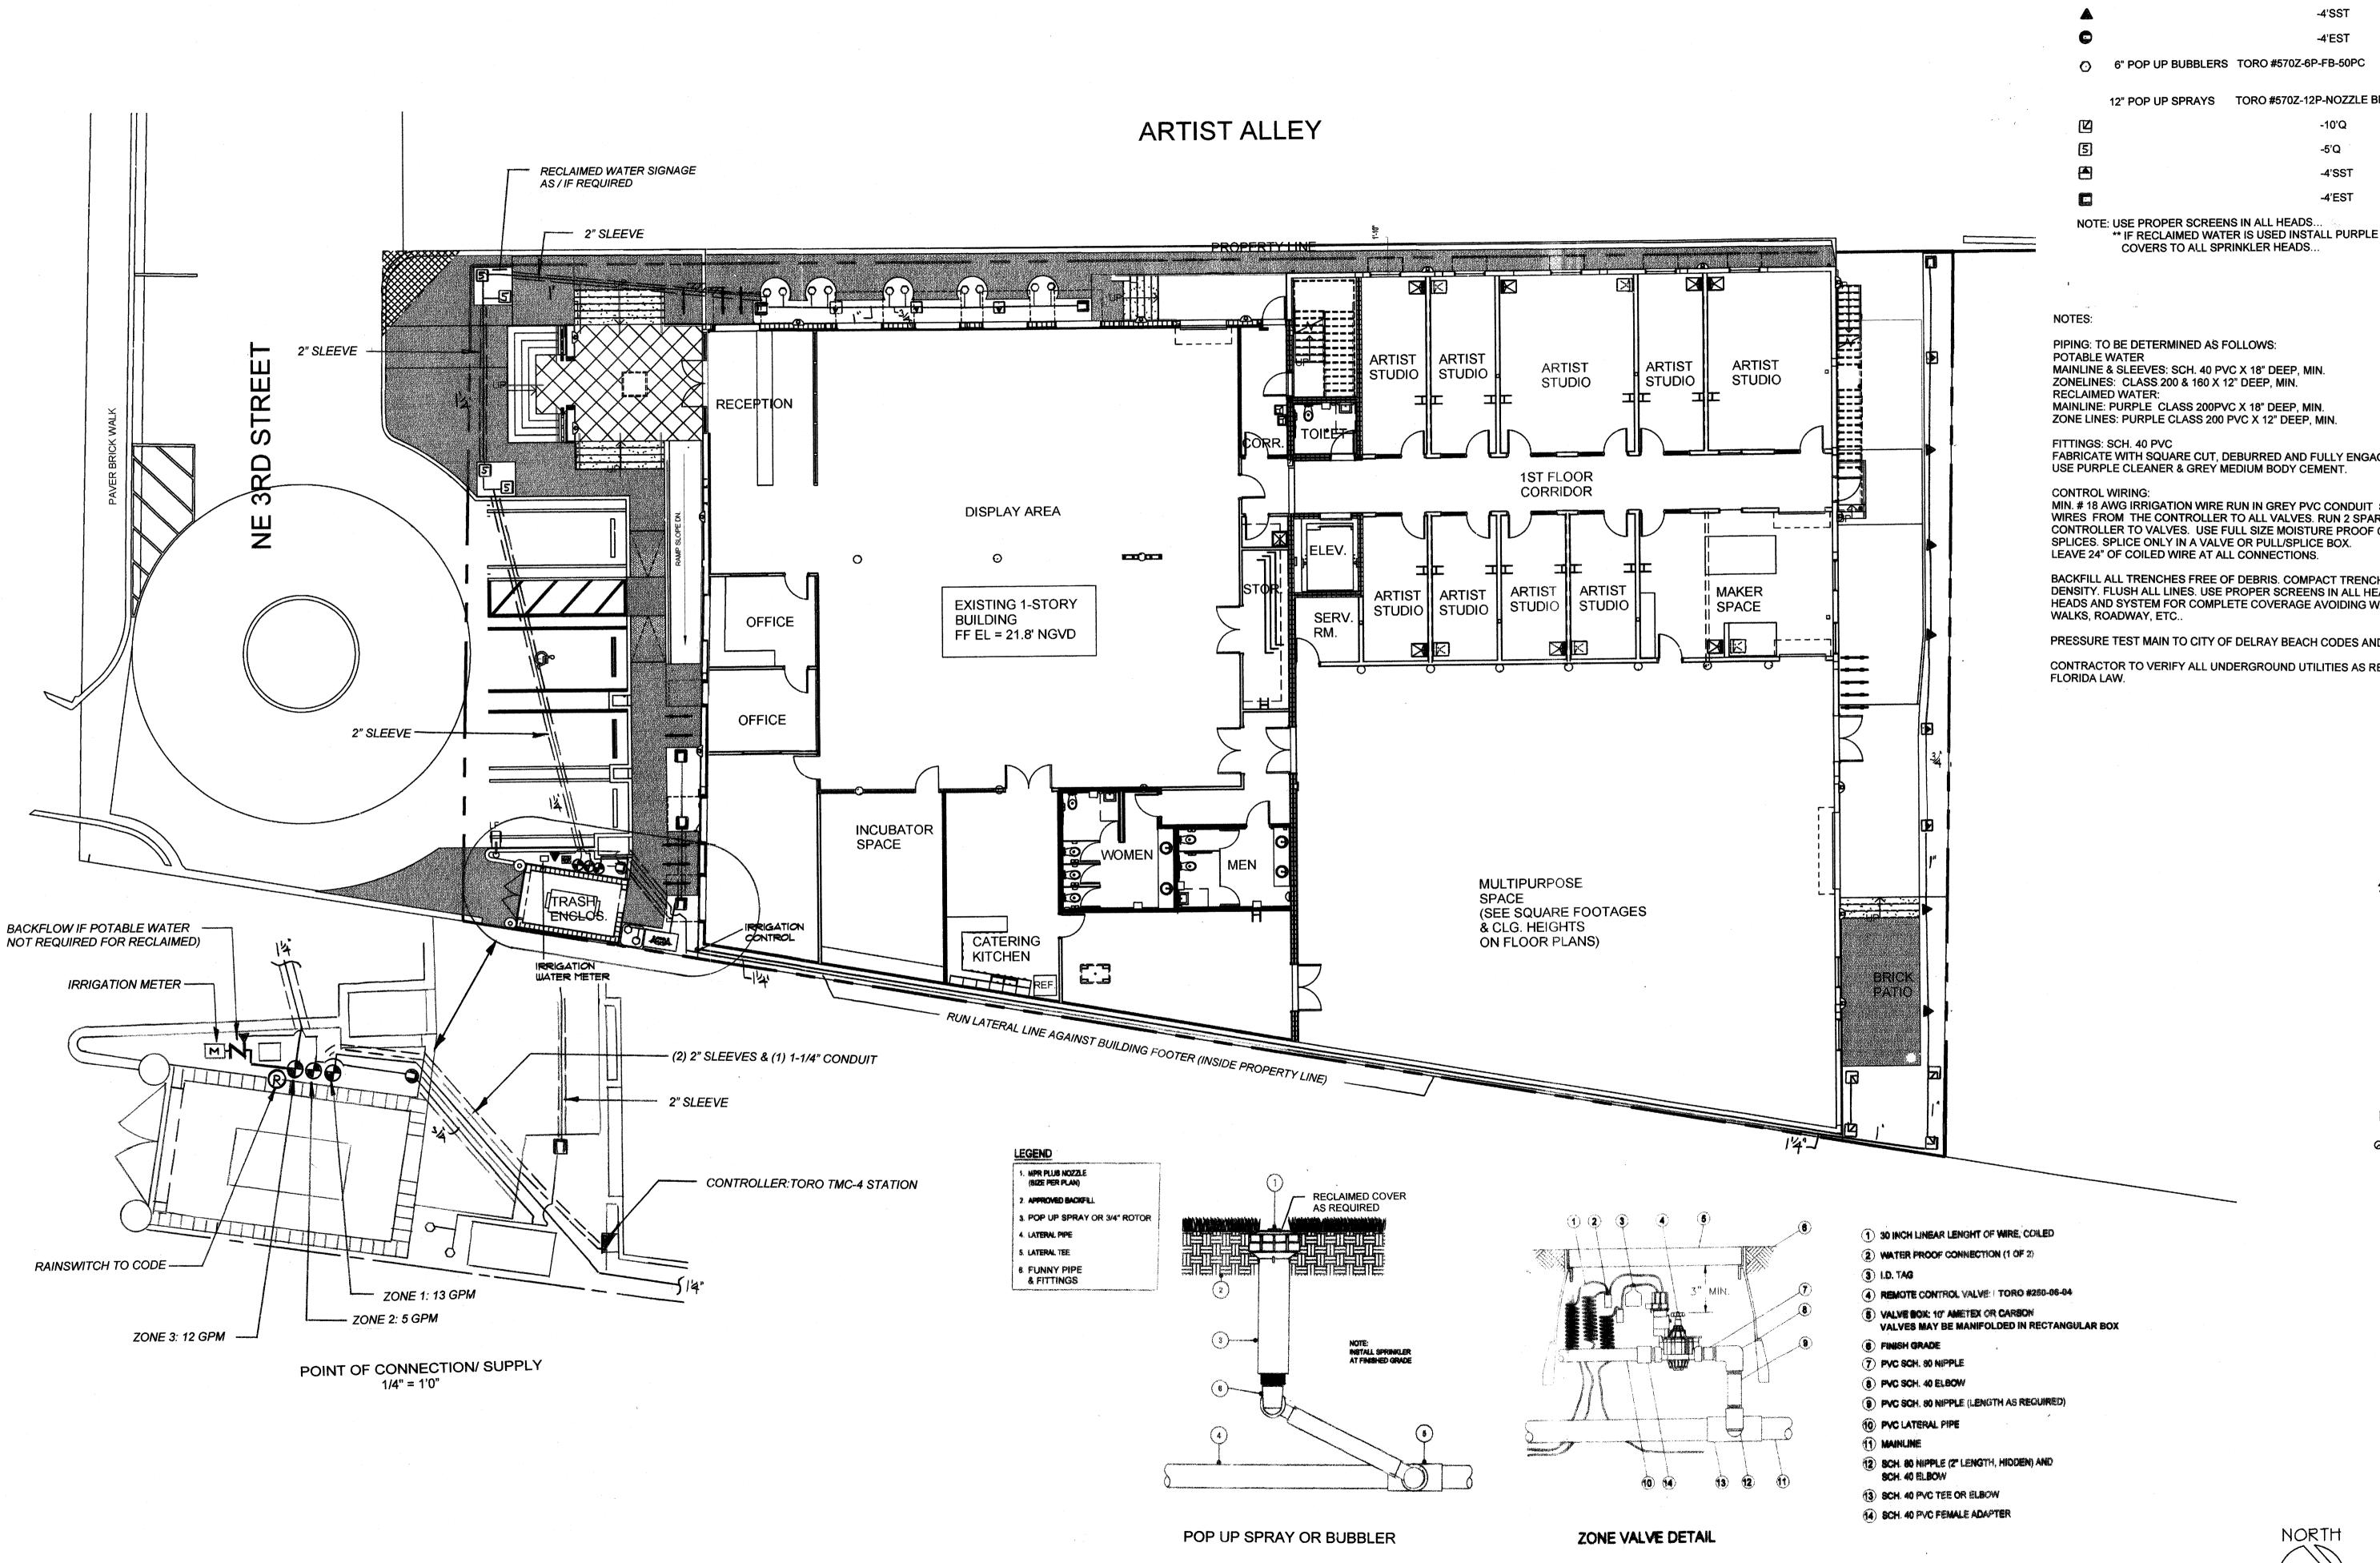

SPRINKLER HEAD LEGEND QTY. MODEL \*\* SYM. TYPE 6" POP UP SPRAYS TORO #570Z-6P-NOZZLE BELOW 12" POP UP SPRAYS TORO #570Z-12P-NOZZLE BELOW 20 \*\* IF RECLAIMED WATER IS USED INSTALL PURPLE NP FABRICATE WITH SQUARE CUT, DEBURRED AND FULLY ENGAGED JOINTS. USE PURPLE CLEANER & GREY MEDIUM BODY CEMENT. MIN. # 18 AWG IRRIGATION WIRE RUN IN GREY PVC CONDUIT SIZED FOR THE NUMBER OF WIRES FROM THE CONTROLLER TO ALL VALVES. RUN 2 SPARE WIRES WITH ALL MAINS CONTROLLER TO VALVES. USE FULL SIZE MOISTURE PROOF CONNECTORS FOR ALL BACKFILL ALL TRENCHES FREE OF DEBRIS. COMPACT TRENCHES TO ORIGINAL DENSITY. FLUSH ALL LINES. USE PROPER SCREENS IN ALL HEADS. ADJUST ALL HEADS AND SYSTEM FOR COMPLETE COVERAGE AVOIDING WATER ON WALLS, PRESSURE TEST MAIN TO CITY OF DELRAY BEACH CODES AND REGULATIONS CONTRACTOR TO VERIFY ALL UNDERGROUND UTILITIES AS REQUIRED BY project: Art Warehouse Renovation Delray Beach. Florida dave bodker landscape architecture/planning inc. 601 n. congress ave.. suite 105-a delray beach. florida 33445 561-276-6311 #LA0000999 sheet title: irrigation plan project number: 7814 date: 08-10-15 1" = 10" scale: drawn by: revisions:

sheet:



Asbestos Consulting • Radon Measurements • Lead Assessments • Indoor Air Quality Testing • Mold Investigations

Today's Date: 9/26/2012 Project Number: 20121618 Page 1 of 12

Prepared For:

Kristyn Cox - Goodwin Delray Beach Cra 20 North Swinton Avenue Delray Beach, Fl 33444 Job Site:

Arts Warehouse 250 Ne 3rd Ave & 313 Ne 3rd Street Delray Beach, Fl

Purchase Order 09-12-269

#### Asbestos Survey — Project Summary

Pursuant to your request; ARS Environmental, Inc., has performed an Asbestos Building Survey on 9/21/2012 and limited to the above referenced location.

The **Interior/Exterior/Roof** of the above referenced location was visually inspected to identify building materials that may contain asbestos. Suspect materials were collected and samples sent to laboratory for analysis.

#### **Laboratory Results**

# Based On The Laboratory Analysis, No Asbestos Was Detected In Amounts Greater Than 1% In The Secured Bulk Samples.

It has been a pleasure working with you. Please call on us again.

Regards,

Alex Front

ARS Environmental, Inc.



(561) 243-7200 Fax: (561) 243-7221

1993			
ART	295	E 9-2-1	5

Permit Number	
• •	y directed, as stated in the State of Florida Statute Sections 553.71.7 and 553.79.5 (a), or as deemed the City of Delray Beach Building Official, to retain a professional engineer or architect as a Special refollowing Special Inspections checked below:
<b>N P</b> 1.	Verify that all soil conditions have been certified/soil treatment certification.
N/A 2.	Verify that all setbacks have been certified.
3.	Make visual inspection of all components which cannot be inspected after fabrication.
4.	All steel inspected prior to concrete placement.
<b>N/A</b> 5.	Verify that shoring and re-shoring has been certified and to check that shoring is safe.
<b>A)A</b> 6.	Be present and monitor all concrete placement.
7.	To inspect all structural components of buildings such as, but not limited to:  a. Footer or piling  b. Slabs – on grade or below or above grade  c. Beams and columns (all structures)  d. All structural walls and non- structural walls  e. Fire resistive ratings for:  f. Floor and Roof trusses  g. Sheathing
8.	Special Inspector is required to make written reports weekly to the Building Official.
<b>P/A</b> 9.	Special Inspector is responsible for all job safety requirements as per the 2014 Florida Building Code to include the required liability insurance of \$500K (see L.D.R. 7.1.6 (B) ).
10.	Other: MISC INSPECTION AT OUR DISCRETION
NA 11.	Flood Elevation above MSL-NGVD.

The Special Inspector shall be responsible for compliance with this Code and shall submit progress reports and inspection reports to the Building Official. The assignment of a Special Inspector does not relieve the contractor from calling in for inspections to the City's Building Division and having City inspectors look at work. At the completion of the construction work on this project, the Special Inspector shall submit a Certificate of Compliance to the Building Official, stating that the work was done in compliance with this Code and in accordance with the approved plan or plans; and his duties shall end with the submission of such certificate. Final inspection shall be made by the Building Official before a Certificate of Occupancy is issued. A copy of this document must be submitted to the Building Official, signed and sealed prior to the building permit being issued.

Building Official Page 1 of 3 Special Inspector

#### **Preconstruction Affidavit**

9-2-15 2013

I, ROBERT J SELINSKY	, hereby swear that I am a (professional
qualification) <b>PE</b>	, therefore qualified to be a special
inspector for (name of building or project) ART CURE	· ·
under Florida Statute 553,79(5)(b), which requires that a speci	ial inspector be a person certified, licensed or
registered under Florida Statute, Chapter 471 as an engineer or F	Florida Statute, Chapter 481 as an architect and
qualified by the State Board of Building Codes and Standards.	

I further declare that I have adequate knowledge and training to inspect, determine and evaluate the structural components of the threshold building for safety and to verify in accordance with the structural inspection plans that they comply with permitted documents as well as shoring and re-shoring plans. I also state that I am not an employee of the general contractor nor any subcontractor and neither are any special inspectors working under my direction.

I agree to be present, or to have a representative under any supervision and direction qualified to make inspections on my behalf present, in conformity with the structural inspection plan and as-needed for determining compliance with shoring and re-shoring plans, to conduct required inspections, and to keep a written report of the inspection. The report shall set forth in detail any lack of compliance with plans, specifications, or applicable Minimum Building Codes. I agree to file reports in accordance with the directions of the Building Official. I understand that I shall be permitted to send a duly authorized representative to the job site to perform the necessary inspection provided that all written reports shall be prepared and bear my seal and that such written reports will be submitted to the Building Official.

I understand that I will be required to file a second affidavit at the completion of the project, which shall state that I was present and inspected all, or in some cases certain enumerated, structural components of the building as required by the structural inspection plan and shoring and re-shoring plans and deem them to be safe and find that the materials and workmanship comply fully with the plans, specifications and applicable Minimum Building Codes.

I understand that my affidavit shall be relied upon completely by the City of Delray Beach in using a Certificate of Occupancy.

If my (our) employment as a special inspector on this project terminates prior to completion for any reason, I agree to turn over to the Building Department a copy of my written reports on whatever structural components I have inspected or supervised the inspection of, up to the time of my termination.

I understand that the City of Delray Beach, Florida has no obligation to compensate me for my services as a special inspector, or to determine the amount of my compensation. I also understand that I am neither an employee nor an agent of the City.

I have in force at this time professional liability insurance in an amount not less than \$500,000 to cover all liability arising from my (our) employment and duties as a special inspector on this project. I agree to hold harmless, save, indemnify and defend the City of Delray Beach from all liability arising out of my obligations, actions, failure to act and employment on this project.

Date: 9-2-

No 49952

Page 2 of 3

Special Inspector

Building Official

9-2-15 3 0 p 3

# Affidavit of Compliance (required for c.o.)

I, (name) ROBERT J SELINSKY	, being a
(professional qualification) PE	and
therefore, qualified under Florida Statute 553.79 to be a special inspector for	the purposes of
inspecting the structural components of the threshold building pursuant to	o the structural
inspection plan on file with the accepted by the Building Department and the	shoring and re-
shoring plans, which have been accepted by the Building Department and here	by swear that I,
or my duly authorized representative have been present during the construction	of and inspected
the structural components of this building as required by the structural insp	ection plan and
certify that the materials and workmanship of all such components have been sa	ifely constructed
and comply fully with permitted documents and applicable Building Codes.	

Date: 9-2-15 IIIIOR CENS. Building Official

No 49952

STATE OF

ORIDACINE.

Permit Number

The First Ever <u>Thermostatic</u> Temperature Controlled Heater With Code Compliant Integrated Mixing Valve





# Stay Ahead of Plumbing Codes with AccuMix from Eemax

**Confused by plumbing codes?** Over time, plumbing codes have changed and what may have worked before, might not work with new water heaters on the market. Simply buying a mixing valve and plumbing it into an existing water heater doesn't always meet the latest codes.

#### Knowing the Code

Designated as an American National Standard, the Uniform Plumbing Code (UPC) is a model code developed by the International Association of Plumbing and Mechanical Officials (IAPMO). It governs the installation and inspection of plumbing systems as a means of promoting the public's health, safety, and welfare. The UPC is designed to provide consumers with safe and sanitary plumbing systems while, at the same time, allowing latitude for innovation and new technologies.

**ASSE 1070-2004** is a standard that applies to mechanical mixing valves to ensure that they comply with UPC 413.1. It states: "Water Temperature Limiting Devices shall control & limit the water temperature to fittings for sinks, lavatories, or bathtubs and are intended to reduce the risk of scalding. They are intended to supply tempered water to plumbing fixture ittings, or be integral with plumbing fixture fittings supplying tempered water. The device shall be equipped with an adjustable and lockable means to limit the setting towards the hot position."

**Section 413.1** of the Uniform Plumbing Code is entitled "Limitation of Hot Water Temperature for Public Lavatories" – which states – "Hot water delivered for public-use lavatories shall be limited to a maximum temperature of 120°F. The water heater thermostat shall not be considered a control for meeting this provision." UPC 413.1, when used as the basis for the municipal building code, is the actual standard which must be met from a regulatory standpoint. In contrast, ASSE 1070-2004 specifies the performance of mechanical mixing valves when used as active thermal limiters in attempting to satisfy UPC 413.1. The mixing valve serves as a safety mechanism in a public lavatory to prevent the possibility of a scald. In essence, the mechanical mixing valve should be considered to be a cooling device, mixing enough cold water into a stream of hot water to lower the output at the tap to less than 120°F.

#### AccuMix: A Simple Solution

In order to meet the provisions of UPC 413.1, Eemax has added an ASSE 1070-2004 code compliant mechanical mixing valve to their AccuMix Series of Electric Tankless Water Heaters. The new AccuMix heaters feature an internally calibrated valve and circuit board which work together to prevent issues during the installation process. With AccuMix, the temperature of the heater is factory pre-set to 105°F for hand-washing applications and must not be adjusted. Tampering with the preset temperature will not only void the warranty, it may cause a loss of compliance to UPC 413.1.

AccuMix is for hand-washing applications only. For constant and safe water output, AccuMix is the ideal solution in single and multi-lavatory applications in stores, restaurants, medical environments, office buildings, factories, and more. Commercial buildings need to meet the latest plumbing codes, however, not all locations are currently being policed for the code. As time goes by, the code will become more enforced. AccuMix features internal set-up with fewer connections and simplified fittings which cuts down on installation time. Leak Tested – Self Contained – Simplified Plumbing. AccuMix from Eemax makes it affordably possible to stay ahead of plumbing codes.











The First Ever <u>Thermostatic</u> Temperature Controlled Heater With Code Compliant Integrated Mixing Valve

AccyMix

**MEET THE CODE WITH CONFIDENCE & SIMPLICITY!** 

# electric tankless water heater


AN ENERGY-EFFICIENT, INSTANT WATER HEATER THAT HEATS ONLY THE WATER YOU USE!

heater contains an ASSE approved thermostatic mixing valve to prevent the risk of scalding!

#### **FEATURES:**

- Eemax Exclusive Turnkey Solution
- Meets UPC 413.1 Requirements When Properly Installed
- No Scalding or Temperature Spikes
- Factory Calibrated Mixing Valve and Thermostatic Temperature Control Board for Accuracy
- Product Performance Test Indicator Light
- 99% Energy Efficient Reducing Your Utility Costs
- Quick and Easy Installation Integrated valve solution
- On-Demand Hot Water -- Never run out
- Factory Temperature Set to 105°F
- Quick Temperature Ramp Up Time
- Compatible with All Sensor and Non-Sensor Faucets
- ADA Compliant 点
- Unit Measures: 13.5" H x 5" W x 4" D



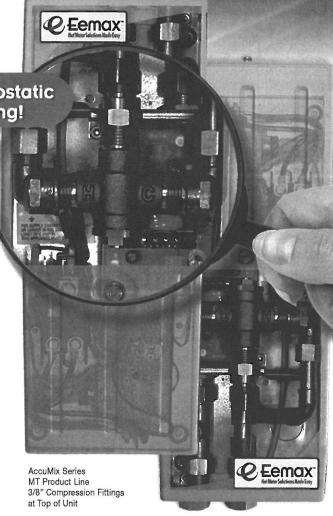

AccuMix Series MB Product Line 1/2" Compression Fittings at Bottom of Unit











# The First Ever <u>Thermostatic</u> Temperature Controlled Heater With Code Compliant Integrated Mixing Valve





ADLIACE POWER WAY FEBRUAR SUPPLY CHECKING RECOMMENDED WIFE COMPRESSION FITTINGS SERVER 1,0 CERN FT. 1,5 CERN FT.

AND THE POWER WAY THE PROPERTY OF SUPPLY CHECKING WHEN COMPRESSION FITTINGS. THE PROPERTY OF SUPPLY SUPPL

MT004120T	120	3.5	1	29A	10 AWG	0.3	3/8"	Тор	48°	<del></del>	
MT005240T	240*	4.8	1	20A	12 AWG	0.3	3/8"	Тор	64°	31°	21
MT007240T	240*	6.5	2	27A	10 AWG	0.3	3/8"	Тор	†	44°	30
MT010240T	240*	9.5	3	40A	8 AWG	0.3	3/8"	Тор	†	65°	43
MT008277T	277	8.0	2	29A	10 AWG	0.3	3/8"	Тор	t	55°	36
MT010277T	277	10.0	3	40A	8 AWG	0.3	3/8"	Тор	†	68°	46



MT VERSION


MB PRODUCT L											
MB004120T	120	3.5	1	29A	10 AWG	0.3	1/2"	Bottom	48°	24°	16
MB005240T	240*	4.8	1	20A	12 AWG	0.3	1/2"	Bottom	64°	31°	21
MB007240T	240*	6.5	2	27A	10 AWG	0.3	1/2"	Bottom	t	44°	30
MB010240T	240*	9.5	3	40A	8 AWG	0.3	1/2"	Bottom	†	65°	43
MB012240T	240*	11.5	4	50A	6 AWG	0.3	1/2"	Bottom	†	79°	52
MB008277T	277	8.0	2	29A	10 AWG	0.3	1/2"	Bottom	†	55°	36
MB010277T	277	10.0	3	40A	8 AWG	0.3	1/2"	Bottom	t	68°	46




MB VERSION

## ENERGY EFFICIENT & EASY TO INSTALL

For constant and safe water output, AccuMix eliminates the risk of scalding. AccuMix is the ideal hand washing solution for single and multi-lavatory applications in stores, restaurants, medical environments, office buildings, factories or any commercial building. It is the first ever thermostatic temperature controlled heater with a code compliant mechanical integrated mixing valve. This unit features internal piping with fewer connections and simplified fittings which cuts down on installation time. Now you can stay ahead of plumbing codes with the AccuMix Series from Eemax.

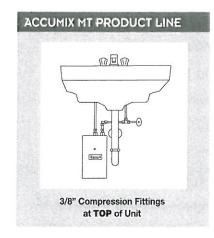

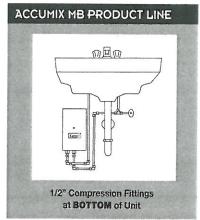



<sup>\*240</sup>V units can be used on 208V with 25% reduced temperature output. †Units are factory preset to not exceed 105°F no matter what the temperature rise is.